


PLAN VIEW

SCALE: 1" = 100'

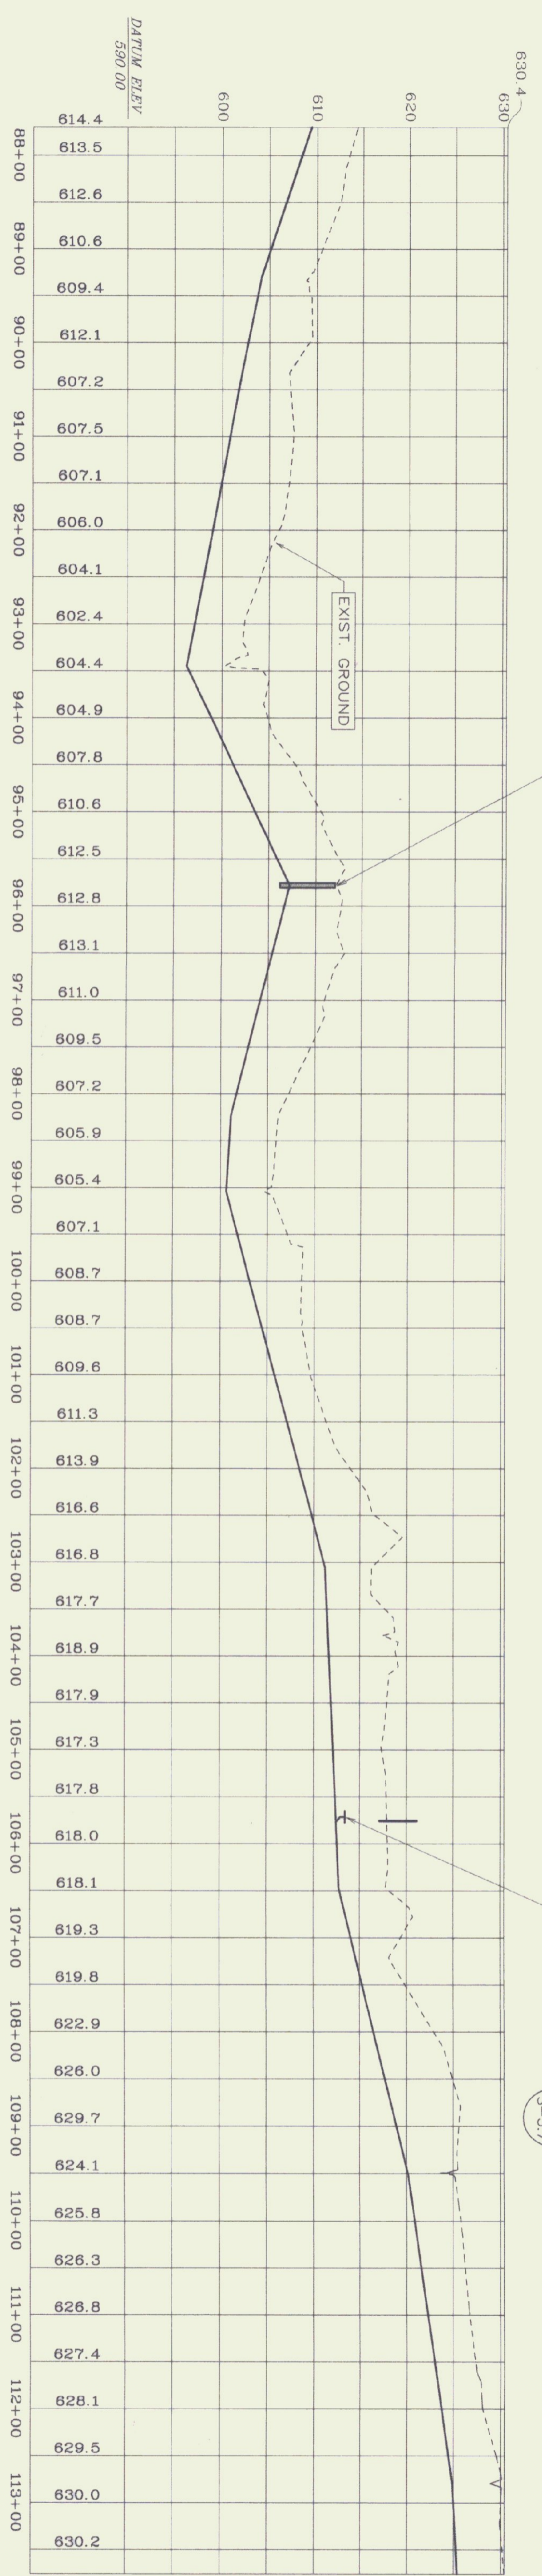

PROFILE


SCALE: 1" = 100' HORIZ.  
1" = 10' VERT.

TEST PIT #	GENERAL SOIL TYPE	DEPTH TO LEDGE	GROUNDWATER
27	LOAM	NONE TO 72"	WATER @ 35"
28	LOAM	NONE TO 72"	SEEP @ 60"
29	SAND	NONE TO 76"	NONE
30	LOAM	NONE TO 72"	NONE
31	SAND	NONE TO 72"	SEEP @ 30"
32	LOAM	NONE TO 65"	NONE
33	SAND	NONE TO 70"	NONE
34	LOAM	NONE TO 74"	NONE
35	LOAM	NONE TO 72"	SEEP @ 44"
36	LOAM	NONE TO 70"	SEEP @ 45"

- NOTES:
- 1) TEST PIT DATA GATHERED IN THE SPRING OF 1998. GROUNDWATER CONDITIONS WILL VARY.
  - 2) PROVIDE A MINIMUM OF 48" OF COVER WHEN CROSSING SWALES AND 60" MINIMUM IN A TYPICAL RUN.
  - 3) WHERE STONE LINED DITCHES ARE DISTURBED, SALVAGE AND REPLACE EXISTING STONE AND RE-LINE DITCH TO MATCH EXISTING.
  - 4) SEE INSULATION OVER FORCE MAIN AT ALL WATERWAY CROSSINGS SEE DETAIL 12, SHEET S-1.

VALVE SCHEDULE

VALVE NO.	STATION	SEWAGE AIR RELEASE VALVE TYPE
8	95+75	SEWAGE AIR RELEASE VALVE

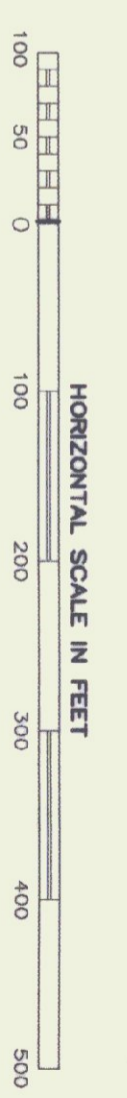

STATE OF VERMONT  
DEPARTMENT OF BUILDINGS  
AND GENERAL SERVICES  
AGENCY OF ADMINISTRATION  
MONTPELIER, VERMONT

GEORGIA INTERSTATE 89 REST AREAS  
NORTHBOUND AND SOUTHBOUND

DATE:	21 AUGUST 1998	SCALE:	1"=100'	REVISIONS:		DRAWING NAME:	PLAN AND PROFILE
DRAWN BY:	WHP/BD	PROJECT NO.:	97041			DRAWING NO.:	S-3.3
CHECKED BY:	PHC						