


PLAN VIEW
SCALE: 1" = 100'

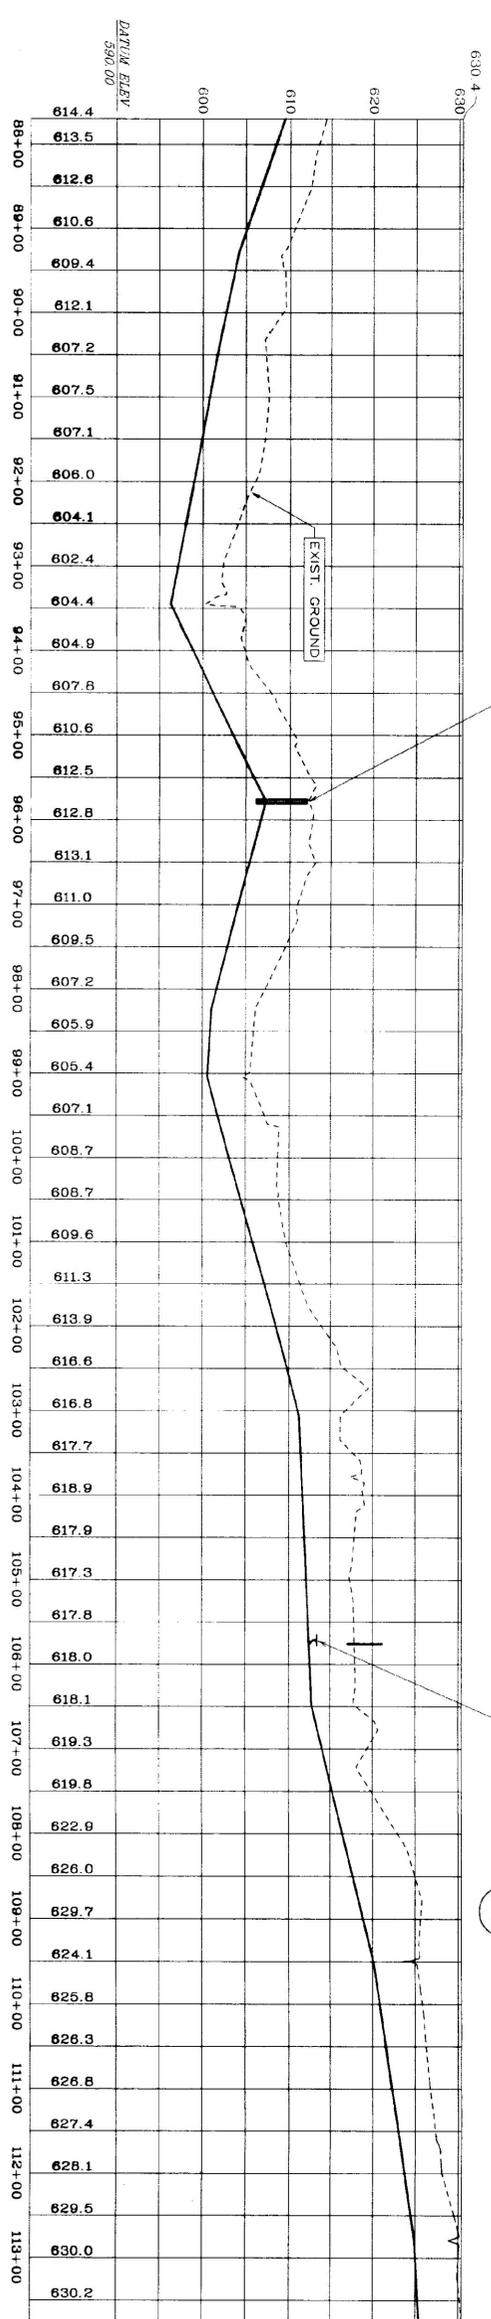


TEST PIT #	GENERAL SOIL TYPE	DEPTH TO LEDGE	GROUNDWATER
27	LOAM	NONE TO 72"	WATER @ 36"
28	LOAM	NONE TO 72"	SEEP @ 60"
29	SAND	NONE TO 76"	NONE
30	LOAM	NONE TO 72"	SEEP @ 30"
31	SAND	NONE TO 72"	NONE
32	LOAM	NONE TO 65"	NONE
33	SAND	NONE TO 70"	NONE
34	SAND	NONE TO 74"	NONE
35	LOAM	NONE TO 72"	SEEP @ 64"
36	LOAM	NONE TO 70"	SEEP @ 65"

- NOTES:
1) PIT DATA GATHERED IN THE SPRING OF 1998. GROUNDWATER CONDITIONS WILL VARY.
2) PROVIDE A MINIMUM OF 48" OF COVER WHEN CROSSING SWALES AND 60" MINIMUM OVER ALL TYPICAL SOIL.
3) WHERE STONE LINED DITCHES ARE DISTURBED, SALVAGE AND REPLACE EXISTING STONE LINING. DITCHES TO MAINTAIN EXISTING.
4) USE 4" INSULATION OVER FORCE MAIN AT ALL WATERWAY CROSSINGS. SEE DETAIL 12, SHEET S-3.7

PIR O R I L L E
SCALE: 1" = 100' HORIZ.
1" = 10' VERT.

VALVE SCHEDULE

VALVE NO.	STATION	TYPE
8	95+75	SEWAGE AIR RELEASE VALVE

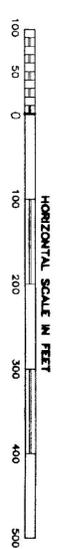

STATE OF VERMONT
DEPARTMENT OF BUILDINGS
AND GENERAL SERVICES
AGENCY OF ADMINISTRATION
MONTPELIER, VERMONT

GEORGIA INTERSTATE 89 REST AREAS
NORTHBOUND AND SOUTHBOUND

DATE: 21 AUGUST 1988	SCALE: 1"=400'	REVISIONS:	DRAWING TITLE: PLAN AND PROFILE
DRAWN BY: WHP/AD	PROJECT NO: 92041		DRAWING NO: S-3.3
CHECKED BY: PJC			