
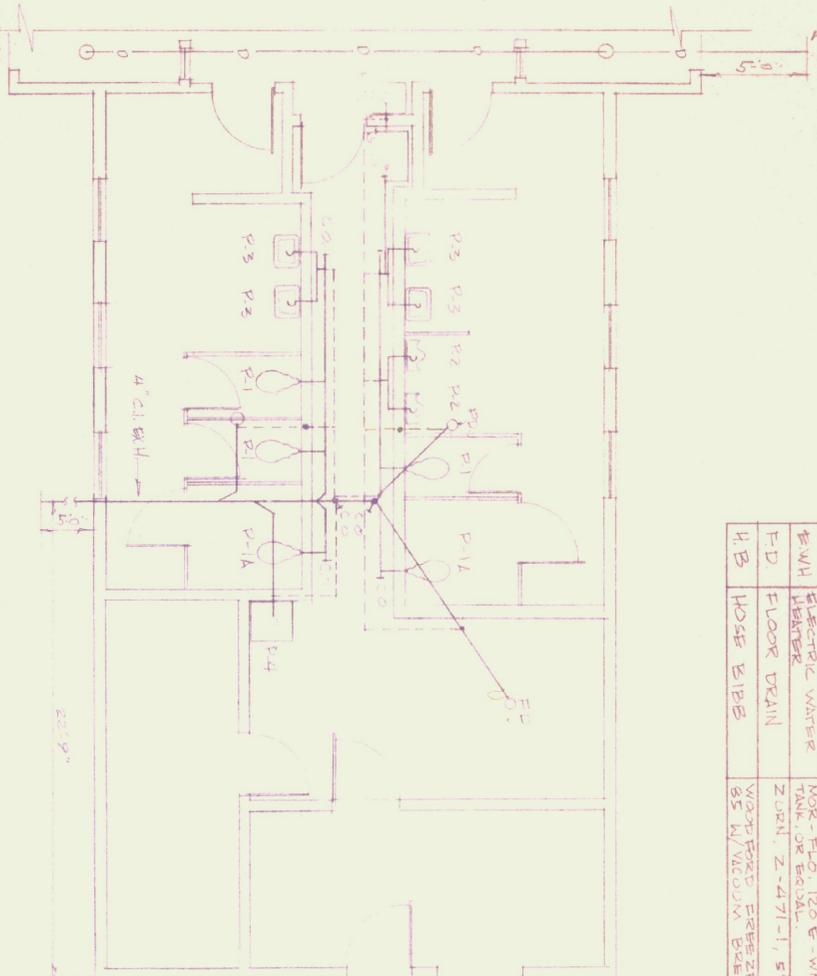


PLUMBING FIXTURE SCHEDULE

MARK	DESCRIPTION	MANUFACTURER & MODEL	Quantity	REMARKS
P-1	WATER CLOSET	MC BRONZE 1 1/2" FLUSH VALVE - 2 GALLEY WATER CLOSET	1/2 - 4 - 2	
P-1A	WANDICAP WATER CLOSET	WALBRON 1 1/2" FLUSH VALVE - 2 GALLEY WATER CLOSET	1/2 - 4 - 2	SEE TO BE COORDINATED WITH ELECTRICAL
P-2	URINAL	AMERICAN STANDARD 1/2" W/STAINLESS STEEL URINAL	3/4 - 2 - 1	REPAIRS TO BE MADE
P-3	LABATORY	AMERICAN STANDARD 1/2" W/STAINLESS STEEL URINAL	1/2 - 1/4 - 1	REPAIRS TO BE MADE
P-4	MOP RECEPTOR	24" X 24" X 6" FLOOR RECEPTOR	1/2 - 2 - 1	REPAIRS TO BE MADE
P-5	ELECTRIC WATER CLOSET	WALBRON 1 1/2" FLUSH VALVE - 2 GALLEY WATER CLOSET	1/2 - 2 - 1	REPAIRS TO BE MADE
P-6	PRESSURE TANK	X-TROL - SIZED TO PUMP & INSTALLATION	1/2 - 1 - 1	REPAIRS TO BE MADE
F-WH	ELECTRIC WATER HEATER	MOR. 120 E. WITH 4500 W. ELEMENT IN TOP 1/2 OF TANK OR EQUAL	1/2 - 1 - 1	REPAIRS TO BE MADE
F-D	FLOOR DRAIN	ZORN, Z-471-1, 5" STRAINER	1/2 - 2 - 1	REPAIRS TO BE MADE
H-B	HOSE RIBB	WOT PORT. 5000 PSI. 1/2" DIA. 10' LONG	1/2 - 1 - 1	REPAIRS TO BE MADE

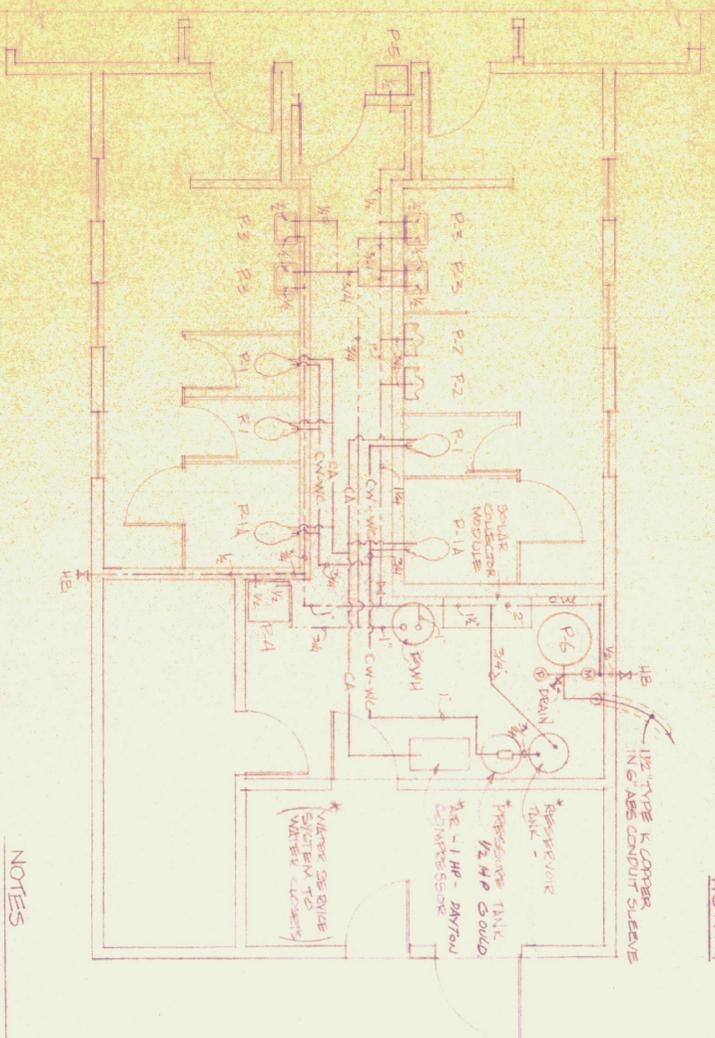

LEGEND

—	COLD WATER PIPING
—	HOT WATER PIPING
—	COLD WATER FOR WATER CLOSETS
—	COMPRESSED AIR
—	VENT PIPING
—	GATE VALVE
—	CHECK VALVE
—	FLOOR DRAIN
—	CLEAN OUT
—	ELECTRIC WATER HEATER
—	HOSE BIBB
—	SLAB PENETRATION
—	WATER MEMBER
—	PRESSURE GAUGE

NOTES

BUILDING WATER SUPPLY SYSTEM





1. RAIN GUTTER - 1/2" DIA. 1" SPACED 24" ON CENTER
2. SET GUTTER IN EXTERIOR DRIVEN WELL
3. MEN'S, WOMEN'S, PARKING HOUSE, OR EQUAL
4. 2" GALV. STEEL PIPING - ASTM A152
5. TUBED FITTING NPT IN WELL
6. 3" PIPES TO BUILDING 1/2" TYPE K COPPER IN 6" ABS SLEEVE
7. ELECTRICAL WIRE - 3#6
8. PRESSURE TANK - X-TROL VIX-251
9. HOYT MEDALIST OR EQUAL
10. WELL CAP - WATER TIGHT VENTED

PLAN

1/4" = 1'-0"

NOTES

1. HOT AND COLD WATER LINES TO BE TYPE L HARD DRAWN COPPER ABOVE GRADE - TYPE K COPPER BELOW GRADE
2. DRAIN AND VENTS ABOVE GRADE TO BE DWV COPPER
3. DRAIN BELOW GRADE TO BE CAST IRON LEADED JOINTS
4. COLD WATER LINES TO BE INSULATED W/STANDARD COLD WATER PIPE INSULATION
5. WATER GATE VALVES TO BE INSTALLED AT ALL FIXTURES, VALVES TO BE JERKING OR APPROVED EQUAL
6. AIR LINES TO BE TYPE L SOFT DRAWN COPPER
7. URINAL FLUSH VALVE TO BE SPRING LOADED MANUALLY OPERATED
8. SUPPLY AND INSTALL VALVE STOPS ON SUPPLY LINES TO FIXTURES (INCLUDES AIR LINES TO TOILET)

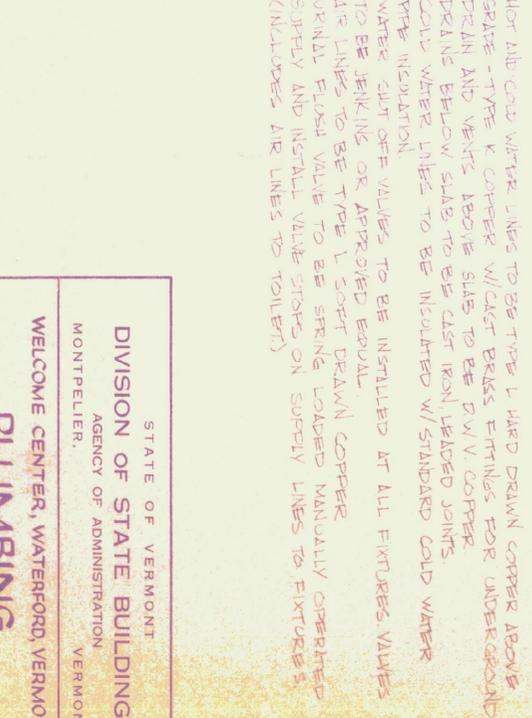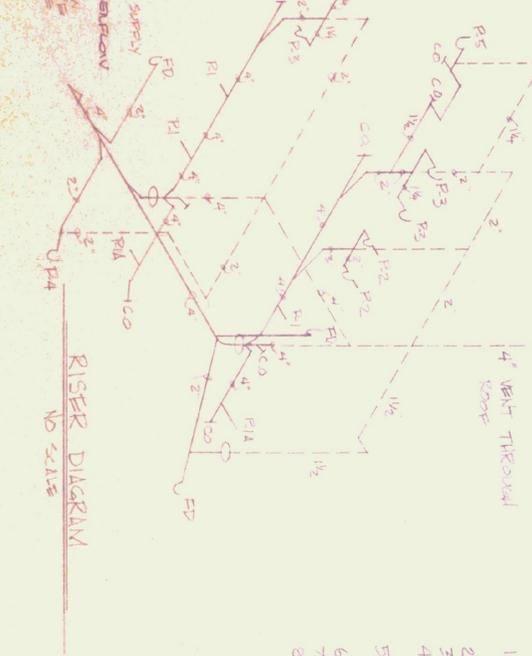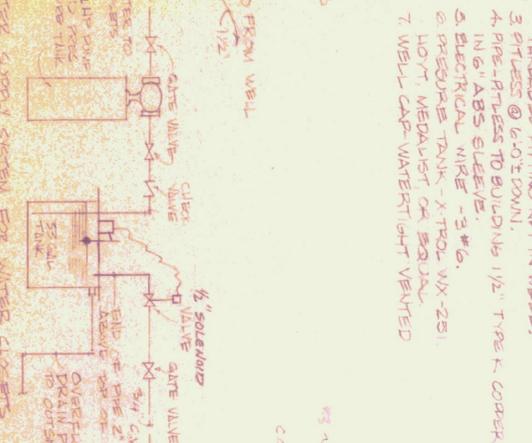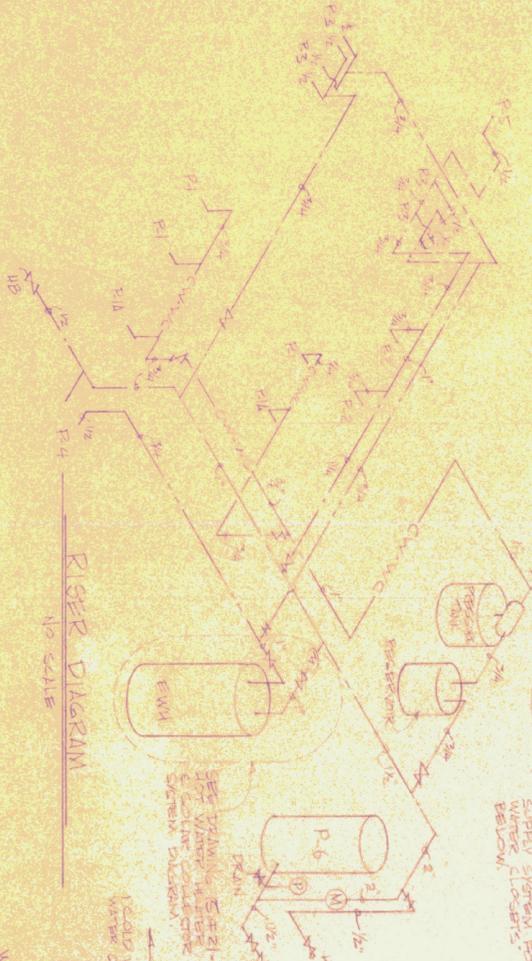

HOT AND COLD WATER

SANITARY WASTE AND VENT

STATE OF VERMONT  
 DIVISION OF STATE BUILDINGS  
 AGENCY OF ADMINISTRATION  
 MONTPELIER, VERMONT

WELCOME CENTER, WATERFORD, VERMONT

PLUMBING PLAN

IR 93-1(5)

DATE: APRIL 16, 1982  
 DRAWN BY: REMICK  
 SCALE: AS SHOWN  
 APPROVED BY: REMICK

REVISIONS:

DWG. NO. P-1  
 12 OF 21