
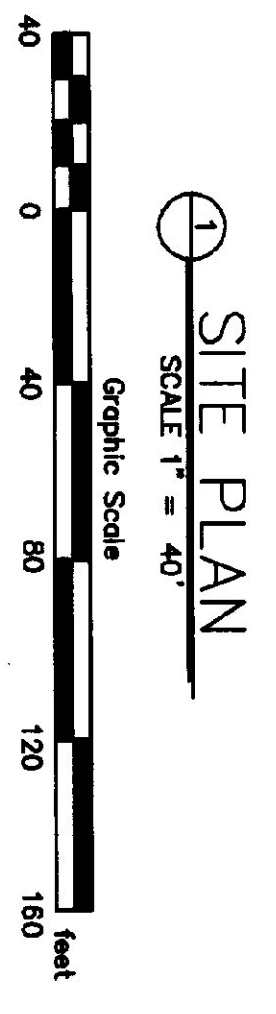


NO.	STATION	TYPE	RIM	INVERT (IN)	INVERT (OUT)	REMARKS
CB1	10+72.81	RM	596.36	596.62	596.78	
CB2	10+72.81	RM	596.36	596.62	596.46	
CB3	10+72.81	RM	596.36	596.13	595.95	
CB4	11+87.81	RM	594.28	599.25	599.25	
CB5	11+87.81	RM	594.28	599.25	599.57	
CB6	12+77.11	RM	593.80	597.80	597.80	
CB7	12+77.11	RM	593.80	597.80	597.83	
CB8	12+77.11	RM	593.80	597.80	596.87	
CB9	12+77.11	RM	593.80	596.29	596.12	
CB10	10+400.11	RM	601.78	595.96	595.80	
CB11	10+400.11	RM	601.78	596.29	596.29	
CB12	10+400.11	RM	602.50	596.62	596.62	
CB13	10+400.11	RM	604.00	596.45	596.45	
CB14	10+400.11	RM	602.03	595.47	595.47	
CB15	10+400.11	RM	595.23	590.46	590.46	EXISTING TO BE REMOVED
CB16	10+400.11	RM	600.69	596.79	596.79	EXISTING TO BE REMOVED
CB17	10+400.11	RM	598.48	595.09	595.09	EXISTING TO BE REMOVED
CB18	10+400.11	RM	595.80	597.80	597.80	EXISTING TO BE REMOVED
CB19	10+400.11	RM	597.80	598.12	598.12	EXISTING TO REMAIN
CB20	10+400.11	RM	598.30	598.25	598.25	NEW OVER EXIST. PIPE
Y01	10+400.11	RM	601.78	601.10	601.10	10' HOPE
Y02	10+400.11	RM	601.78	598.00	598.00	10' HOPE
Y03	10+400.11	RM	601.78	595.99	595.99	10' HOPE
Y04	10+400.11	RM	601.78	595.71	595.71	10' HOPE
Y05	10+400.11	RM	601.78	595.71	595.71	10' HOPE
Y06	10+400.11	RM	601.78	595.25	595.25	10' HOPE
Y07	10+400.11	RM	601.78	595.00	595.00	10' HOPE

\* SEE LANDSCAPE PLANS FOR YARD DRAIN RIM ELEVATIONS  
 † CATCH BASIN TO BECOME DRAINAGE MANHOLE RAISE RIM ELEVATION TO 604.75 WITH NEW SOLID COVER LABELED "STORM".

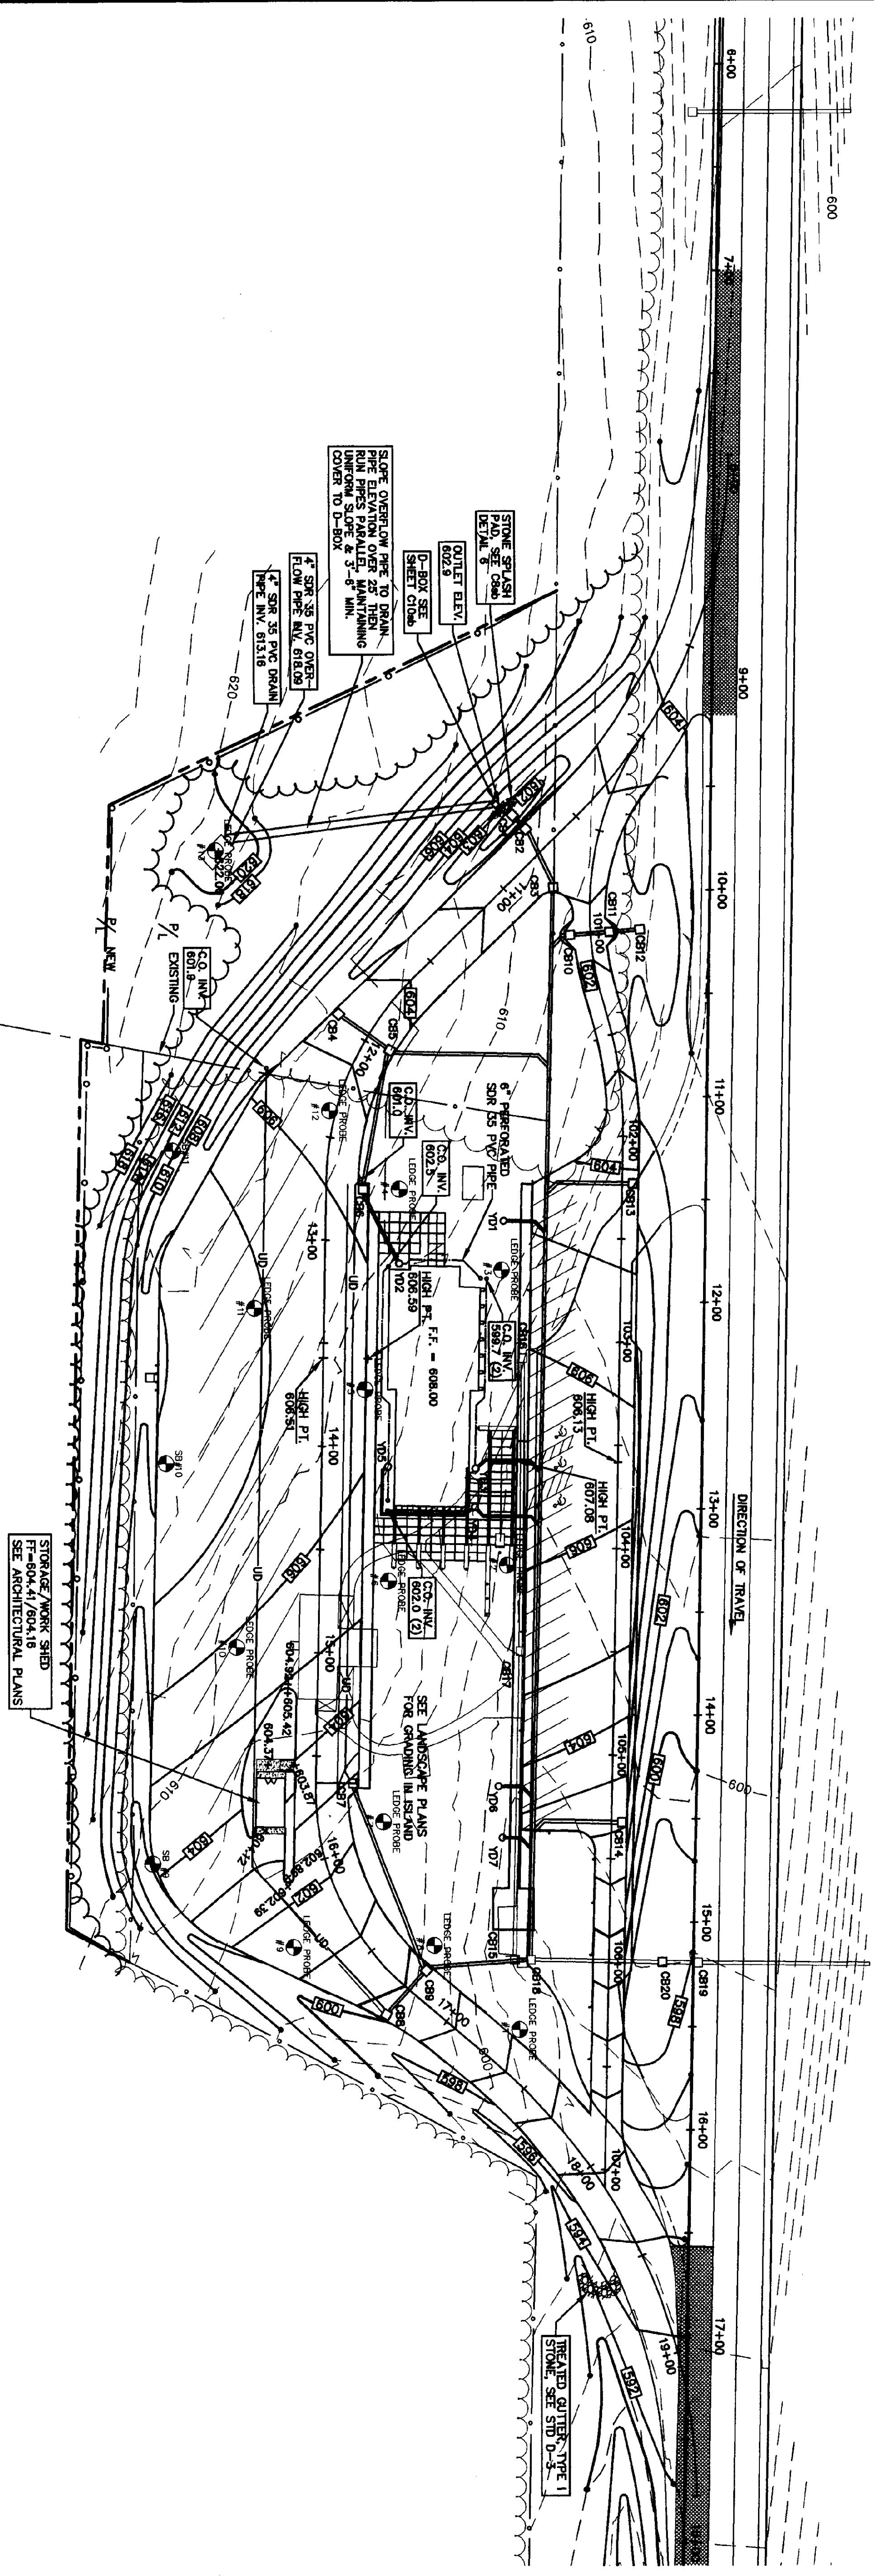

**SITE PLAN**  
 SCALE 1" = 40'

- NOTES:
1. CONTRACTOR SHALL BE RESPONSIBLE FOR DETERMINATION OF EXTENT OF LEDGE REMOVAL REQUIRED AND FOR THE ADHERENCE TO ALL FEDERAL, STATE & LOCAL LAWS, REGULATIONS & ORDINANCES REGARDING LEDGE REMOVAL METHODS & PROCEDURES. A LEDGE REMOVAL PLAN SHALL BE SUBMITTED TO THE OWNER FOR APPROVAL PRIOR TO ANY LEDGE REMOVAL OPERATION.
  2. CONTRACTOR SHALL BE RESPONSIBLE FOR REMOVAL & PROPER DISPOSAL OF ALL EXISTING BUILDINGS & FEATURES NOT TO BE RETAINED. SEE ELECTRICAL & MECHANICAL PLANS REGARDING REMOVAL & DISPOSAL OF EXISTING UTILITIES.
  3. CONTRACTOR SHALL SUBMIT A WRITTEN PLAN TO THE VAOT AND THE OWNER REGARDING THE CONTROL OF DUST AND DEBRIS. NO DUST, MUD OR DEBRIS SHALL BE ALLOWED TO CONTAMINATE THE TRAVEL LANES.

**C4sb**  
 DRAWN: COE  
 CHECKED: PD  
 SCALE: 1" = 40'  
 DATE: 01/16/01  
 JOB NO.: 93114  
 SHEET: 19 OF 19 SHEETS

**INTERSTATE 89 SOUTHBOUND  
 WILLISTON INFORMATION CENTER  
 GRADING PLAN**  
 PROJECT # IM-BLDG(4) VERMONT



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