

TYPICAL HANDHOLE SECTION
NOT TO SCALE


1. REFER TO RENOVING DETAIL FOR CONDUIT RUNS

KEYED ELECTRICAL SITE NOTES: (PLAN SYMBOL)

- 1 DISCONNECT AND REMOVE EXISTING LIGHT POLES. REMOVE ALL EXISTING WIRING AND CONDUIT. COORDINATE WITH GENERAL CONTRACTOR TO REMOVE EXISTING BASES.
- 2 DISCONNECT AND REMOVE BACK TO SOURCE ALL 120VAC AND TELEPHONE WIRING SERVING PUBLIC TELEPHONE. COORDINATE REMOVAL OF TELEPHONE AND KIOSK WITH TELEPHONE UTILITY.
- 3 COORDINATE WITH POWER AND TELEPHONE UTILITIES FOR DISCONNECTION OF THEIR SERVICES WIRING TO BUILDING.
- 4 COORDINATE WITH POWER AND TELEPHONE UTILITIES FOR REMOVAL OF EXISTING OVERHEAD UTILITY LINE. ASSOCIATED POLES AND HARDWARE TO BE REMOVED. COORDINATE WITH POWER AND TELEPHONE UTILITIES FOR ONE-LINE DIAGRAM AND TELEPHONE SYSTEM RISES DIAGRAM FOR NEW WORK.
- 5 SERVICES SHALL BE ROUTED THROUGH HIGHWAY CROSSING SLEEVES FOR UNDERGROUND UTILITIES. THE FOLLOWING SLEEVES SHALL BE PROVIDED:
 - (a) TELEPHONE
 - (b) TELEPHONE
 - (c) TELEPHONE
 - (d) FUTURE (CAP EITHER END WATER TIGHT)
 - (e) FUTURE (CAP EITHER END WATER TIGHT)
 - (f) FUTURE (CAP EITHER END WATER TIGHT)
- 6 RECONNECT AND REMOVE EXISTING WIRING SERVING WELDED BACK TO SOURCE. PROVIDE NEW POWER WIRING SERVING WELDED BACK TO BUILDING. SIZE AND TYPE TO MATCH EXISTING. FIELD VERIFY CONDITIONS. REFER TO DWG. E2 AND E4 FOR CONNECTIONS.
- 7 FUTURE SHALL BE MOUNTED SIX (6) FEET FROM EDGE OF SHOULDER TO CENTER OF CONCRETE BASE.




PARTIAL ELECTRICAL SITE PLAN - DECELERATION RAMP
SCALE: 1"=40'-0"

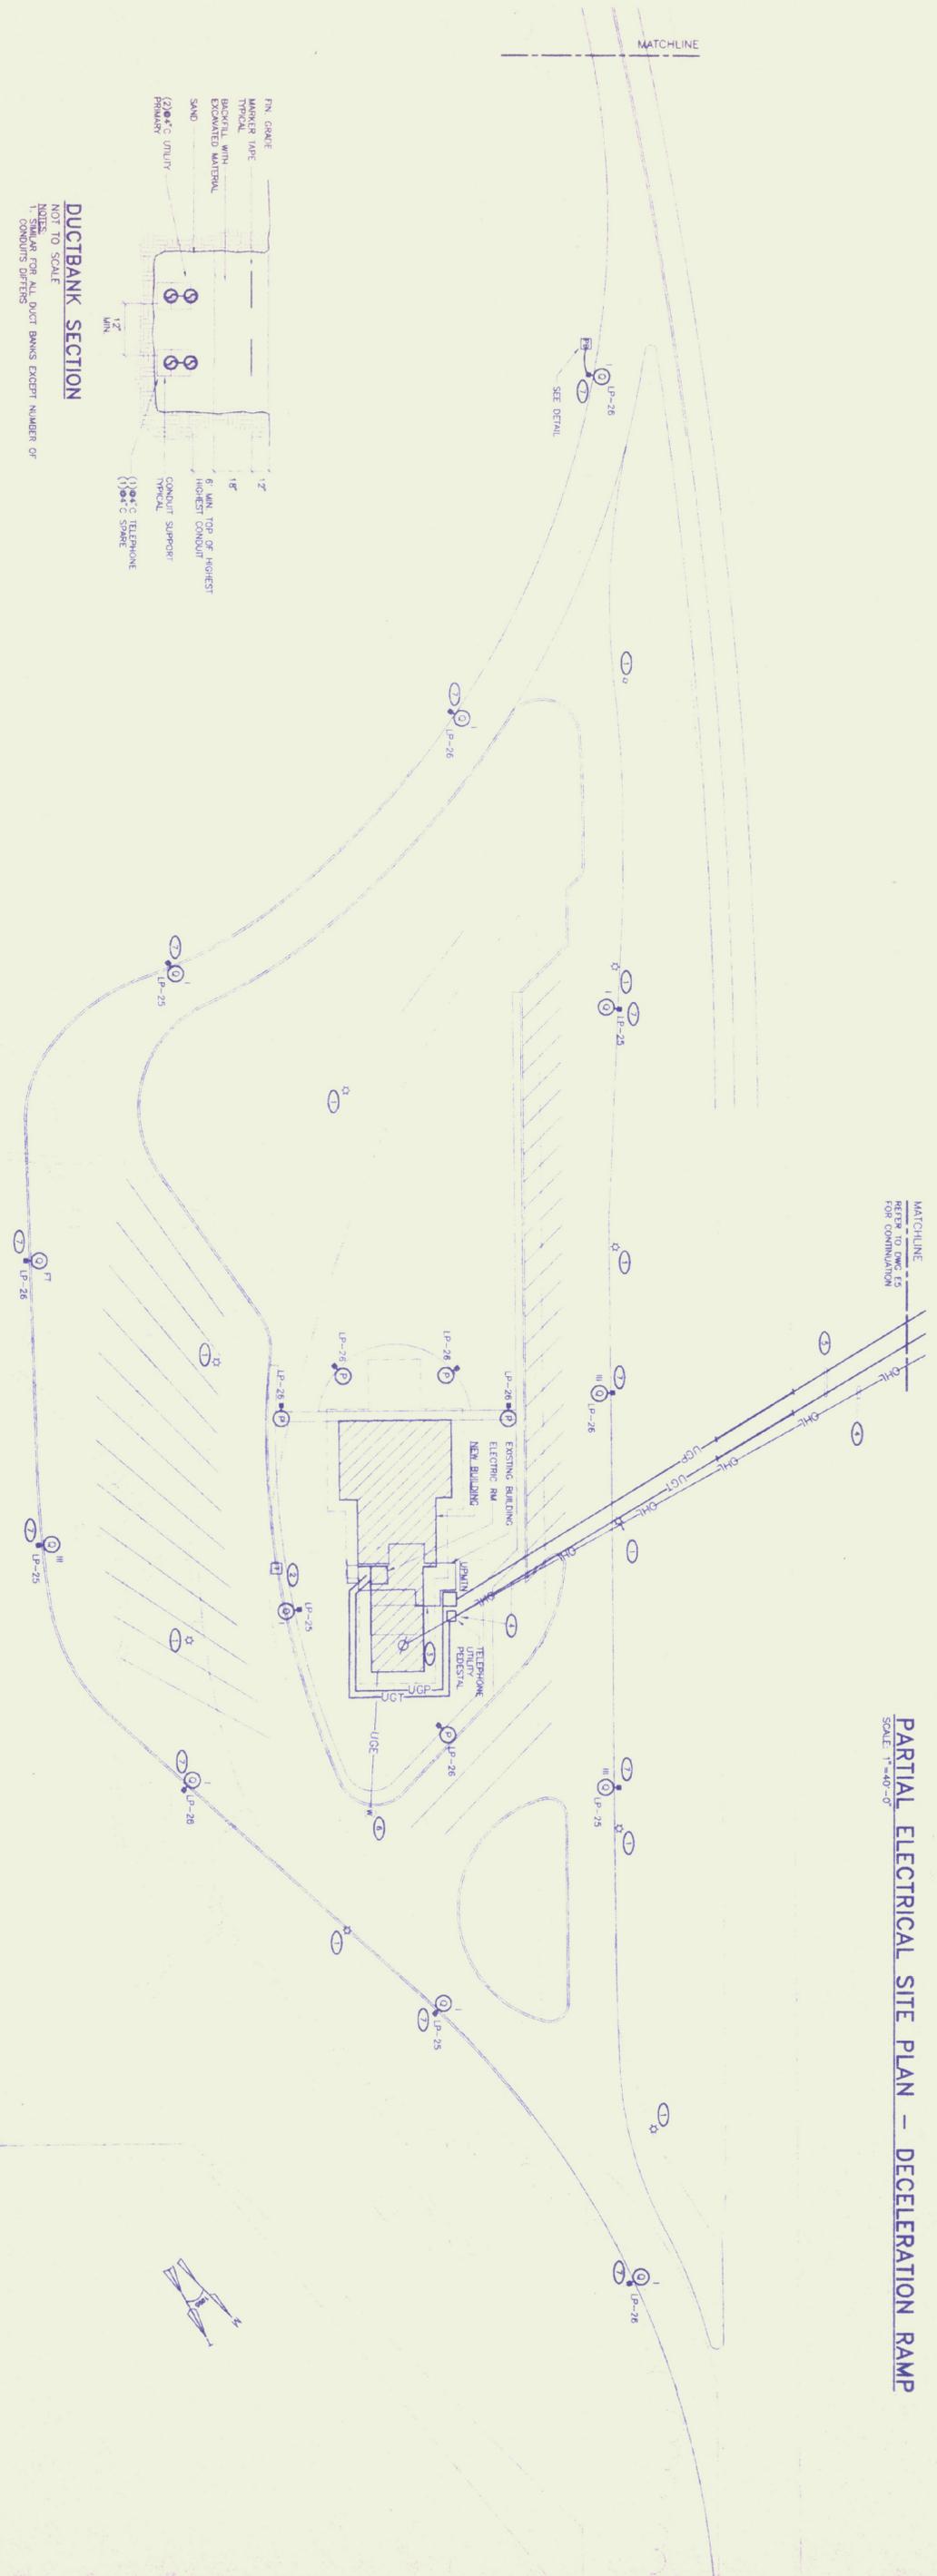

DUCTBANK SECTION
NOT TO SCALE

1. SIMILAR FOR ALL DUCT BANKS EXCEPT NUMBER OF CONDUITS DIFFERS

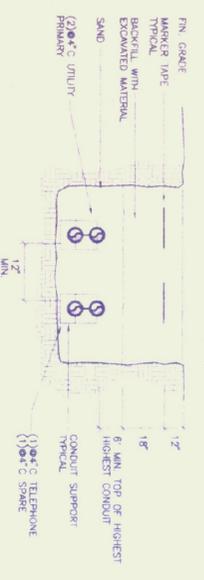

ELECTRICAL SITE PLAN - NORTHBOUND
SCALE: 1"=40'-0"

NOTES:
1. SITE LIGHTING WIRING SHALL BE 248, 1#60, 2" C. MINIMUM. FIELD WIRING IN POLE AND EXTURE SHALL BE #10, MINIMUM.



PRELIMINARY

**WHITE RIVER JUNCTION
TRAVEL AND INFORMATION CENTER**
NORTHBOUND
HARTFORD, VERMONT

**ELECTRICAL
SITE PLAN
NORTHBOUND**

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JOB NAME

SHEET TITLE

DATE

ISSUED FOR

DRAWING NUMBER

E6