
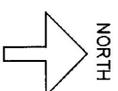
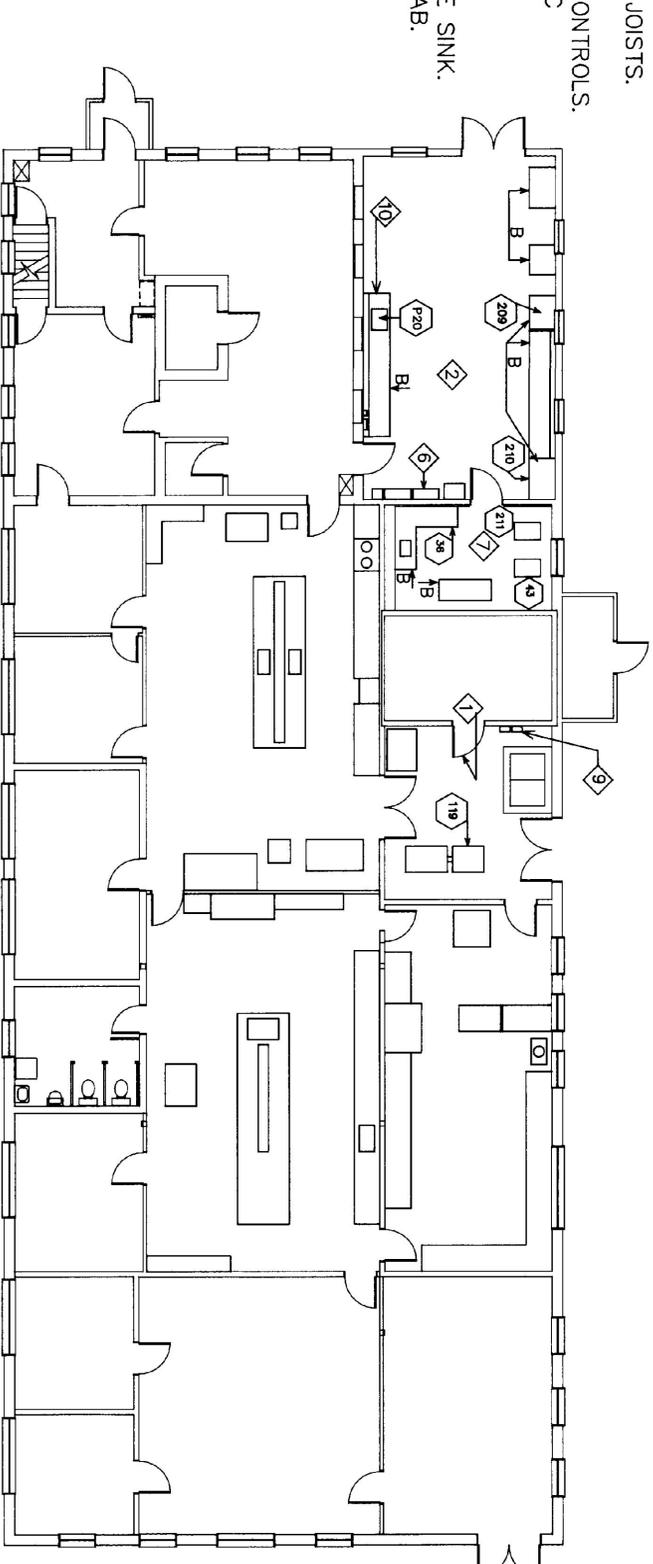


NOTES:

- 1) EXISTING STAINLESS STEEL DOOR FRAME AND DOOR TO BE REMOVED AND RE-INSTALLED IN NEW FOG ROOM.
- CONTRACTOR HAS THE OPTION TO FURNISH AND INSTALL A MATCHING NEW STAINLESS STEEL DOOR FRAME AND RE-USE THE DOOR AND HARDWARE ONLY.
- 2) MECHANICAL EQUIPMENT IN THIS ROOM IS TO BE REMOVED AND RE-INSTALLED IN THE AGGREGATE LAB. REFER TO DRAWINGS M1 AND M2.
- 3) DEMOLISH AND REMOVE THE EXISTING LEAN-TO, INCLUDING FOUNDATION AND PREPARE SITE FOR THE NEW CONSTRUCTION.
- 4) EXISTING PIT AND COVER, SEE DETAILS FOR NEW INSTALLATION.
- 5) EXISTING PARTITIONS TO BE REMOVED. REFER TO DETAILS FOR BEAM AND JOIST REPAIR.
- 6) LOCATION OF ELECTRICAL PANELS.
- 7) EXISTING TESTING ROOM.
- 8) EXISTING INTERIOR SURFACES AND INSULATION (IF ANY) TO BE REMOVED. ADD 2"x2" FURRING TO STUDS, SILLS & HEADERS. INSTALL NEW FULL WALL FIBERGLASS INSULATION, VAPOR BARRIER, 5/8" GYP BD. & MAX INSULATION IN ROOF JOISTS.
- 9) APPROXIMATE LOCATION OF FOG ROOM CONTROLS. SEE DWG M1 & M2, NOTE #15, FOR SPECIFIC INSTRUCTIONS.
- 10) NEW CABINET (FURNISHED BY OWNER). CONTRACTOR: DISCONNECT, CAP & REMOVE SINK. RELOCATE & INSTALL IN NEW AGGREGATE LAB. SEE L1, A2, M1 & M2. SEE ALSO NOTE H THIS DRAWING.

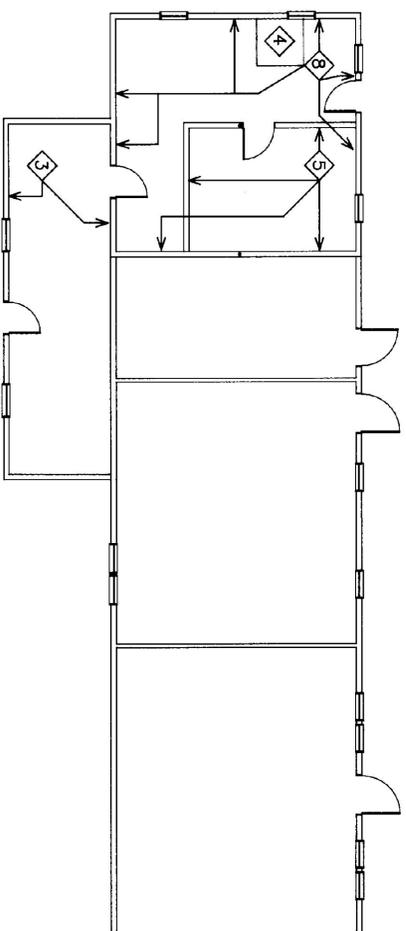

SCALE: 1/8" = 1'-0"

Demolition and Alteration
The Contractor, Subcontractor or assigned personnel shall:

- A. Furnish all labor, materials and equipment to complete the demolition and alteration work described on the drawings and specified herein. Install all necessary and required temporary safety rails, bars, enclosures and/or fences.
- B. Demolition and removal shall be complete to facilitate the remodeling of the structure.
- C. All debris shall be removed from the structure and site. Do not stockpile debris on the site or on adjacent properties. Accumulation of debris within the building is not permitted. Burning of debris on site is not permitted.
- D. All demolitions shall be done in an orderly manner. Install and maintain adequate shoring, bracing and temporary supports to avoid damage and/or collapse of the structure. Maintain exits accessible at all times. Masonry shall be demolished in small sections or units. Bracing, shoring, scaffolding and platforms shall be used to provide safe working conditions.
- E. Remove walls, partitions, portions of floors, doors, frames, trim, casing, bulletin boards, plumbing fixtures, light fixtures and enlarge, provide and/or cut new openings where shown and required.
- F. Removal of walls and partitions shall be done neatly and completely (except for temporary shoring and bracing) with minimum damage to adjacent walls and ceilings, piping, heating and other equipment.
- G. The equipment will be moved by the Owner. Contractor shall disconnect, dismantle, and reconnect all equipment.
- H. Counters (all "g" items) will be furnished and installed by the Owner. Contractor shall cut openings for sinks and install sinks complete with hot water and drain.
- I. The Contractor's bid shall include the rip-out and potential salvage/reuse of existing built-in ("g" item) counters.
- J. Contractor shall cap all discontinued piping, steam and water piping. Electrical work shall be removed back to the source.

<p>3) NOTE & ID SYMBOL</p> <p>59) EQUIPMENT NO. SEE DWG L1 FOR LOCATION & DESCRIPTION. REFER TO A, E & M DWGS FOR INSTALLATION.</p>	<p>State of Vermont Department of State Buildings John Zampieri, Commissioner</p>	<p>Materials & Research Laboratory Berlin, VT</p>		<p>Jonson Design, Inc. 2020 VAIL AVENUE, SUITE 100 FARMINGTON, VT 05475 P.O. BOX 55 - FARMINGTON, VT 05475 (802) 247-9600</p> <p>Architect's Project No. 247</p>	<p>REFERENCE & RIP-OUT PLAN (EXISTING CONDITIONS)</p> <p>REV. #1 - NOV. 1989</p>	<p>DATE: OCT. 10, 1989</p> <p>DWG. NO. R</p>
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