




GARAGE STORAGE MEZZANINE
SCALE: 1/4" = 1'-0"

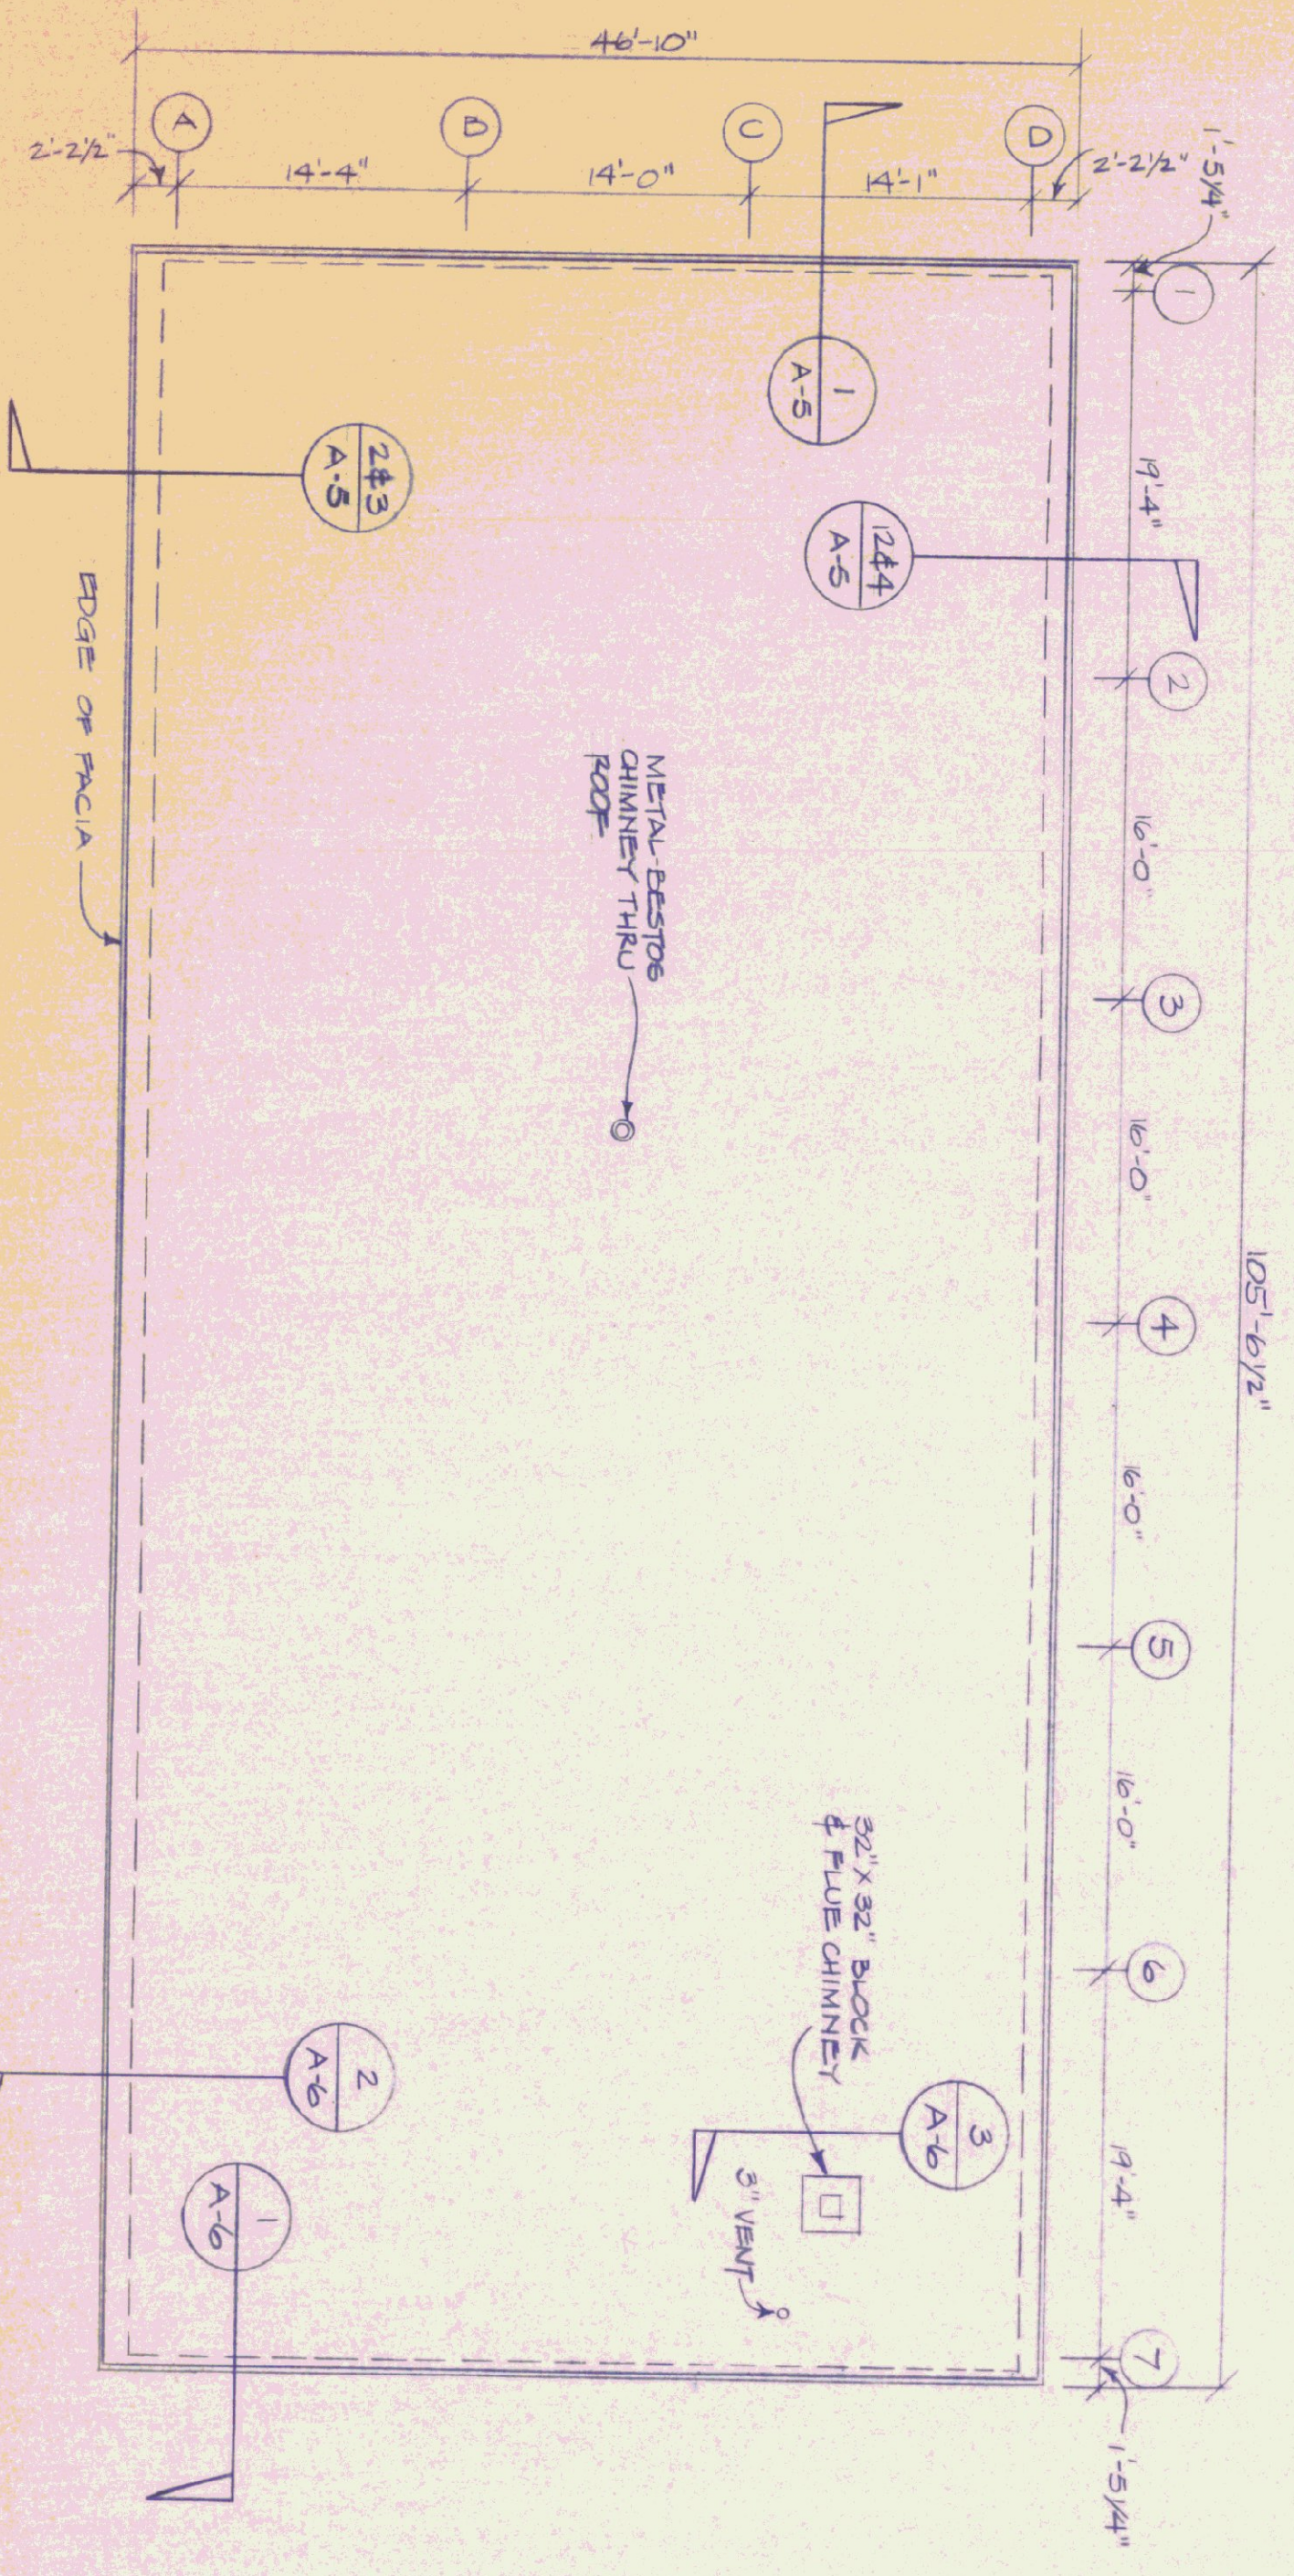

ROOF PLAN
SCALE: 1/8" = 1'-0"

DOOR SCHEDULE														
NO.	QUANTITY	SIZE	TYPE	FRAME	DOOR MATERIAL	FRAME MATERIAL	HURDLE SET #	GLASSING	GLASSING RESERVE	BUTTS	LIGHT PLATE	STILES	CLOSER	REMARKS
D-D8	3	3'-0" x 7'-0"	1	C	INSULATED METAL	METAL	1	4" x 4" WIPERLESS SAFETY	4" x 4" WIPERLESS SAFETY	3/4" x 1/4" STAINLESS	3/4" x 1/4" VINYL	NONE	3/4" x 1/4" WIPERLESS SAFETY	TERMINAL BREAK FRAME
D4	1	2'-0" x 6'-0"	2	C	NO. INT.	"	2	20" x 32" SAFETY	4 1/2" x 4 1/2"	"	"	"	"	"
D5	1	"	3	D	"	"	4	NONE	"	"	"	"	"	"
D6	1	"	3	D	"	"	3	"	"	"	"	"	"	"
D7	1	"	3	B	"	"	4	"	"	"	"	"	"	"
D9-D12	4	14'-0" W x 12'-0" H	4	C	INSULATED STEEL	STEEL	"	"	"	"	"	"	ELECTRIC	OVERHEAD DOOR SERIES 911 THERMACORE W/ACRYLIC WINDOWS
D8	1	14'-0" x 14'-0"	1	C	"	"	"	"	"	"	"	"	"	"

WINDOW SCHEDULE			
NO.	QUANTITY	TYPE	REMARKS
10	1	AWNING METAL	ACORN BLDG. COMPONENTS 2'-0" H 4500 SERIES-3420C

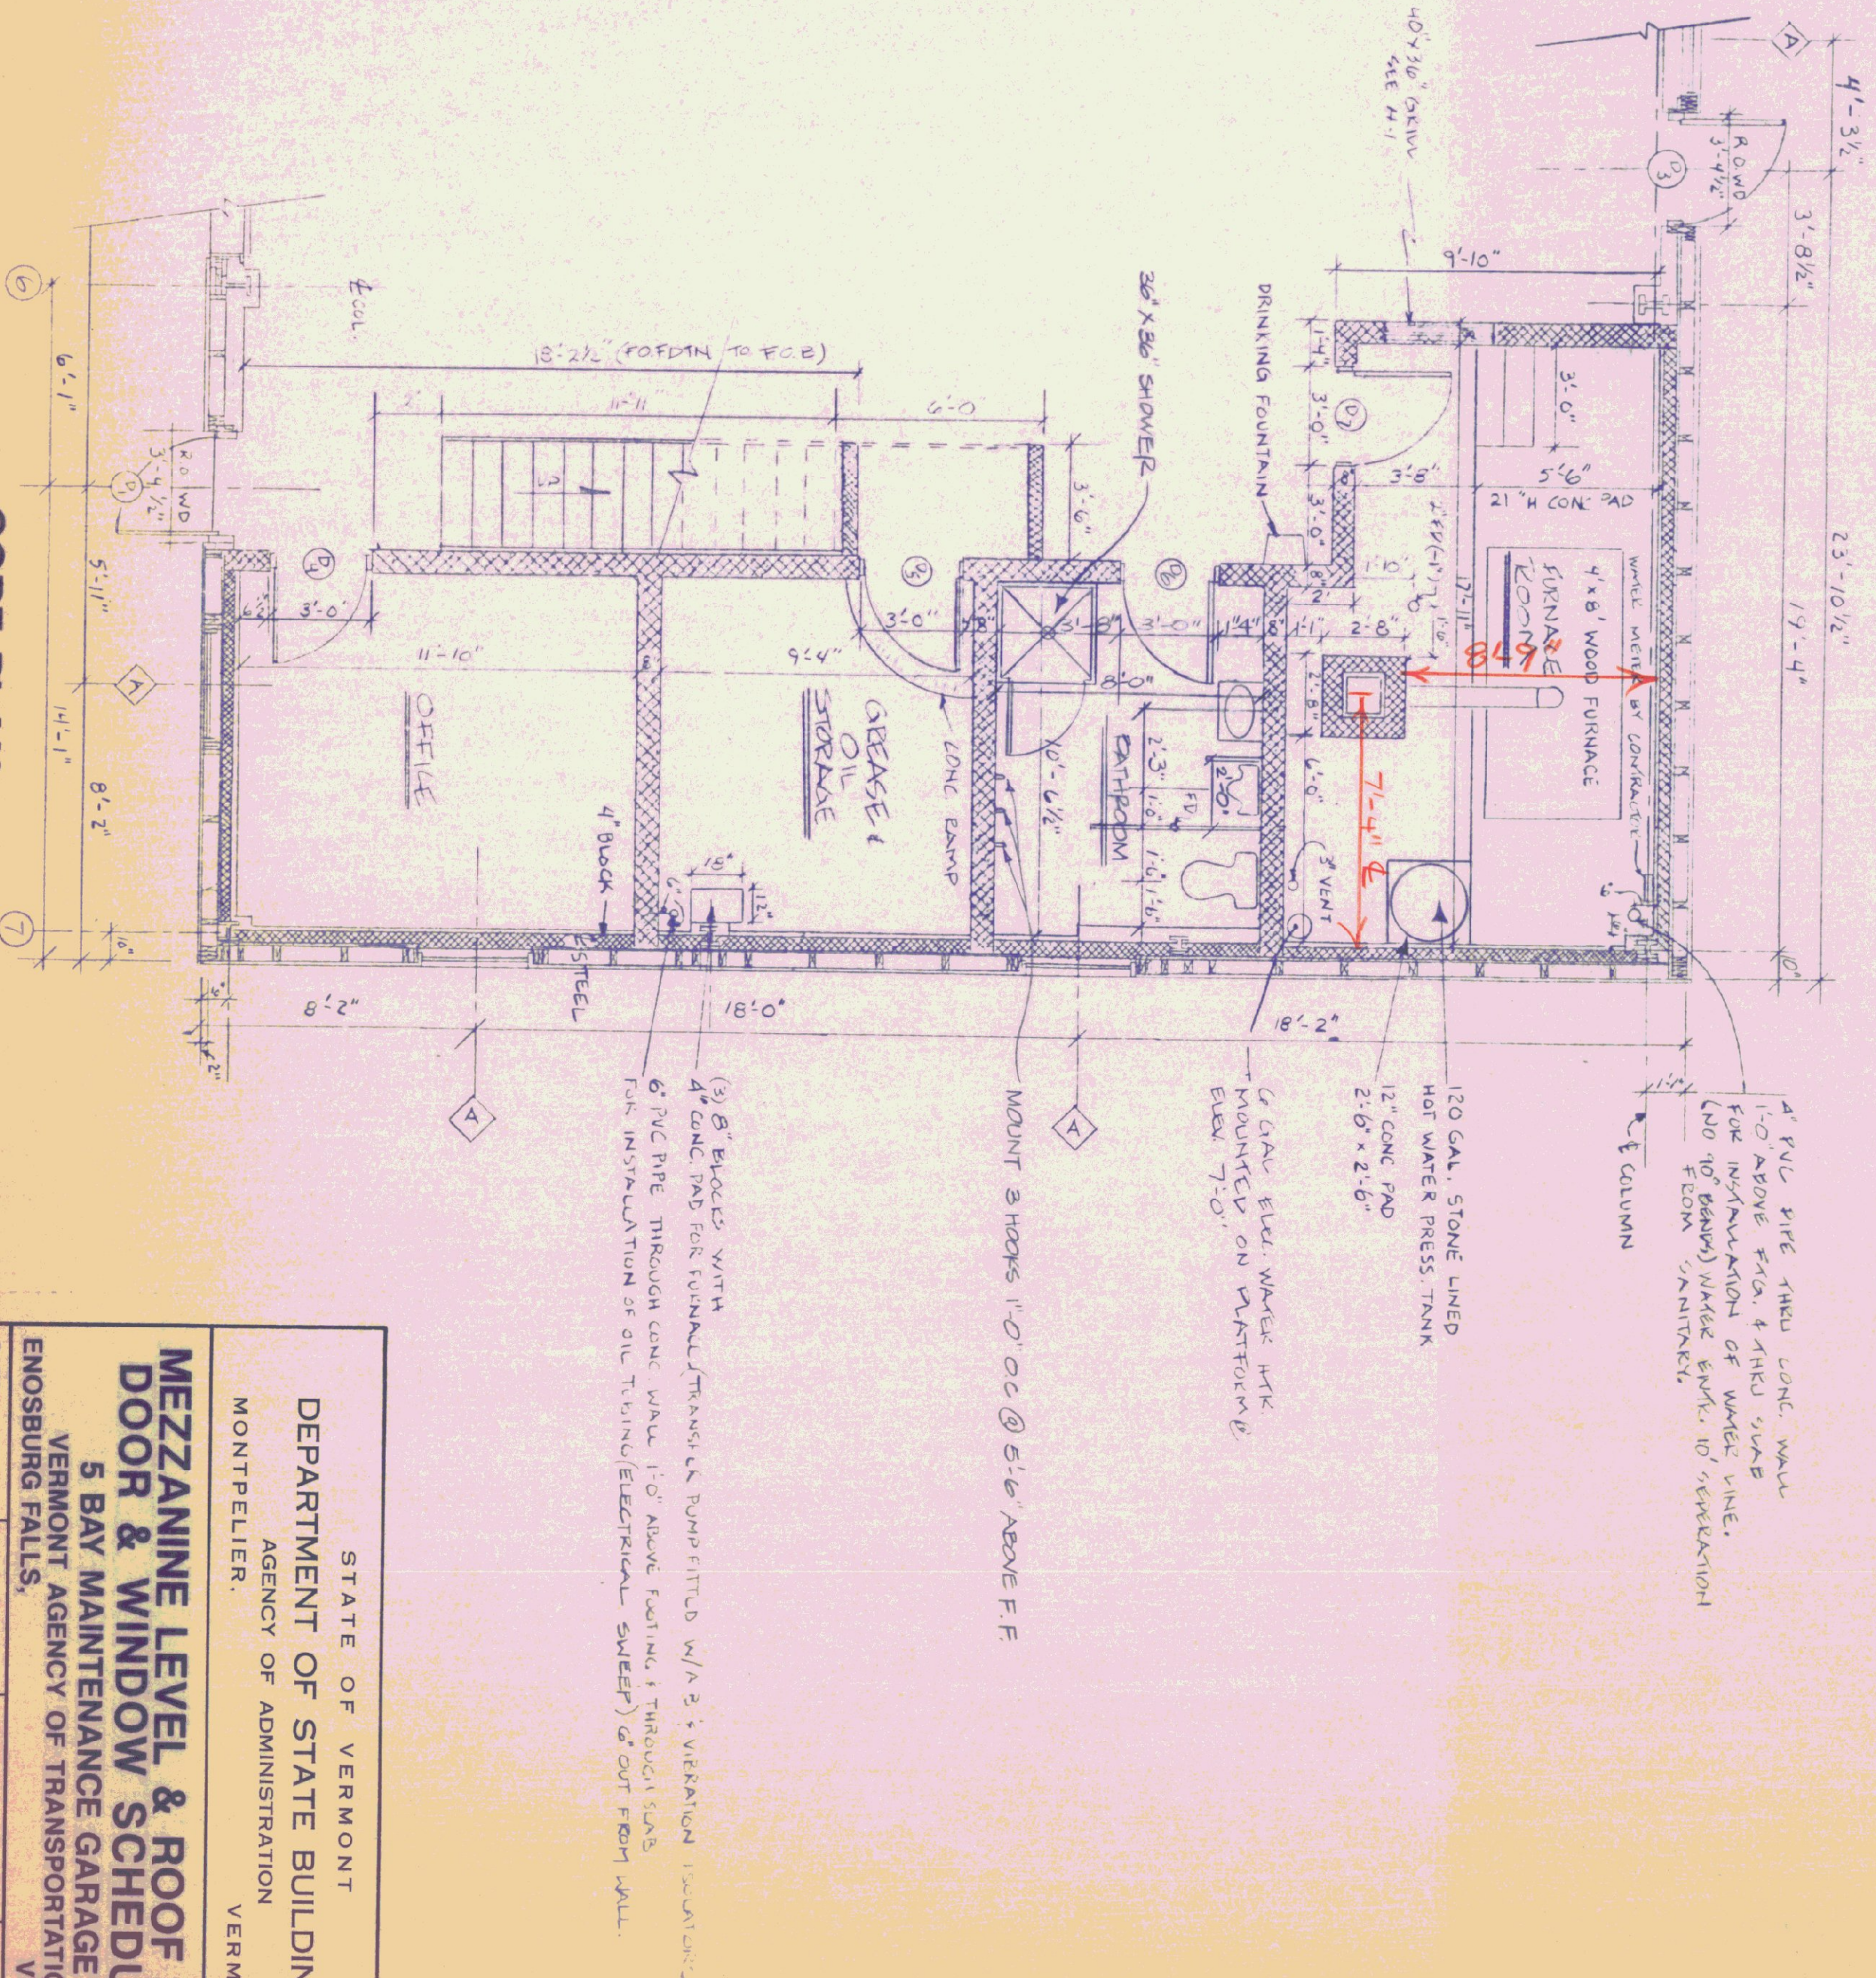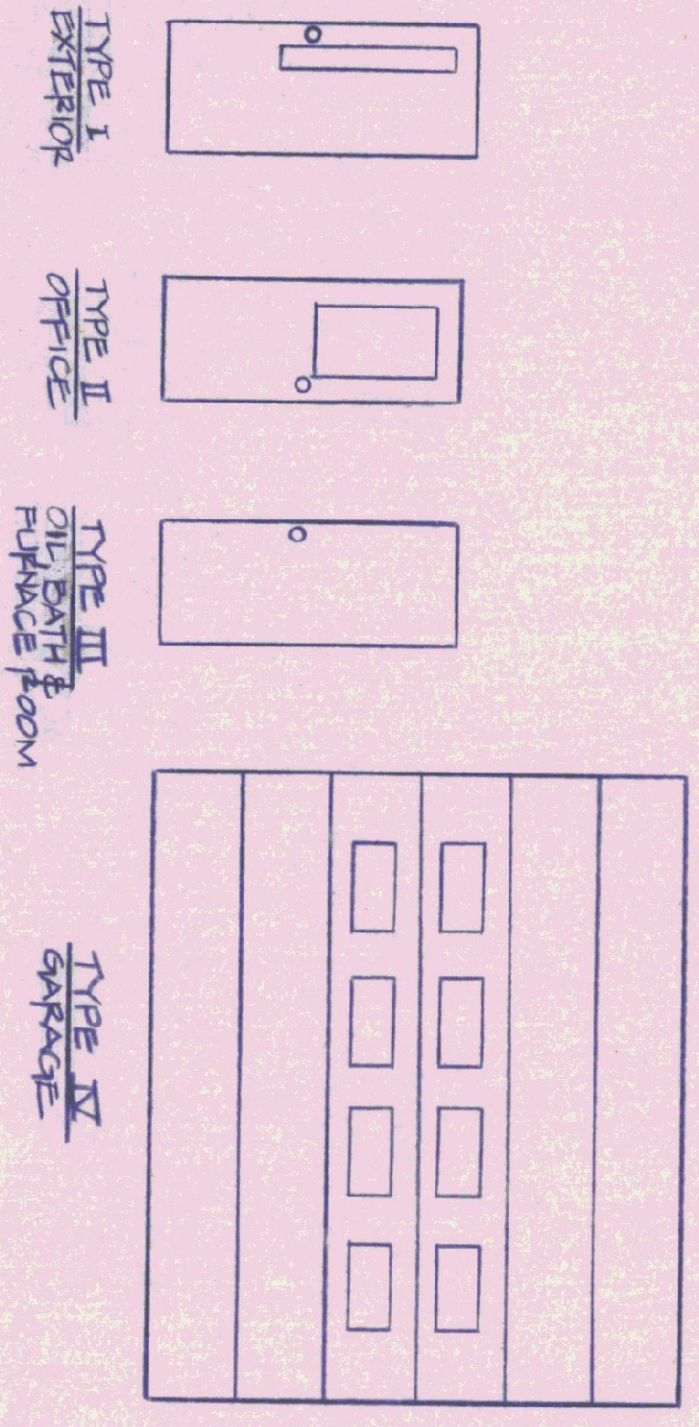

CORE PLAN
SCALE: 1/4" = 1'-0"

STATE OF VERMONT
DEPARTMENT OF STATE BUILDINGS
AGENCY OF ADMINISTRATION
MONTPELLIER VERMONT

**MEZZANINE LEVEL & ROOF PLAN
DOOR & WINDOW SCHEDULES**
5 BAY MAINTENANCE GARAGE
VERMONT AGENCY OF TRANSPORTATION
ENOSBURG FALLS, VERMONT

DATE MAY 20, 1991	SCALE AS NOTED	REVISIONS	DWG. NO. A-2
DRAWN BY R. TETREAULT	APPROVED BY A. POULIN		6 OF 24