


ROOF FRAMING PLAN (SCALE 1/8" = 1'-0")

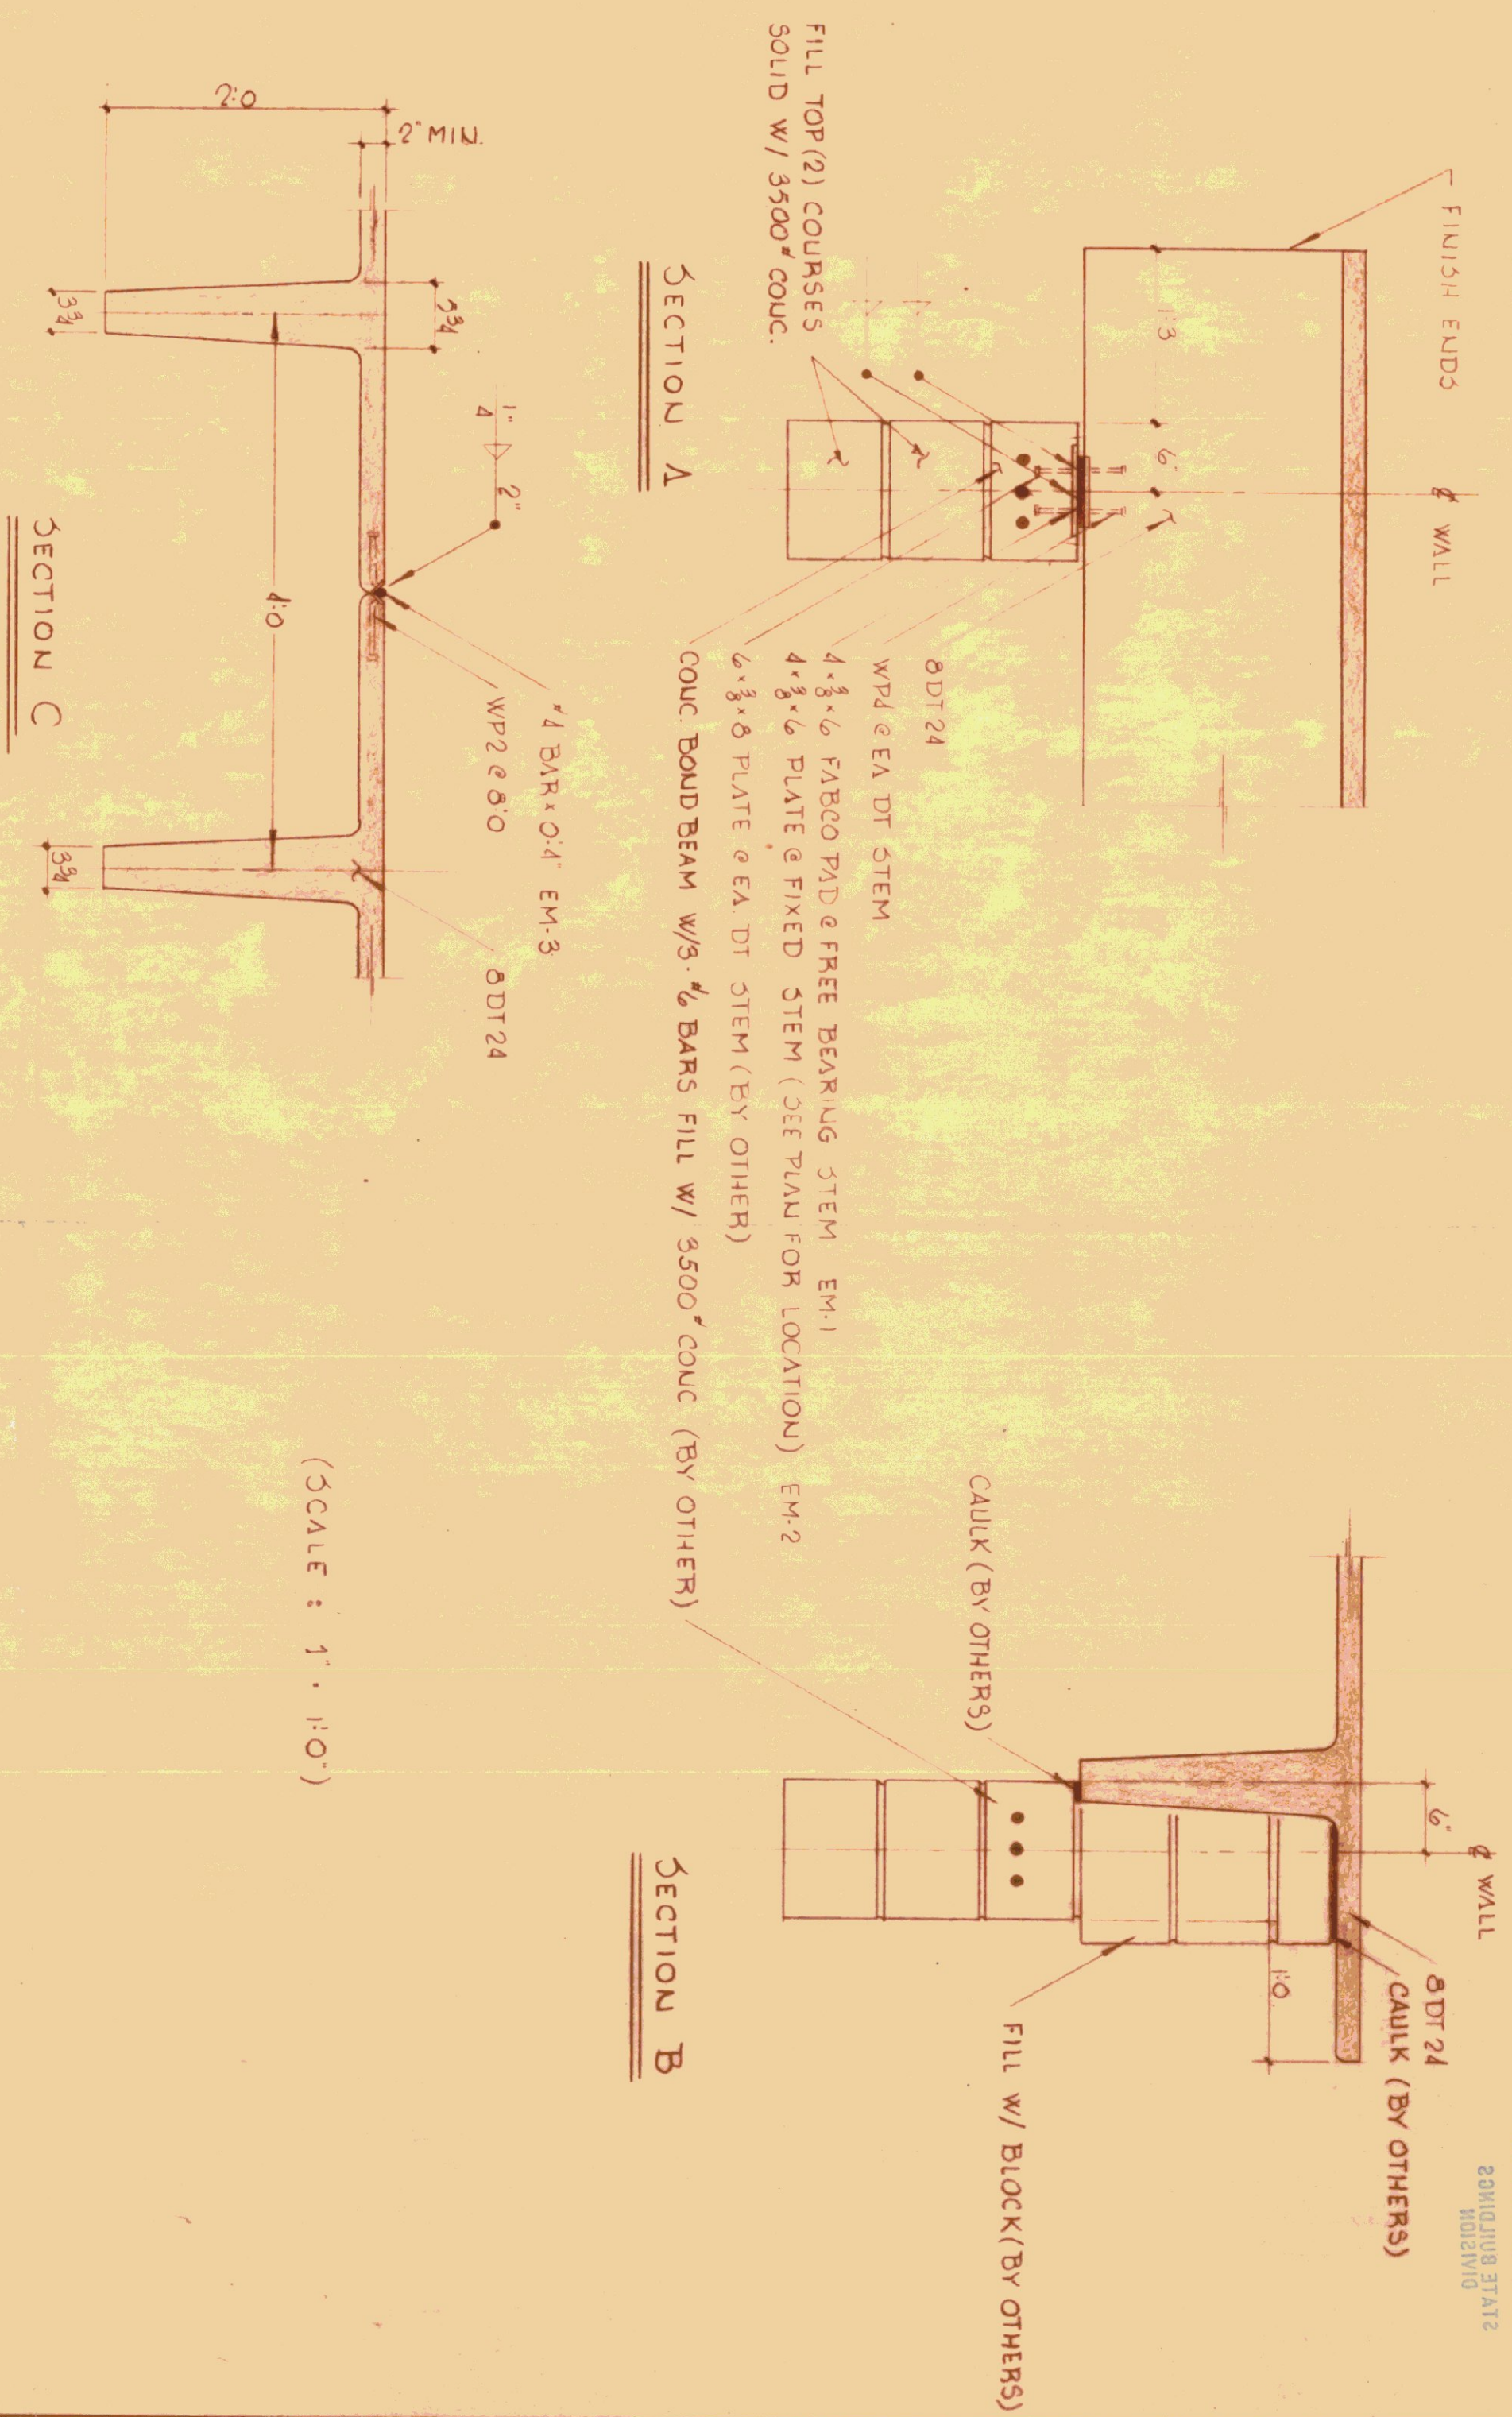

DESIGN LOADS : LL + 30 PSF

- GENERAL NOTES:**
1. UNISTRESS WILL NOT BE RESPONSIBLE FOR BEARING DIMENSIONS AFTER SHOP DRAWINGS HAVE BEEN APPROVED. DIMENSIONS SHOWN ARE PRESUMED TO BE CORRECT.
 2. CUSTOMER WILL PROVIDE DIMENSIONS AND LOCATION OF OPENINGS LARGER THAN 8 INCHES TO BE CAST IN UNITS. OPENINGS NOT SHOWN WILL BE CUT BY OTHERS.
 3. UNISTRESS WILL NOT SUPPLY INSERTS OR MISCELLANEOUS HARDWARE CONTAINED IN CAST IN PLACE WORK UNLESS SPECIFICALLY NOTED.
 4. CUSTOMER WILL PROVIDE ADEQUATE CLEAR AREA TO AND WITHIN THE STRUCTURE FOR UNRESTRICTED OPERATION OF CRANES AND TRUCKS BY THE ERECTOR.
 5. ERECTOR WILL REMOVE AND PATCH LIFTING EYES PROVIDED FOR ERECTION.

MATERIAL SPECIFICATIONS:

CONCRETE:	5000 PSI @ 28 DAYS
STRAI:	
REBAR:	
HARDWARE:	
FINISH:	

REVISIONS

NO	DATE	REVISIONS
1	11/15/75	FOR REV. MADE WORKED UP DRAWINGS FROM VT. BLOC ENG. DEPT. 2/24/76

DATE: 14 FEB. 75
 SCALE: AS SHOWN
 CHDR: DPTM: B
 JOB NO: 7504
 DWG. NO: F-1

unistress

P.O. BOX 1145, PITTSFIELD, MASSACHUSETTS, 01201 (413) 499-1441
 PRECAST STRUCTURAL CONCRETE — MEMBER PRESTRESSED CONCRETE INSTITUTE

STATE HIGHWAY GARAGE AT LYNDON, VERMONT
 DIVISION OF BUILDINGS
 HARR CONSTRUCTION — CONTRACTOR

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