




FOUNDATION PLAN
SCALE 1/8" = 1'-0"

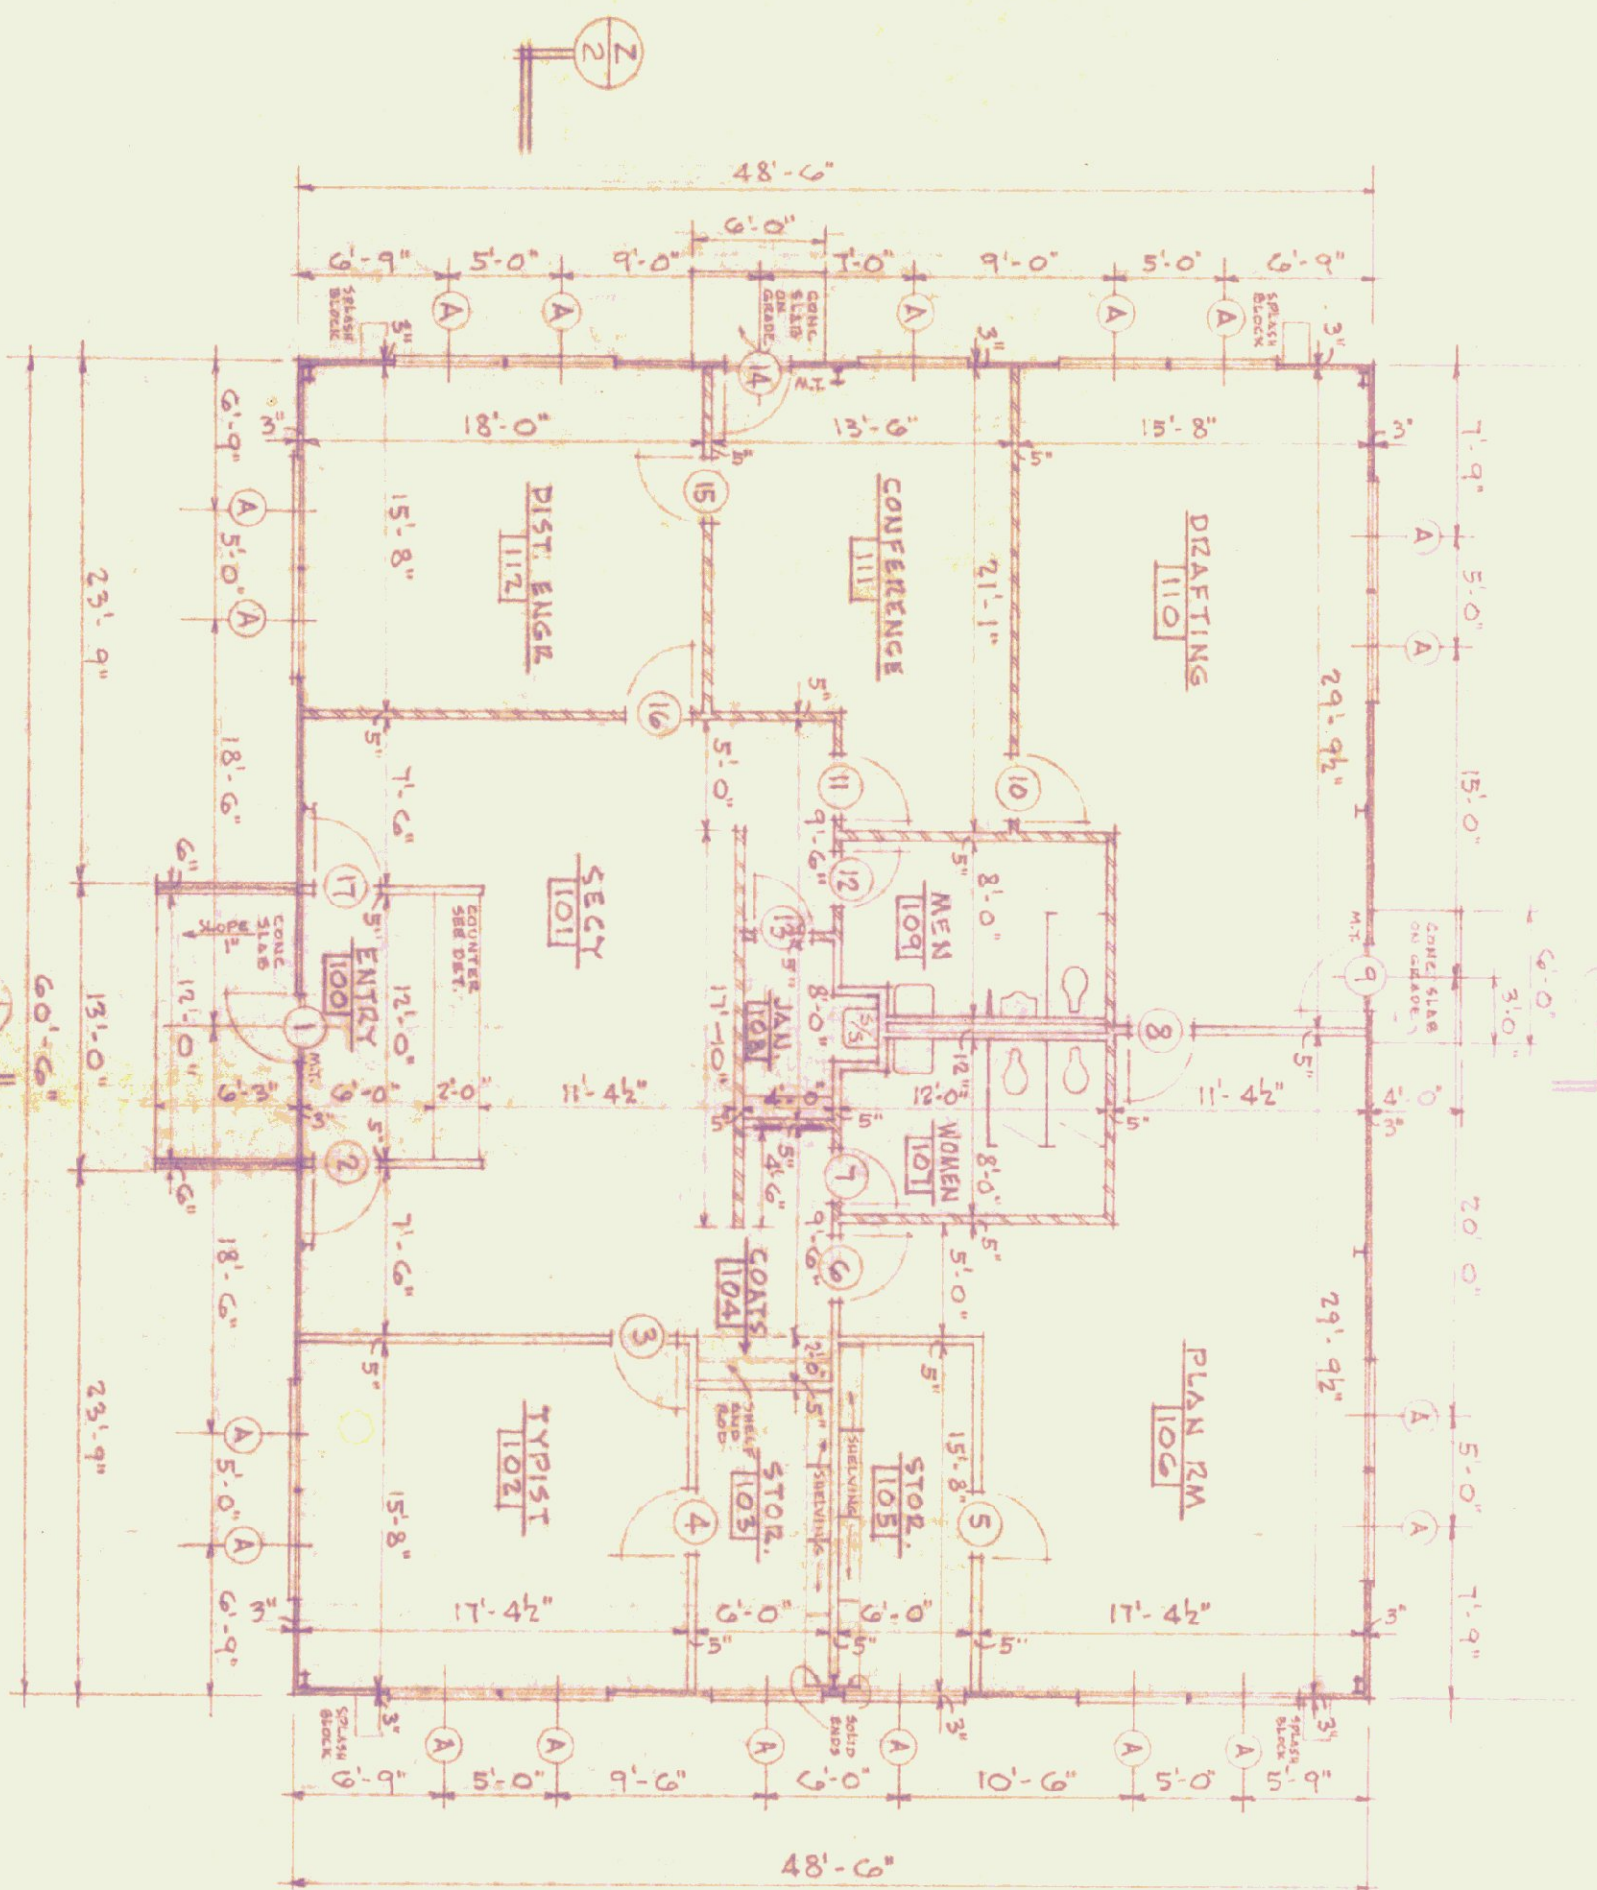

FIRST FLOOR PLAN
SCALE 1/8" = 1'-0"

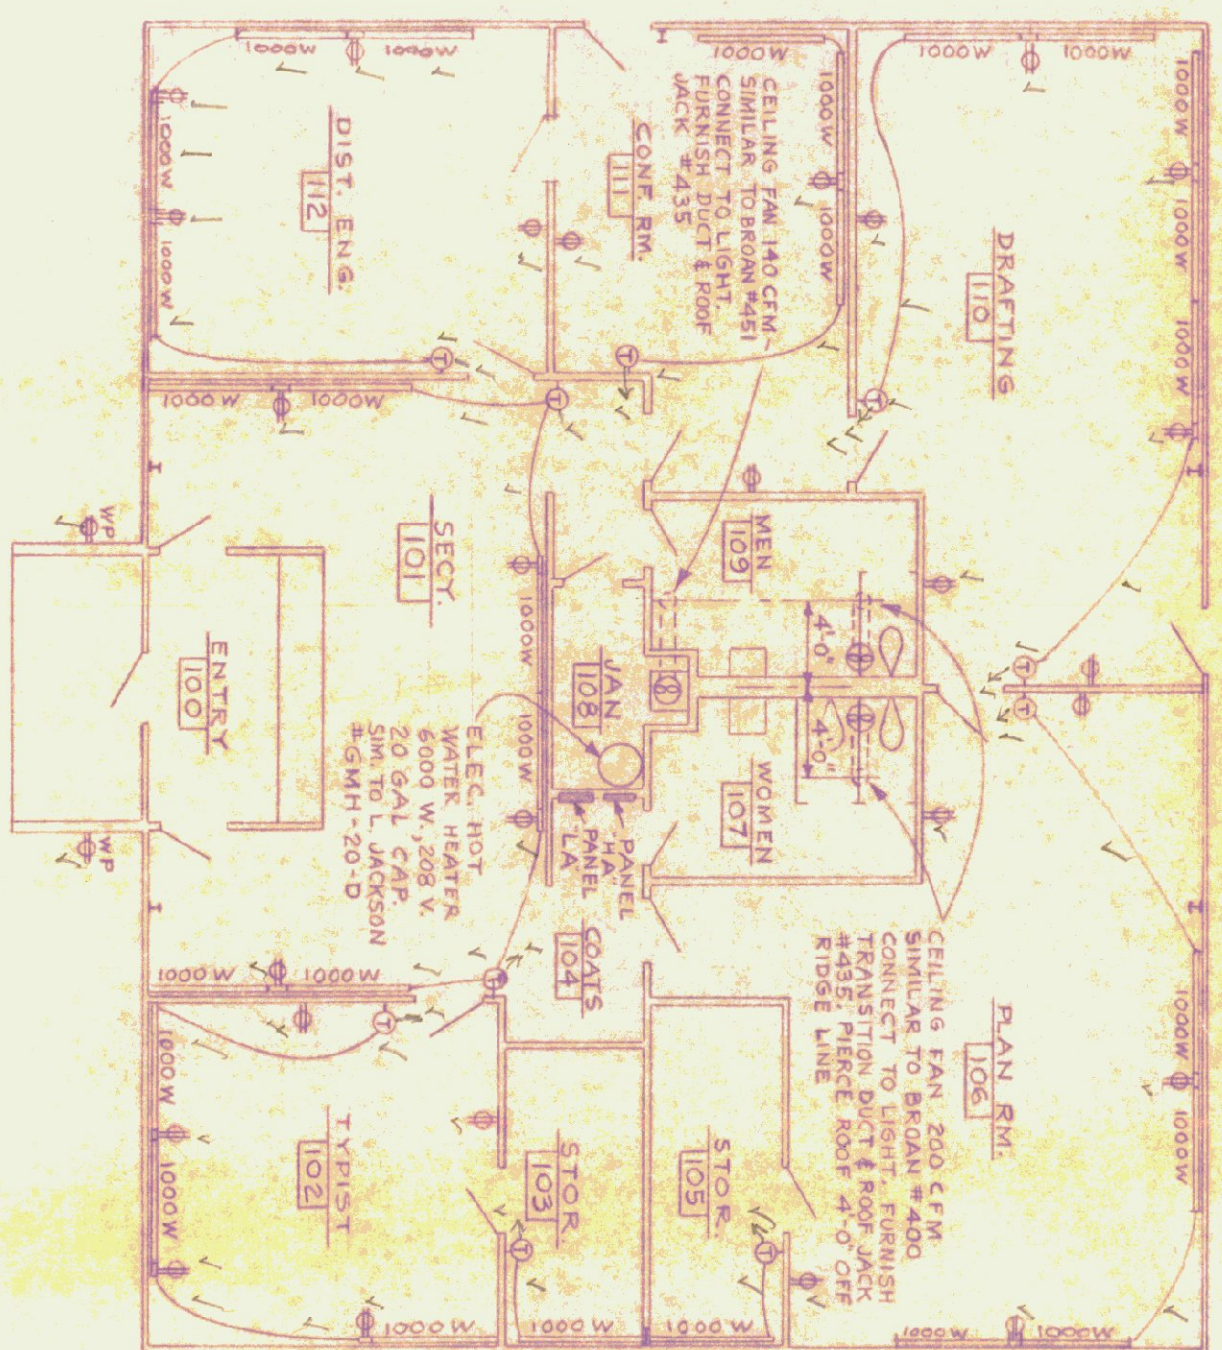

ELEC-HEAT & POWER PLAN
SCALE 1/8" = 1'-0"

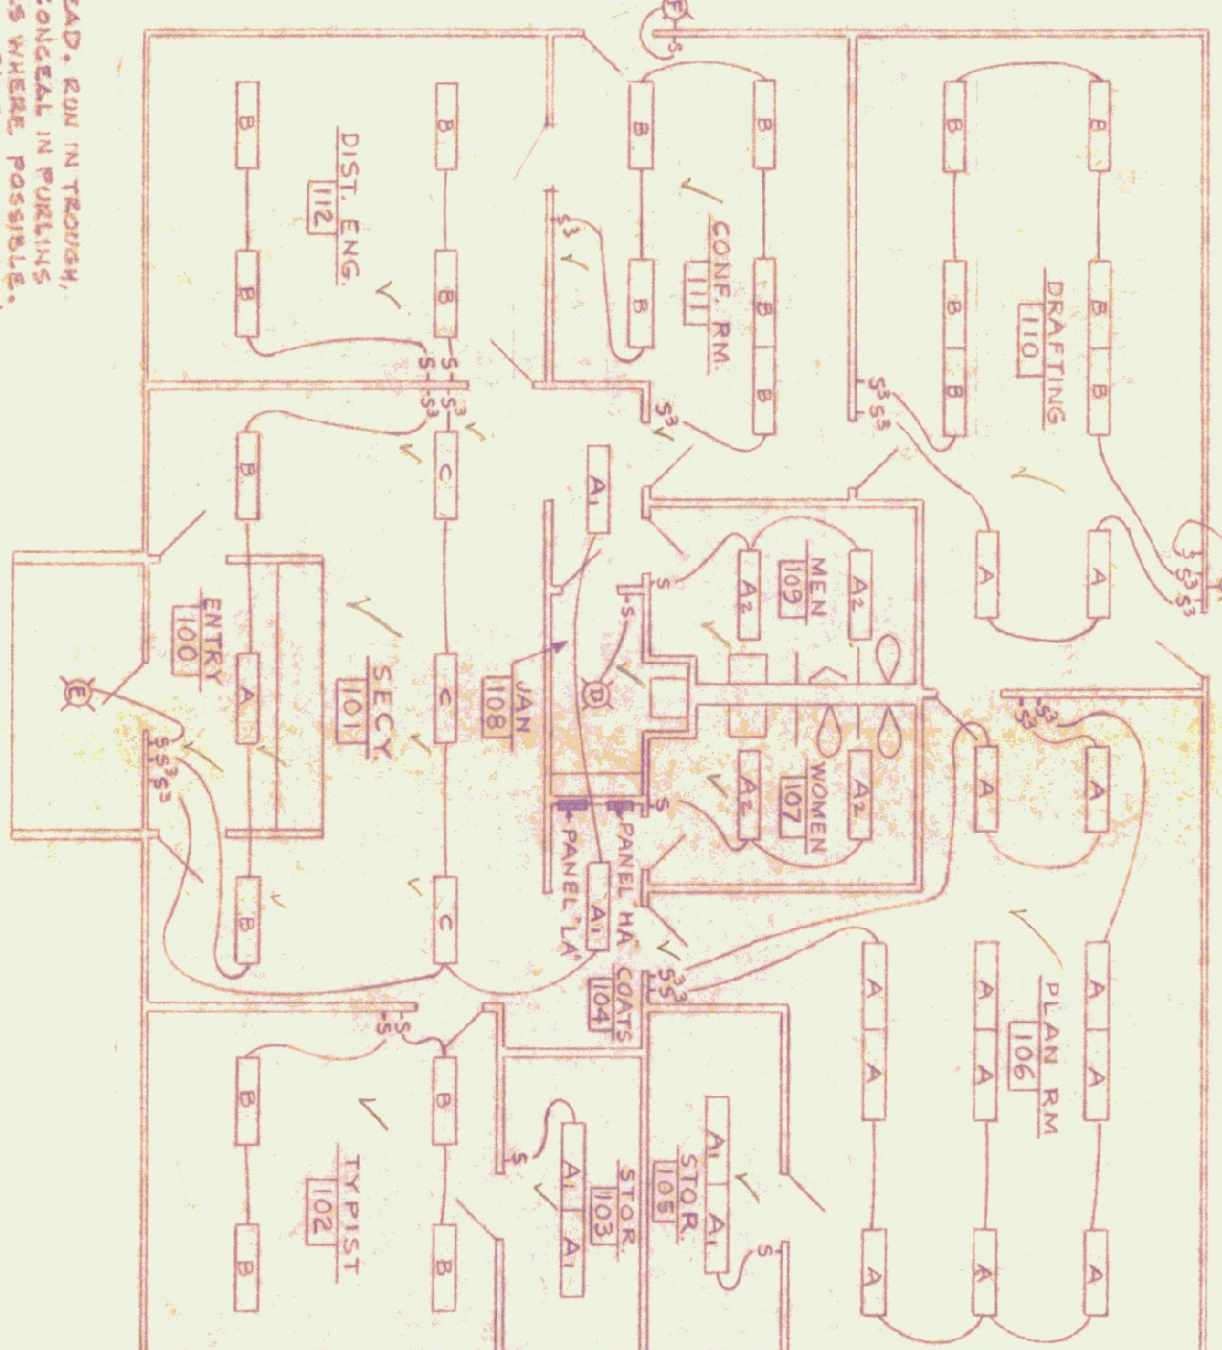


ELEC-LIGHTING PLAN
SCALE 1/8" = 1'-0"

NOTE
- ALL WIRING OVERHEAD, 600V N.T. TRONIX
CONDUIT AS SHOWN. CONCEAL IN WALLS
OR BEAM FINISHES WHERE POSSIBLE.
- CHAIN HANG FIXTURES 3'-0" ABOVE FIN. FLR.
- SWITCHES SHOWN FOR LIGHTING ONLY - REM
WIRING IN NORMAL MANNER.

CONCRETE SPLASH
BLOCK DETAIL

WINDOW SCHEDULE

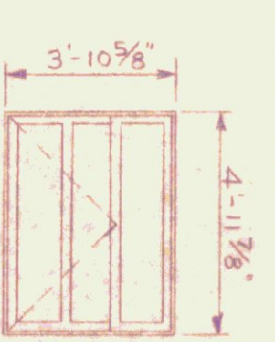


ALL EXTERIOR WINDOWS & FRAMES
EVEN PRE-CAST CONCRETE WINDOW SCHEDULES.

DOOR SCHEDULE

NO.	SIZE	THICK	TYPE	MATERIAL	HARDWARE	REMARKS
1	3'-0" x 7'-0"	1 3/4"	A	H.M.	A-5	CLEAR WIRE GLASS
2	3'-0" x 7'-0"	"	A	H.C.V.	1	NONE
3	3'-0" x 7'-0"	"	A	H.C.V.	12	NONE
4	3'-0" x 7'-0"	"	B	H.C.V.	12	NONE
5	3'-0" x 7'-0"	"	B	H.C.V.	12	NONE
6	3'-0" x 7'-0"	"	B	H.C.V.	7	NONE
7	2'-6" x 7'-0"	"	C	H.C.	5	WOOD LOUVER
8	3'-0" x 7'-0"	"	A	H.C.V.	12	NONE
9	3'-0" x 7'-0"	"	A	H.M.	7	A-5
10	3'-0" x 7'-0"	"	B	H.C.V.	7	A-6
11	3'-0" x 7'-0"	"	B	H.C.V.	7	A-6
12	2'-6" x 7'-0"	"	C	H.C.	5	WOOD LOUVER
13	2'-6" x 7'-0"	"	C	H.C.	9	A-4
14	3'-0" x 7'-0"	"	A	H.M.	7	A-5
15	3'-0" x 7'-0"	"	A	H.C.V.	7	A-6
16	3'-0" x 7'-0"	"	A	H.C.V.	7	A-6
17	3'-0" x 7'-0"	"	B	H.C.V.	13	NONE

NOTE: H.M. = HOLLOW METAL
H.C. = WOOD HOLLOW CORE
PARTITION DIMENSIONS SHOWN ARE FINISH TO FINISH
DOORS = METAL STUDS & SHEET ROCK, FLOOR TO ROOF
DOOR NUMBER BASE IN SPECIFICATION IS TO BE NOT APPLIED TO THIS BUILDING

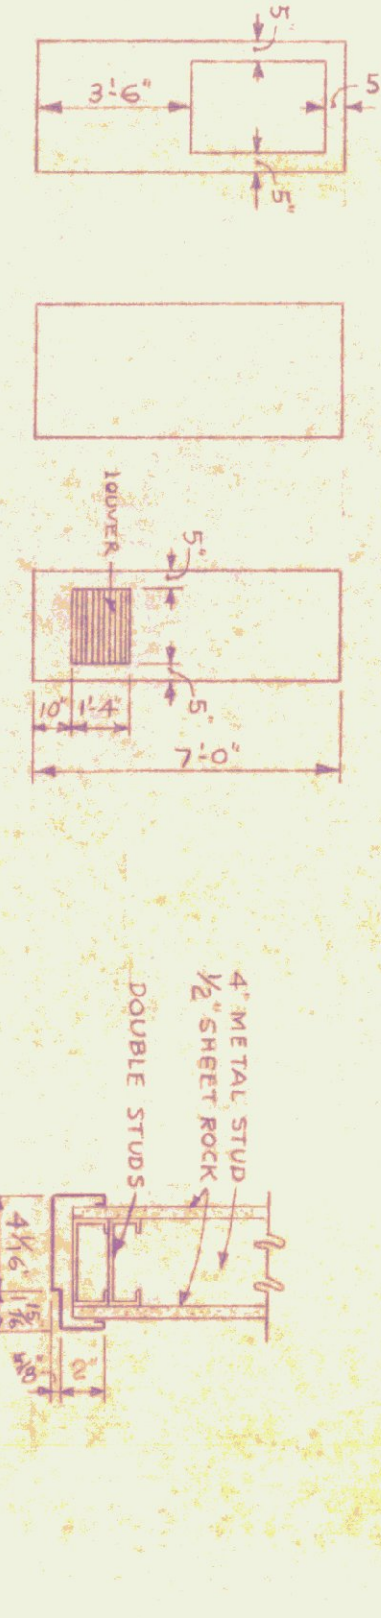

DOOR TYPES

INTERIOR DOOR
JAMB

ROOM FINISH SCHEDULE

NO.	AREA	FLOOR	BASE	WAINSCOT	WALL	CEILING	REMARKS
100	ENTRY	"	V.A.	"	"	"	SEE ENTRY COUNTER DET. DWG. NO. 3
101	SECRETARY	"	"	"	"	"	"
102	STORAGE	"	"	"	"	"	"
103	STORAGE	"	"	"	"	"	"
104	STAIRS	"	"	"	"	"	"
105	STORAGE	"	"	"	"	"	SEE CORR. DRAWING NO. 2
106	STORAGE	"	"	"	"	"	SEE CORR. DRAWING NO. 2
107	STORAGE	"	"	"	"	"	SEE CORR. DRAWING NO. 2
108	WOMEN	"	"	"	"	"	"
109	WOMEN	"	"	"	"	"	"
110	WOMEN	"	"	"	"	"	"
111	CONF. ROOM	"	"	"	"	"	"
112	DIST. ENGINEER	"	"	"	"	"	"

FIXTURE SCHEDULE

NO.	DESCRIPTION	MANUFACTURER	FINISH	REMARKS
A	SIMILAR TO DAYBRITE	OCTET-7	CC166-76-4	LAMP RAMP START, COOL, WHITE
B	"	"	CC266-76-4	"
C	"	OCTET-12	CO240-24-4-2	"
D	"	"	"	"
E	"	OCTET-18	CO440-44-4-4	"
F	"	"	"	"
G	"	PRESCOTT	7808	WHITE GLASS, ALUMINUM CANOPY 60W
H	"	"	4040	OPAL GLASS, " 75W
I	"	"	4220	" 100W


WHITE RIVER JCT.
STATE OF VERMONT
OFFICE BUILDING


STATE HIGHWAY DEPT.
PLANS & SCHEDULE
SCALE 1/8" = 1'-0"

RICHARD B. DIAMOND & ASSOC.
ARCHITECTS-ENGINEERS
DESIGNED BY
DRAWN BY
CHECKED BY
DATE 10-68
PROJECT NO. 5368




CUTLER-HAMMER LOAD
CENTERS - FLUSH CABINETS
WITH BOORS, CHAIRS -
CHG 30F COVER 24 CIRCUITS
SINGLE POLE BREAKERS
THREE PHASE

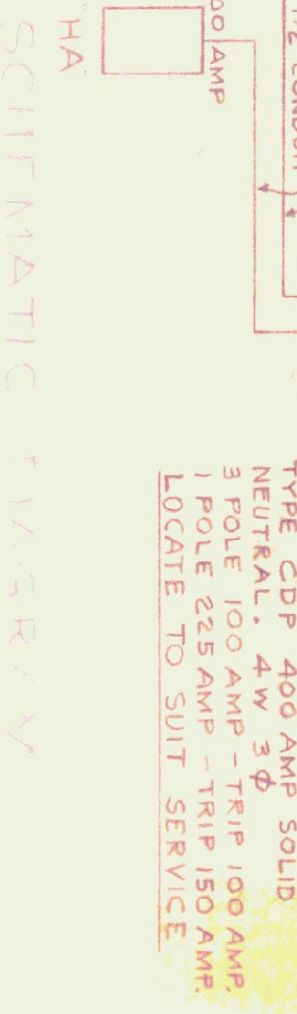


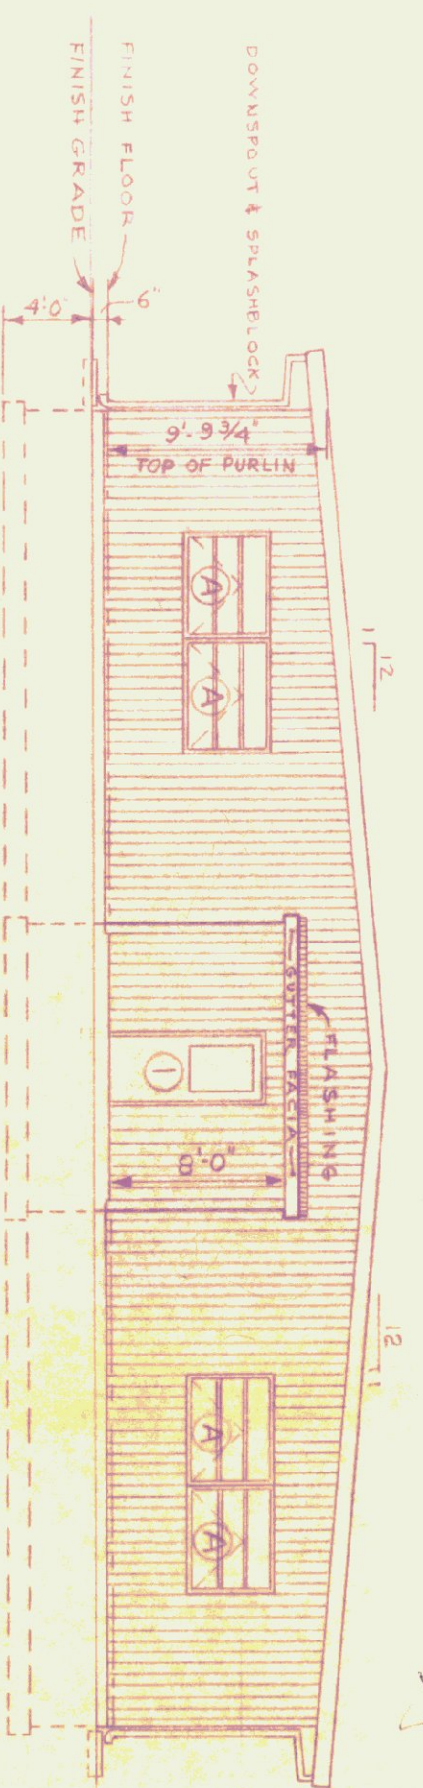


SOUTH ELEVATION
SCALE 1/8" = 1'-0"

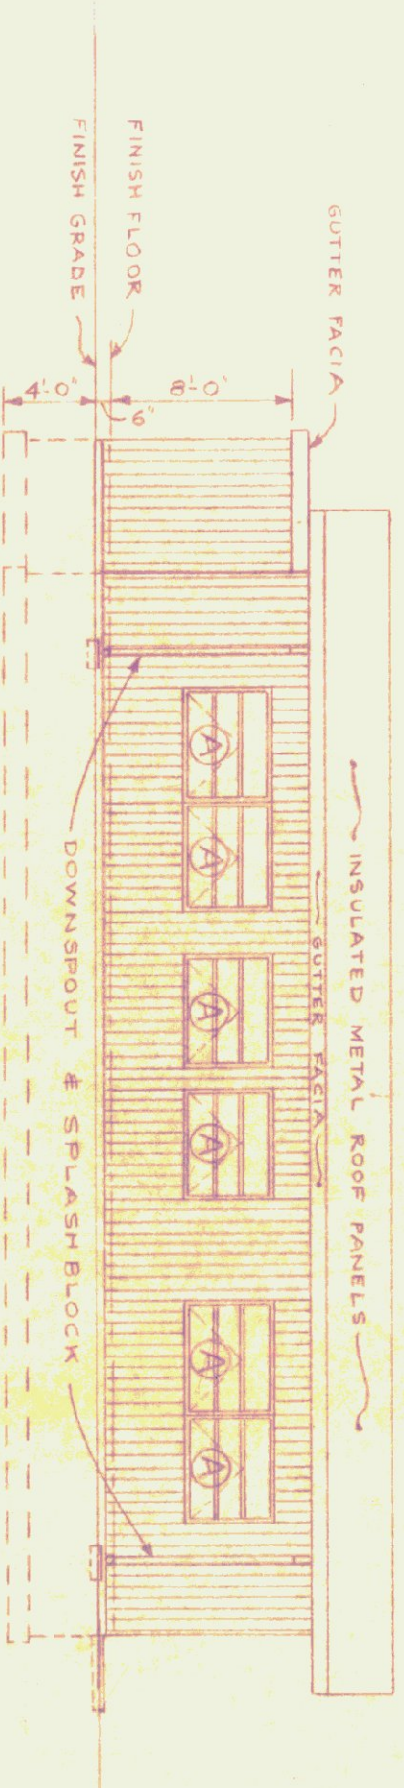


EAST ELEVATION
SCALE 1/8" = 1'-0"

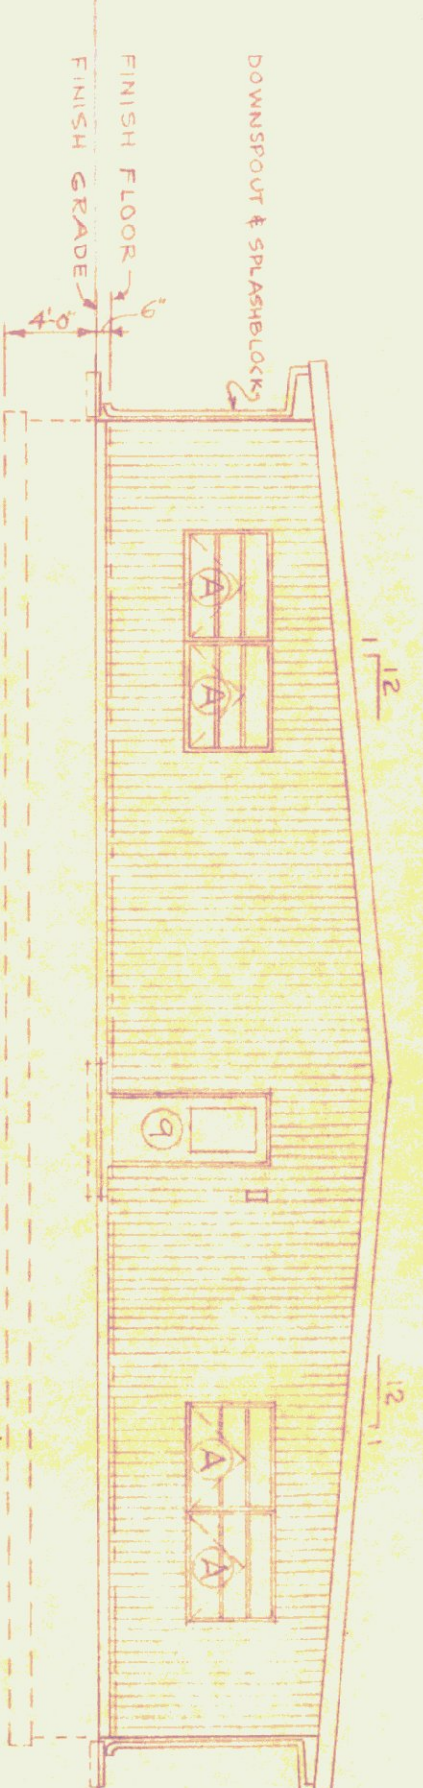


NORTH ELEVATION
SCALE 1/8" = 1'-0"

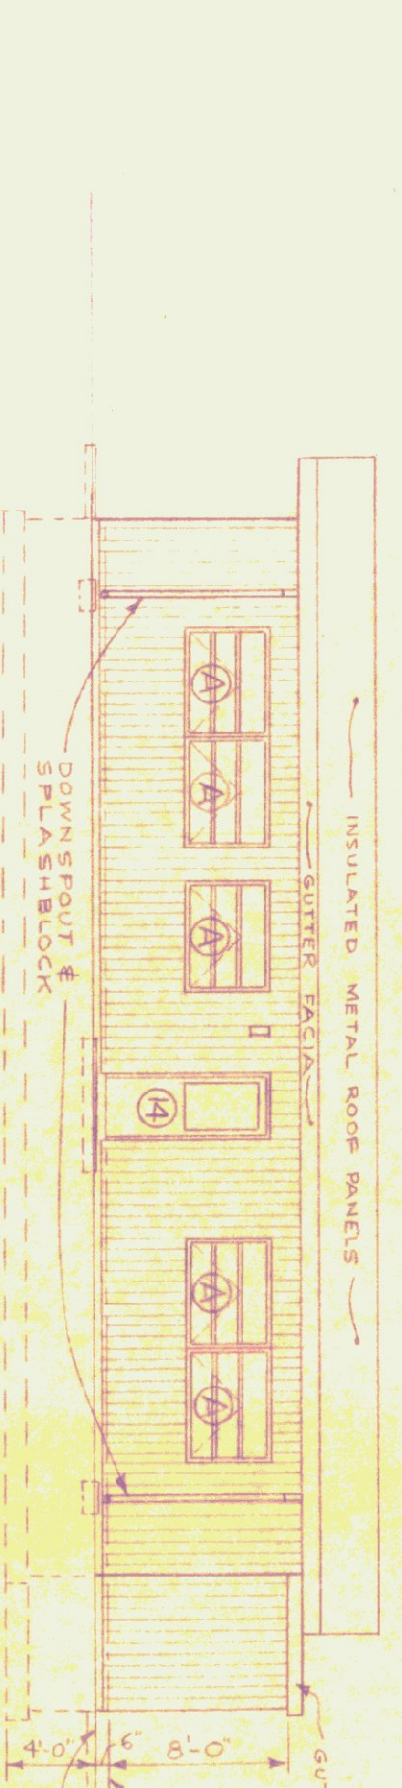


WEST ELEVATION
SCALE 1/8" = 1'-0"

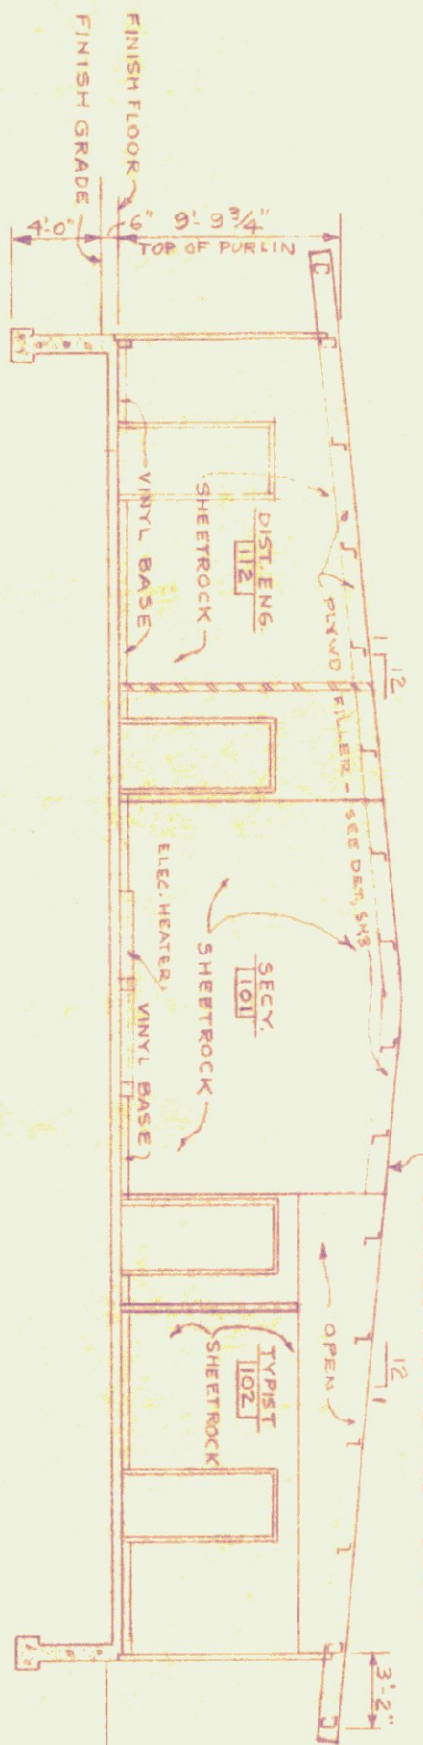


SECTION Z-Z
SCALE 1/8" = 1'-0"

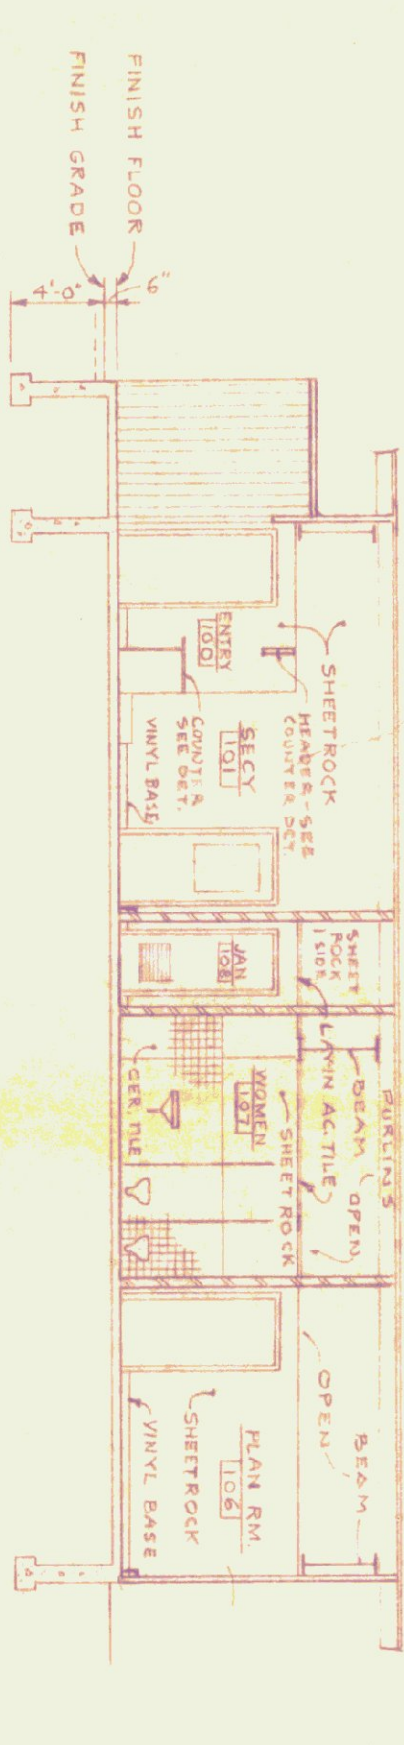

SECTION Y-Y
SCALE 1/8" = 1'-0"

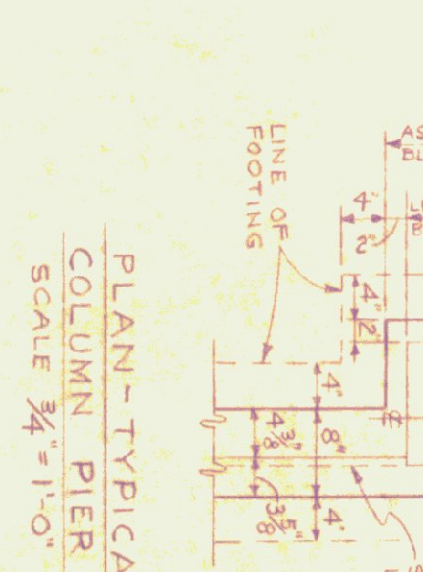

PLAN-TYPICAL COLUMN PIER
SCALE 3/4" = 1'-0"

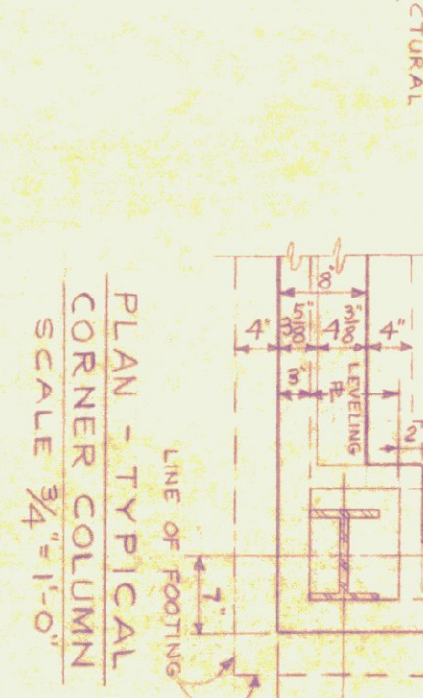


PLAN-TYPICAL CORNER COLUMN
SCALE 3/4" = 1'-0"




SECTION-TYPICAL FOUNDATION WALL
SCALE 3/4" = 1'-0"








SECTION-TYPICAL COLUMN PIERS
SCALE 3/4" = 1'-0"

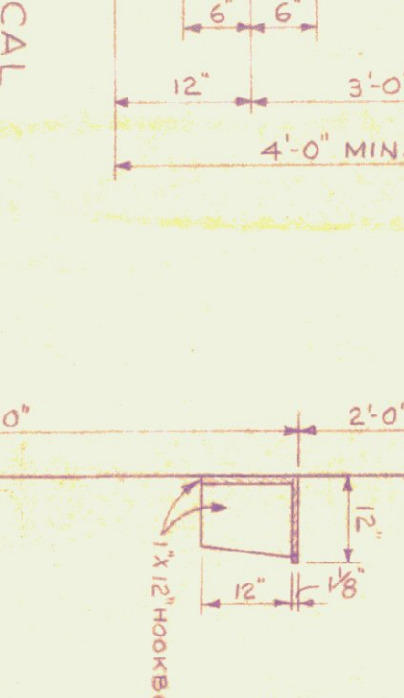

JANITOR SHELF DETAIL
SCALE 1/2" = 1'-0"

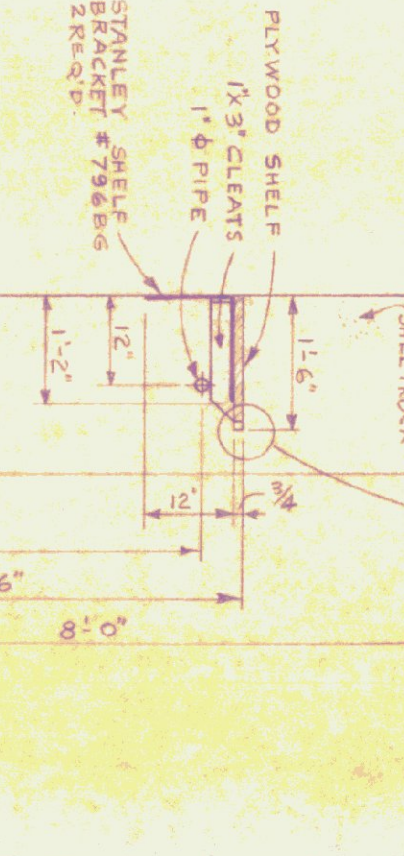

COAT ROOM SHELF DETAIL
SCALE 1/2" = 1'-0"

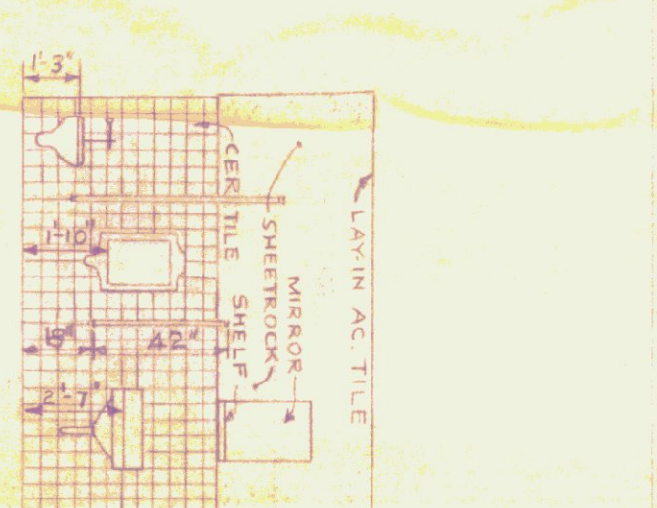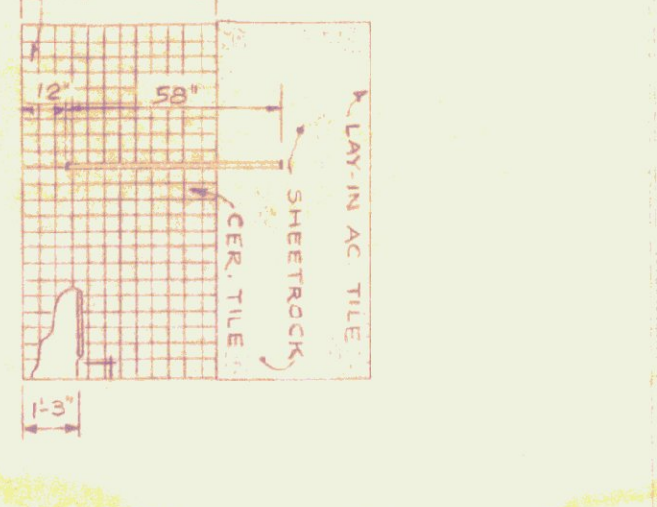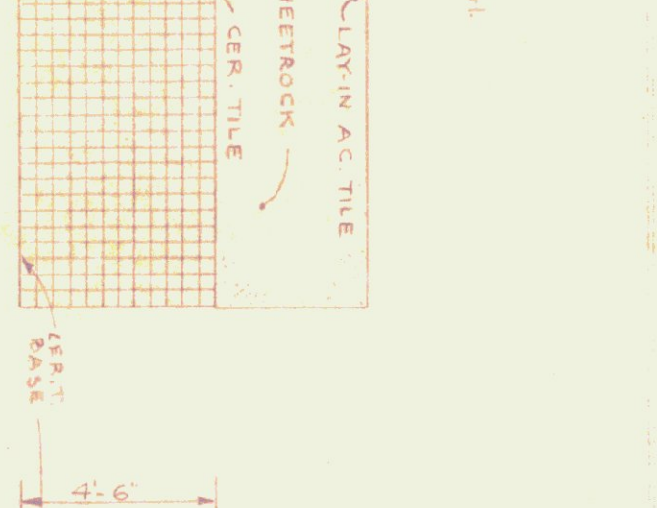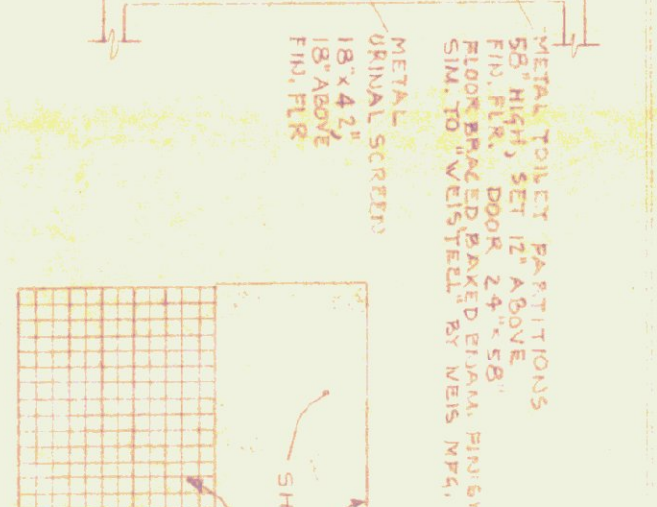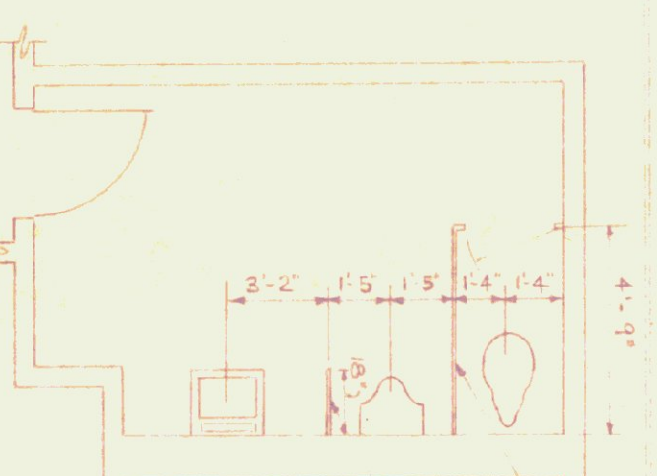

MEN'S TOILET ROOM 107
SCALE 1/4" = 1'-0"

NORTH WALL
SCALE 1/4" = 1'-0"








WEST WALL
SCALE 1/4" = 1'-0"

NORTH WALL
SCALE 1/4" = 1'-0"

EAST WALL
SCALE 1/4" = 1'-0"

SOUTH WALL
SCALE 1/4" = 1'-0"

NOTE: SEE PLUMBING FIXTURE SCHED (SPEC) FOR MIRROR RAFFER HOLDERS.

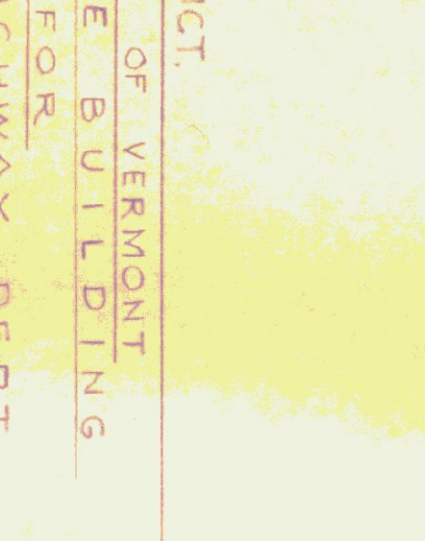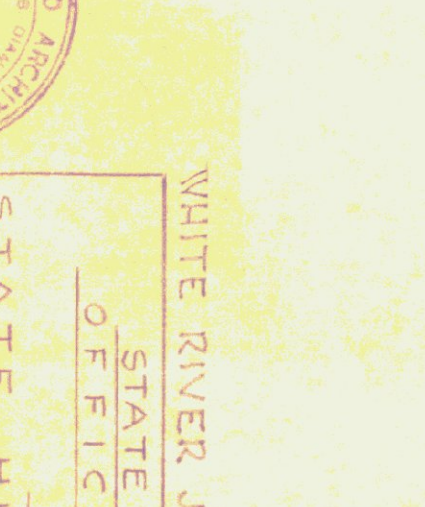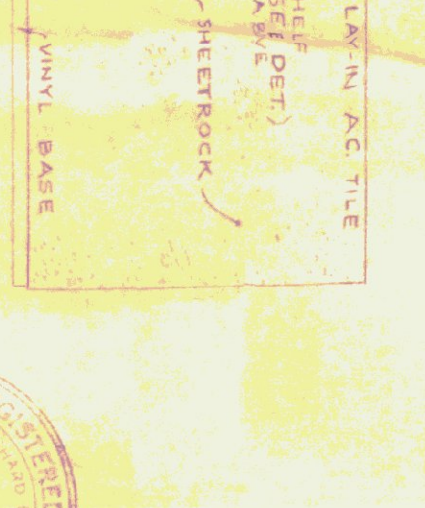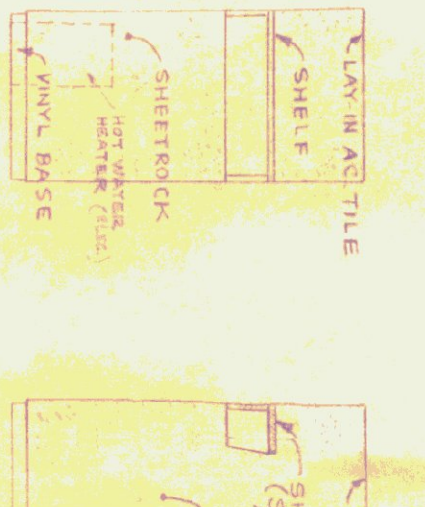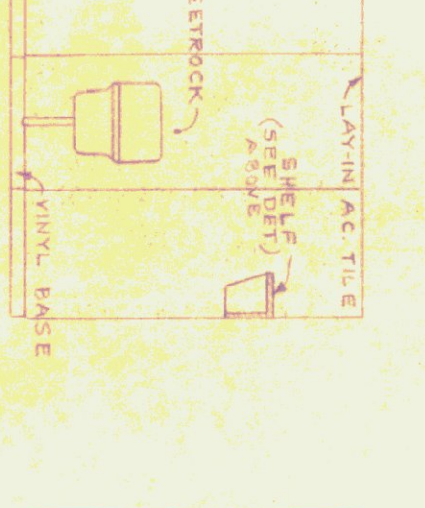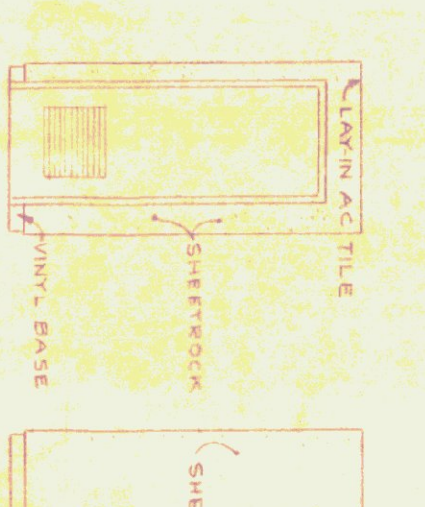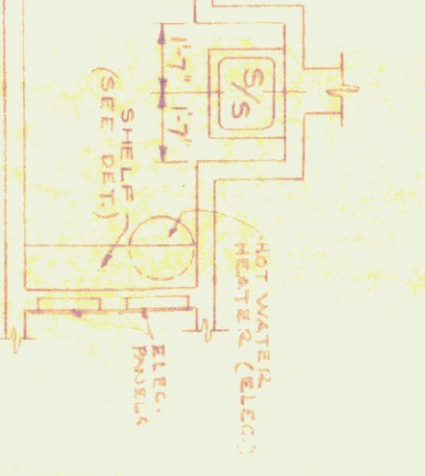

PLAN

WEST WALL

NORTH WALL

EAST WALL

SOUTH WALL



STATE OF VERMONT
OFFICE BUILDING
FOR
STATE HIGHWAY DEPT.
DATE 10-1-65
5368
RICHARD B. DIAMOND & ASSOC.
ARCHITECTS-ENGINEERS
PLANSHEET 2

