


FLOOR PLAN
1/4" = 1'-0"

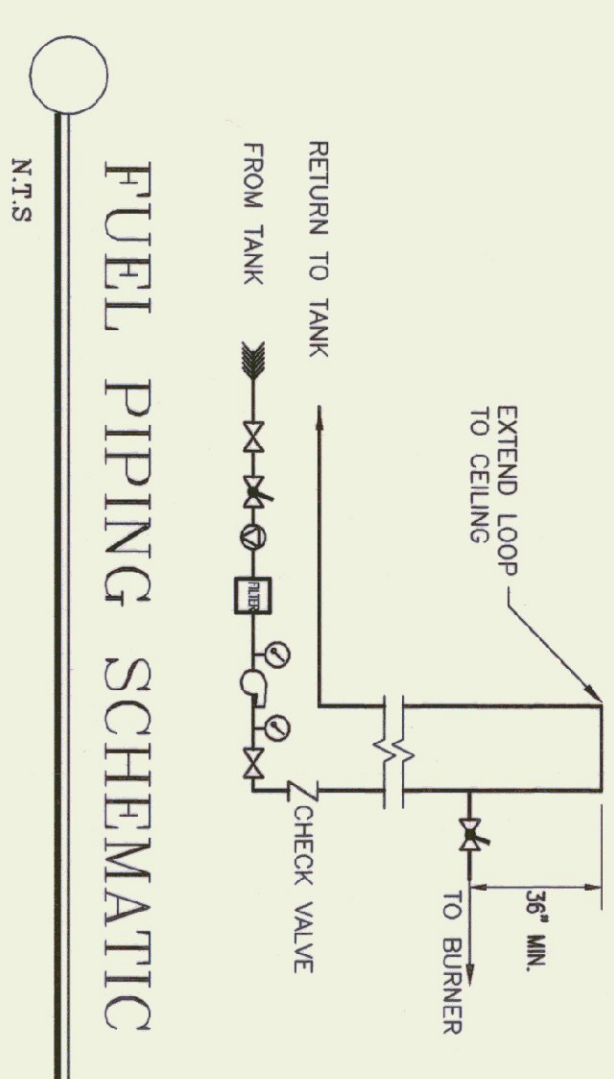


FURNACE SCHEDULE


MAKE / MODEL	BTU OUTPUT	FUEL	GPM	BLOWER HP	VOLTAGE	FLUE
JACKSON - CHURCH 280-23	224,000	# 2 OIL	2440	3/4	115	9"

LEGEND


- ▭ FIRE DAMPER
- ▭ VOLUME DAMPER
- ⊗ THERMOSTAT X, O = OIL, W = WOOD
- ⊗ FULL PORTED BALL VALVE
- ⊗ FURNACE VALVE, SPRING LOADED W/LEVER & WIRE TO FUSIBLE LINK & BURNER
- ⊗ WESTER OSV
- ⊗ PRESSURE VACUUM GAUGE
- ⊕ UNION
- ⊕ AUTOMATIC AIR VENT ON 6" AIR CHAMBER
- ⊕ STRIP ON ADJUST SET @ 1/2"
- ⊕ STRAINER
- ⊕ DRAIN
- ⊕ VIBRATION ISOLATOR
- ⊕ FUEL OIL TRANSFER PUMP
- ⊕ BURNER SAFETY SWITCH

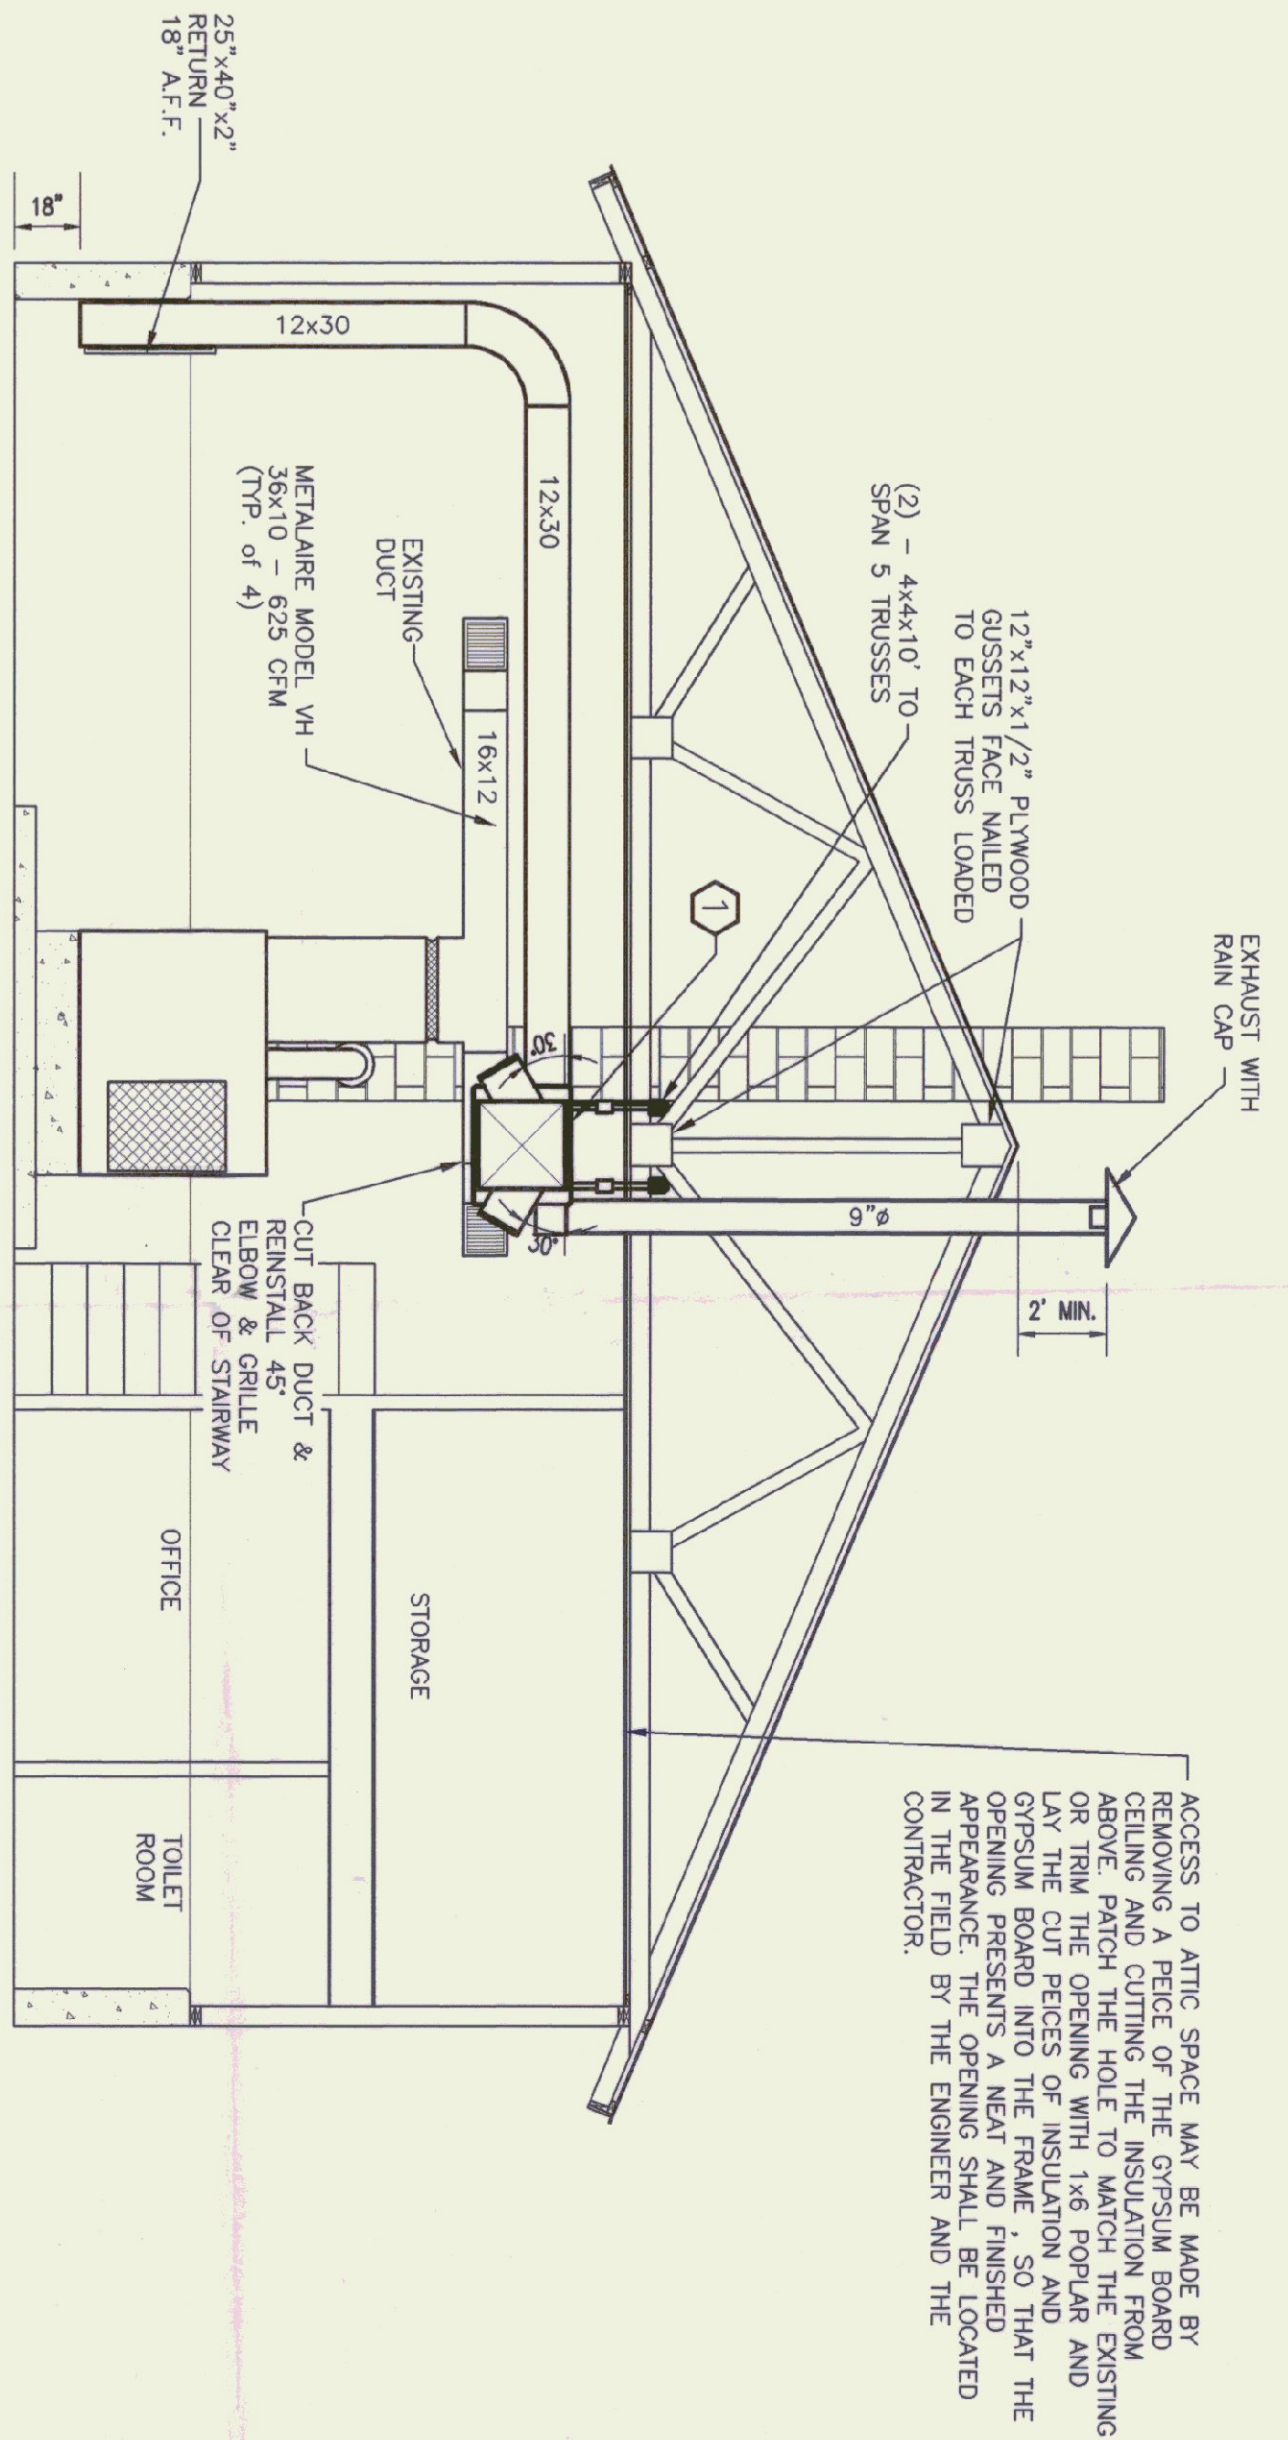


SECTION A
1/4" = 1'-0"

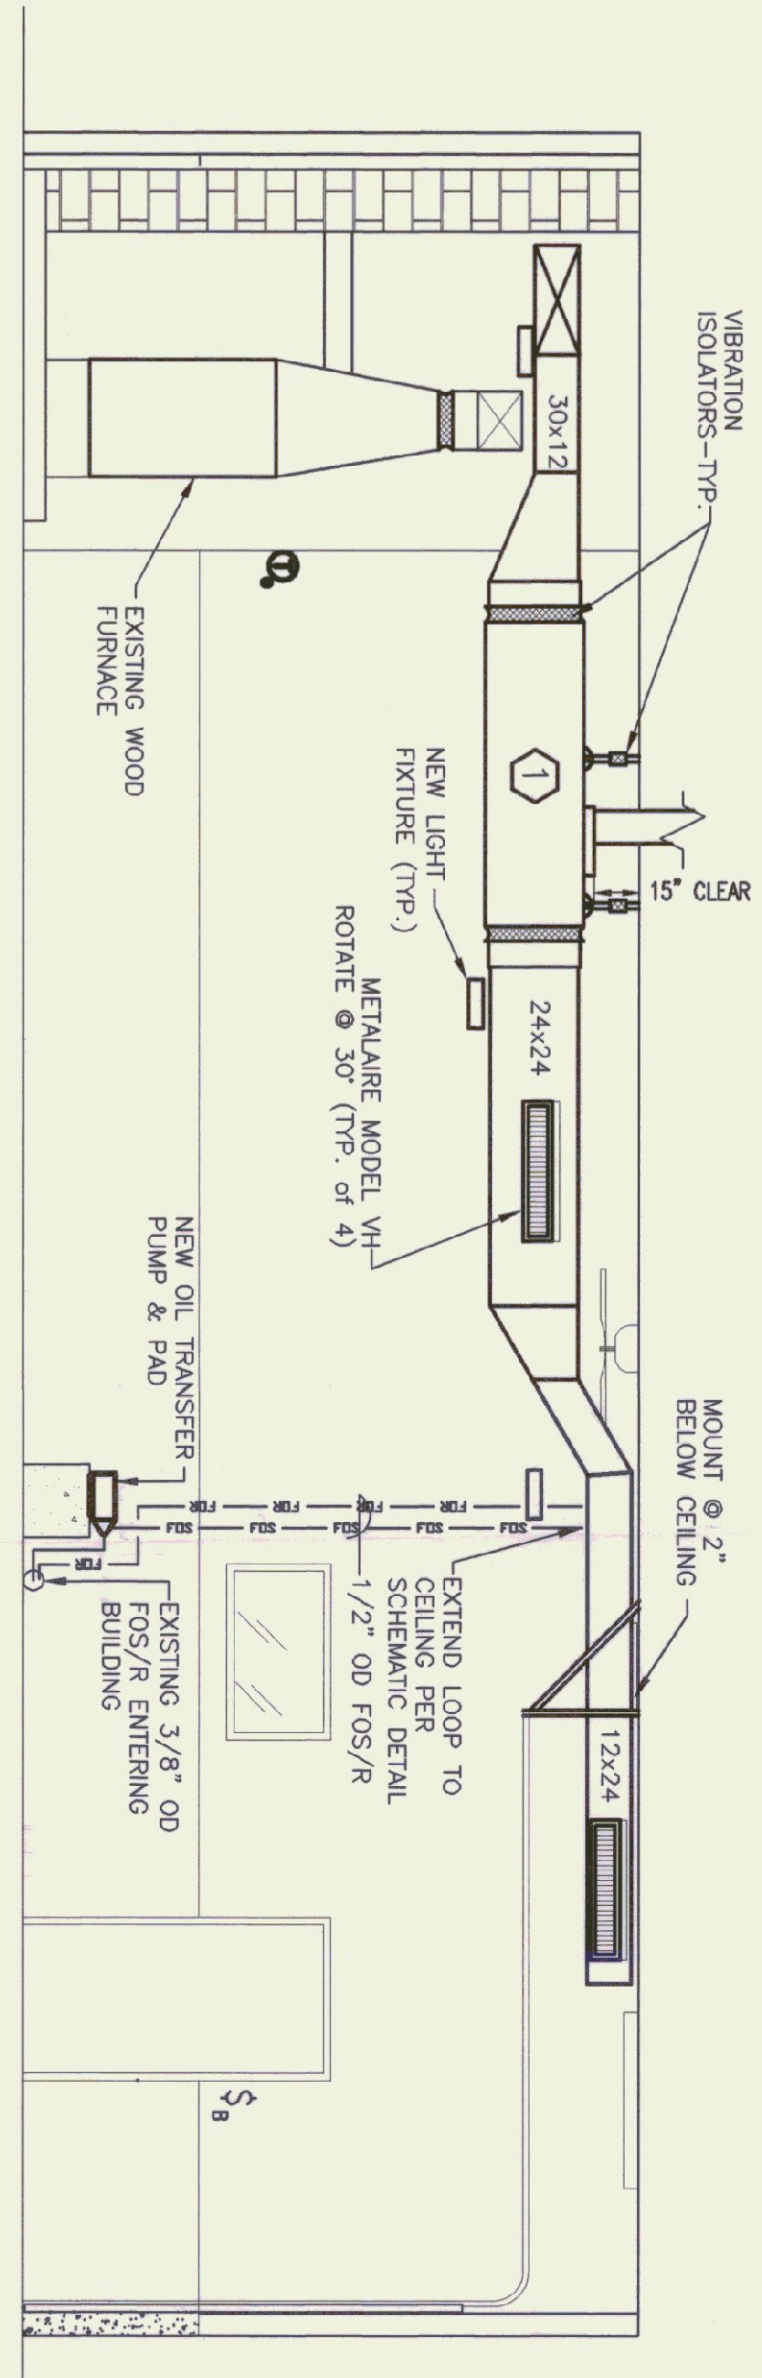

SECTION B
1/4" = 1'-0"

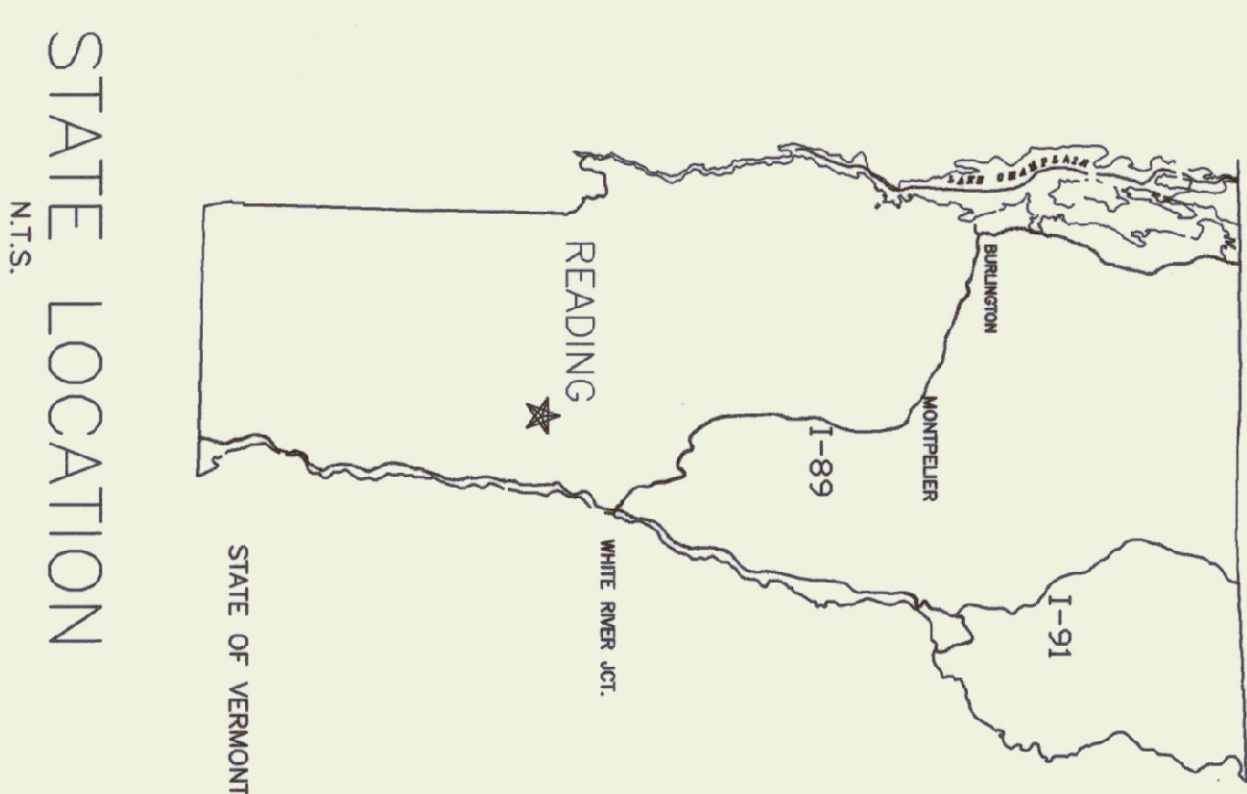

STATE LOCATION
N.T.S.

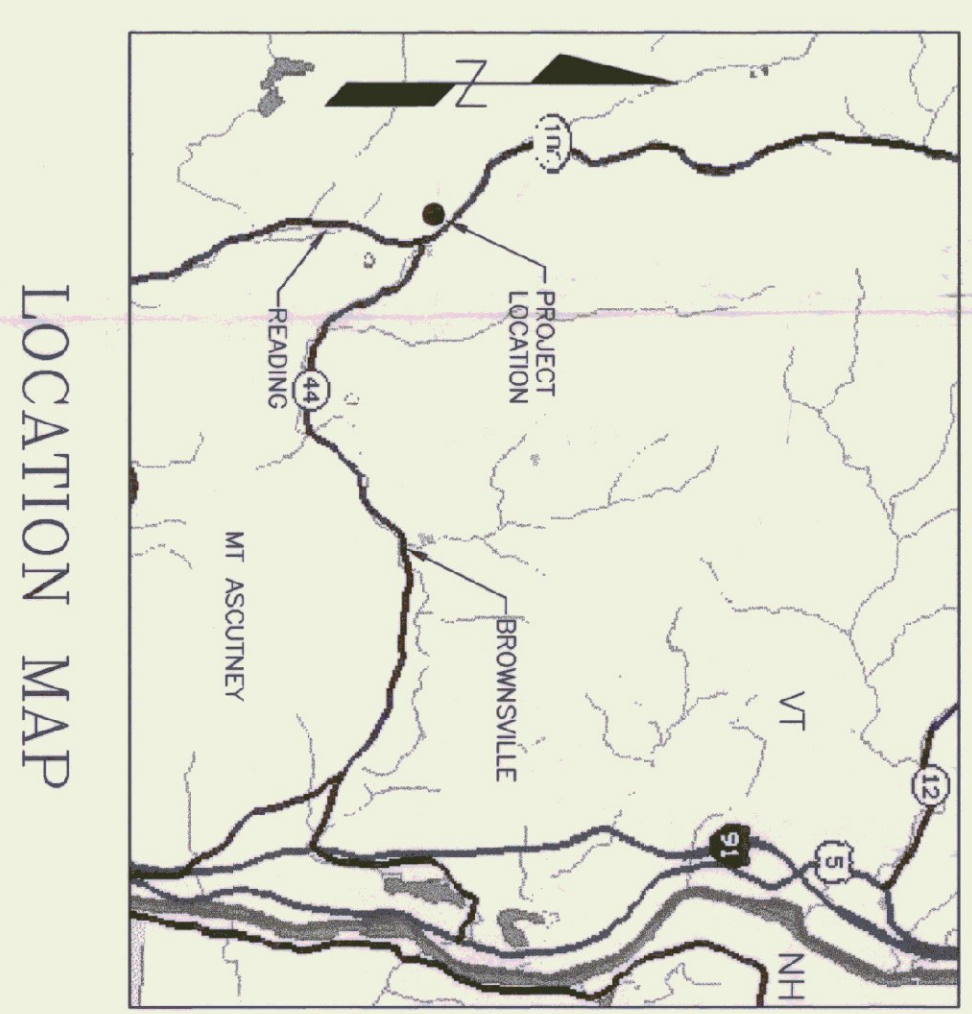

LOCATION MAP

ACCESS TO ATTIC SPACE MAY BE MADE BY REMOVING AND CUTTING THE INSULATION ABOVE PATCH THE HOLE TO MATCH THE EXISTING OR TRIM THE CUT PIECES OF INSULATION AND LAY THE CUT PIECES OF INSULATION AND GYPSUM BOARD INTO THE FRAME, SO THAT THE OPENING PRESENTS OPENING WITH FINISHED IN THE FIELD BY THE ENGINEER AND THE CONTRACTOR.



STATE OF VERMONT
Department of Buildings & General Services
Agency of Administration
Montpelier, Vermont

READING - A.O.T. GARAGE
HEATING
NEW PLAN & SECTIONS

REVISIONS

SCALE: AS NOTED
DATE: APRIL 30, 1999
DRAWN BY: R. PRATT
APPR. BY:

HEATING

PLAN & SECTIONS

M-1

1 OF 1