



PLAN
SCALE: 1/4"=1'-0"

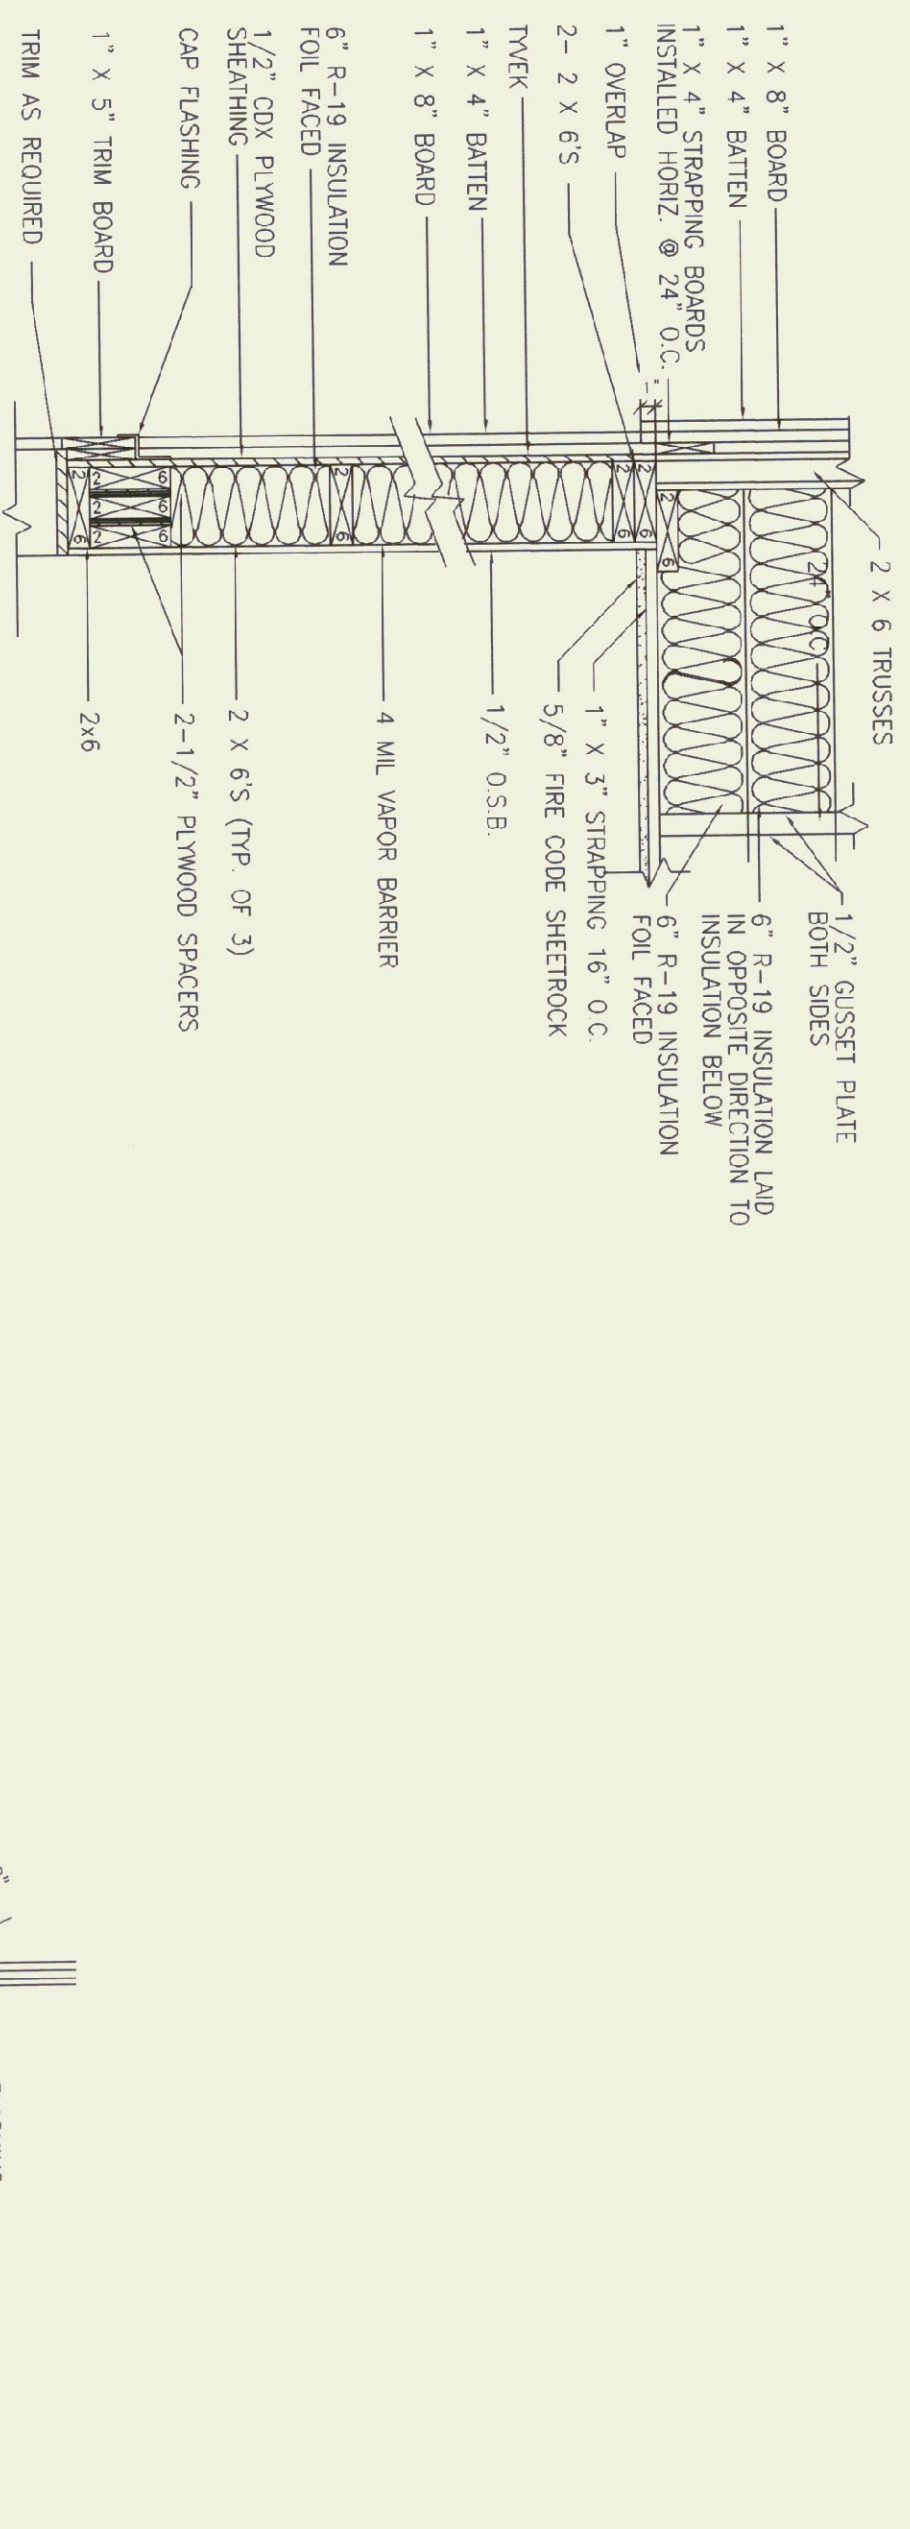


SECTION 2
SCALE: 1"=1'-0"

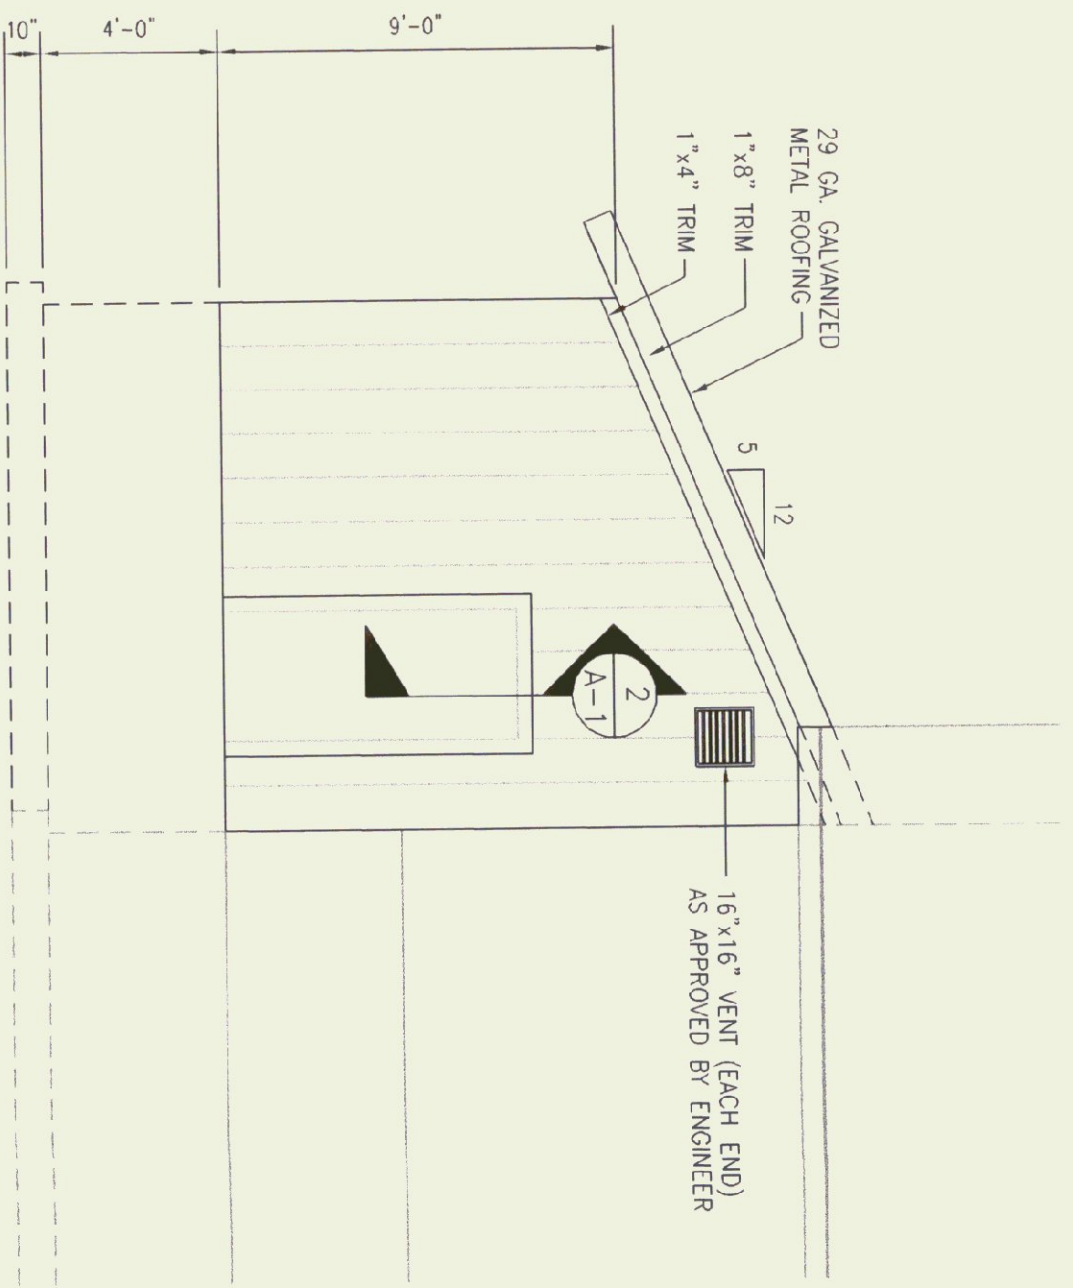



ELEVATION
SCALE: 1/4"=1'-0"

- GENERAL NOTES:**
1. REMOVE AND RE-USE EXISTING EXTERIOR DOOR IN NEW ADDITION.
 2. DRILL, PIN AND GROUT EXISTING CONCRETE WALL AND FOOTINGS TO JOIN NEW CONCRETE WALLS AND FOOTINGS.
 3. STAIN TO BE OIL BASE SEMI-TRANSPARENT SHERWIN WILLIAMS #3535.

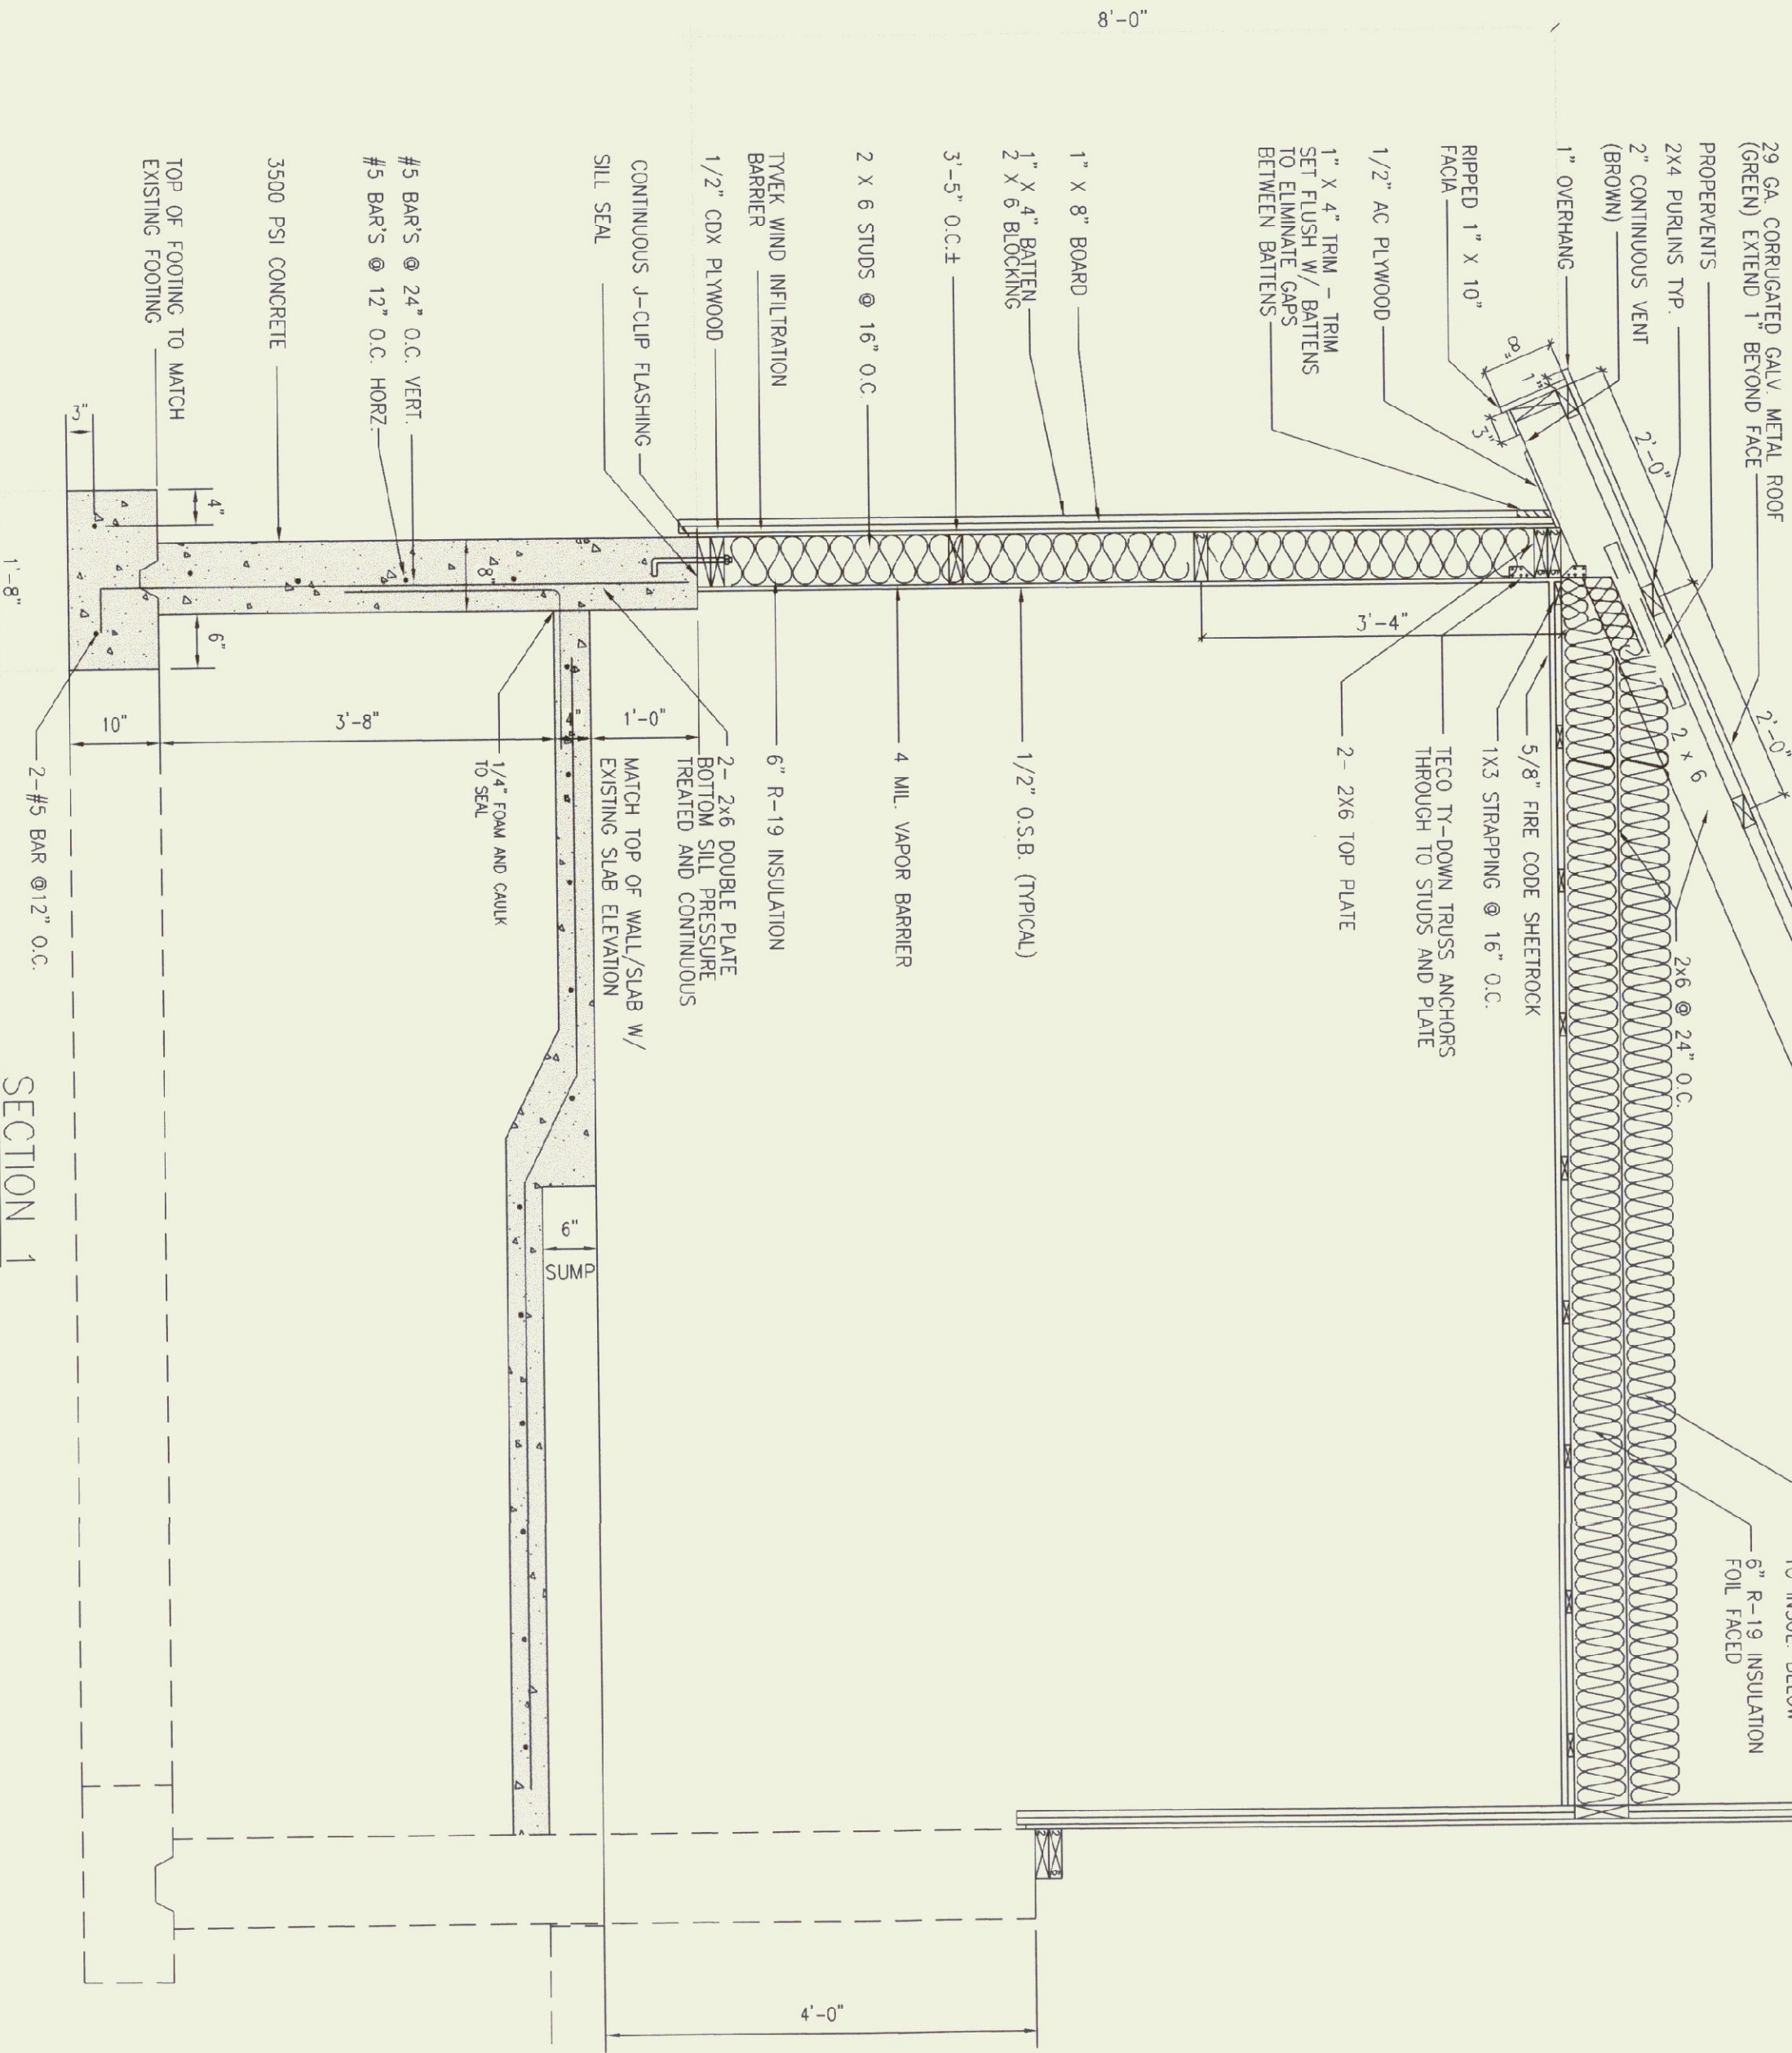


SECTION 1
SCALE: 3/4"=1'-0"

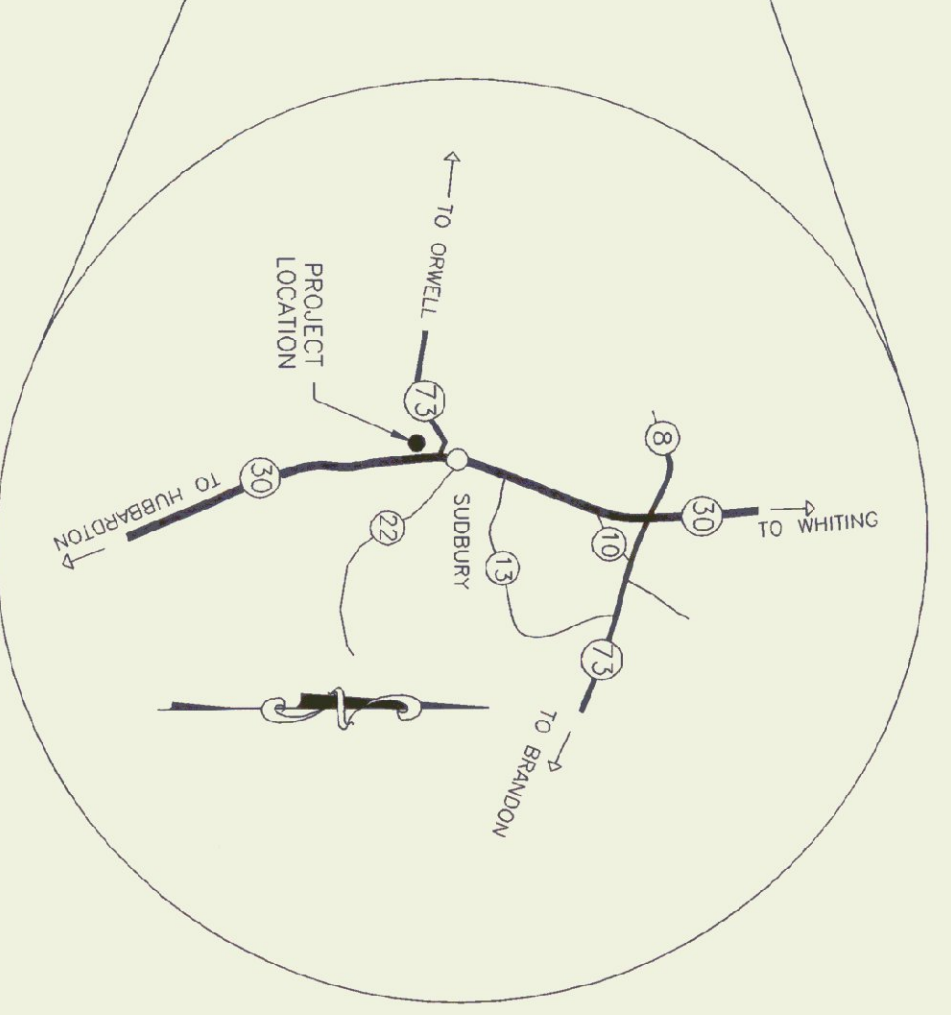

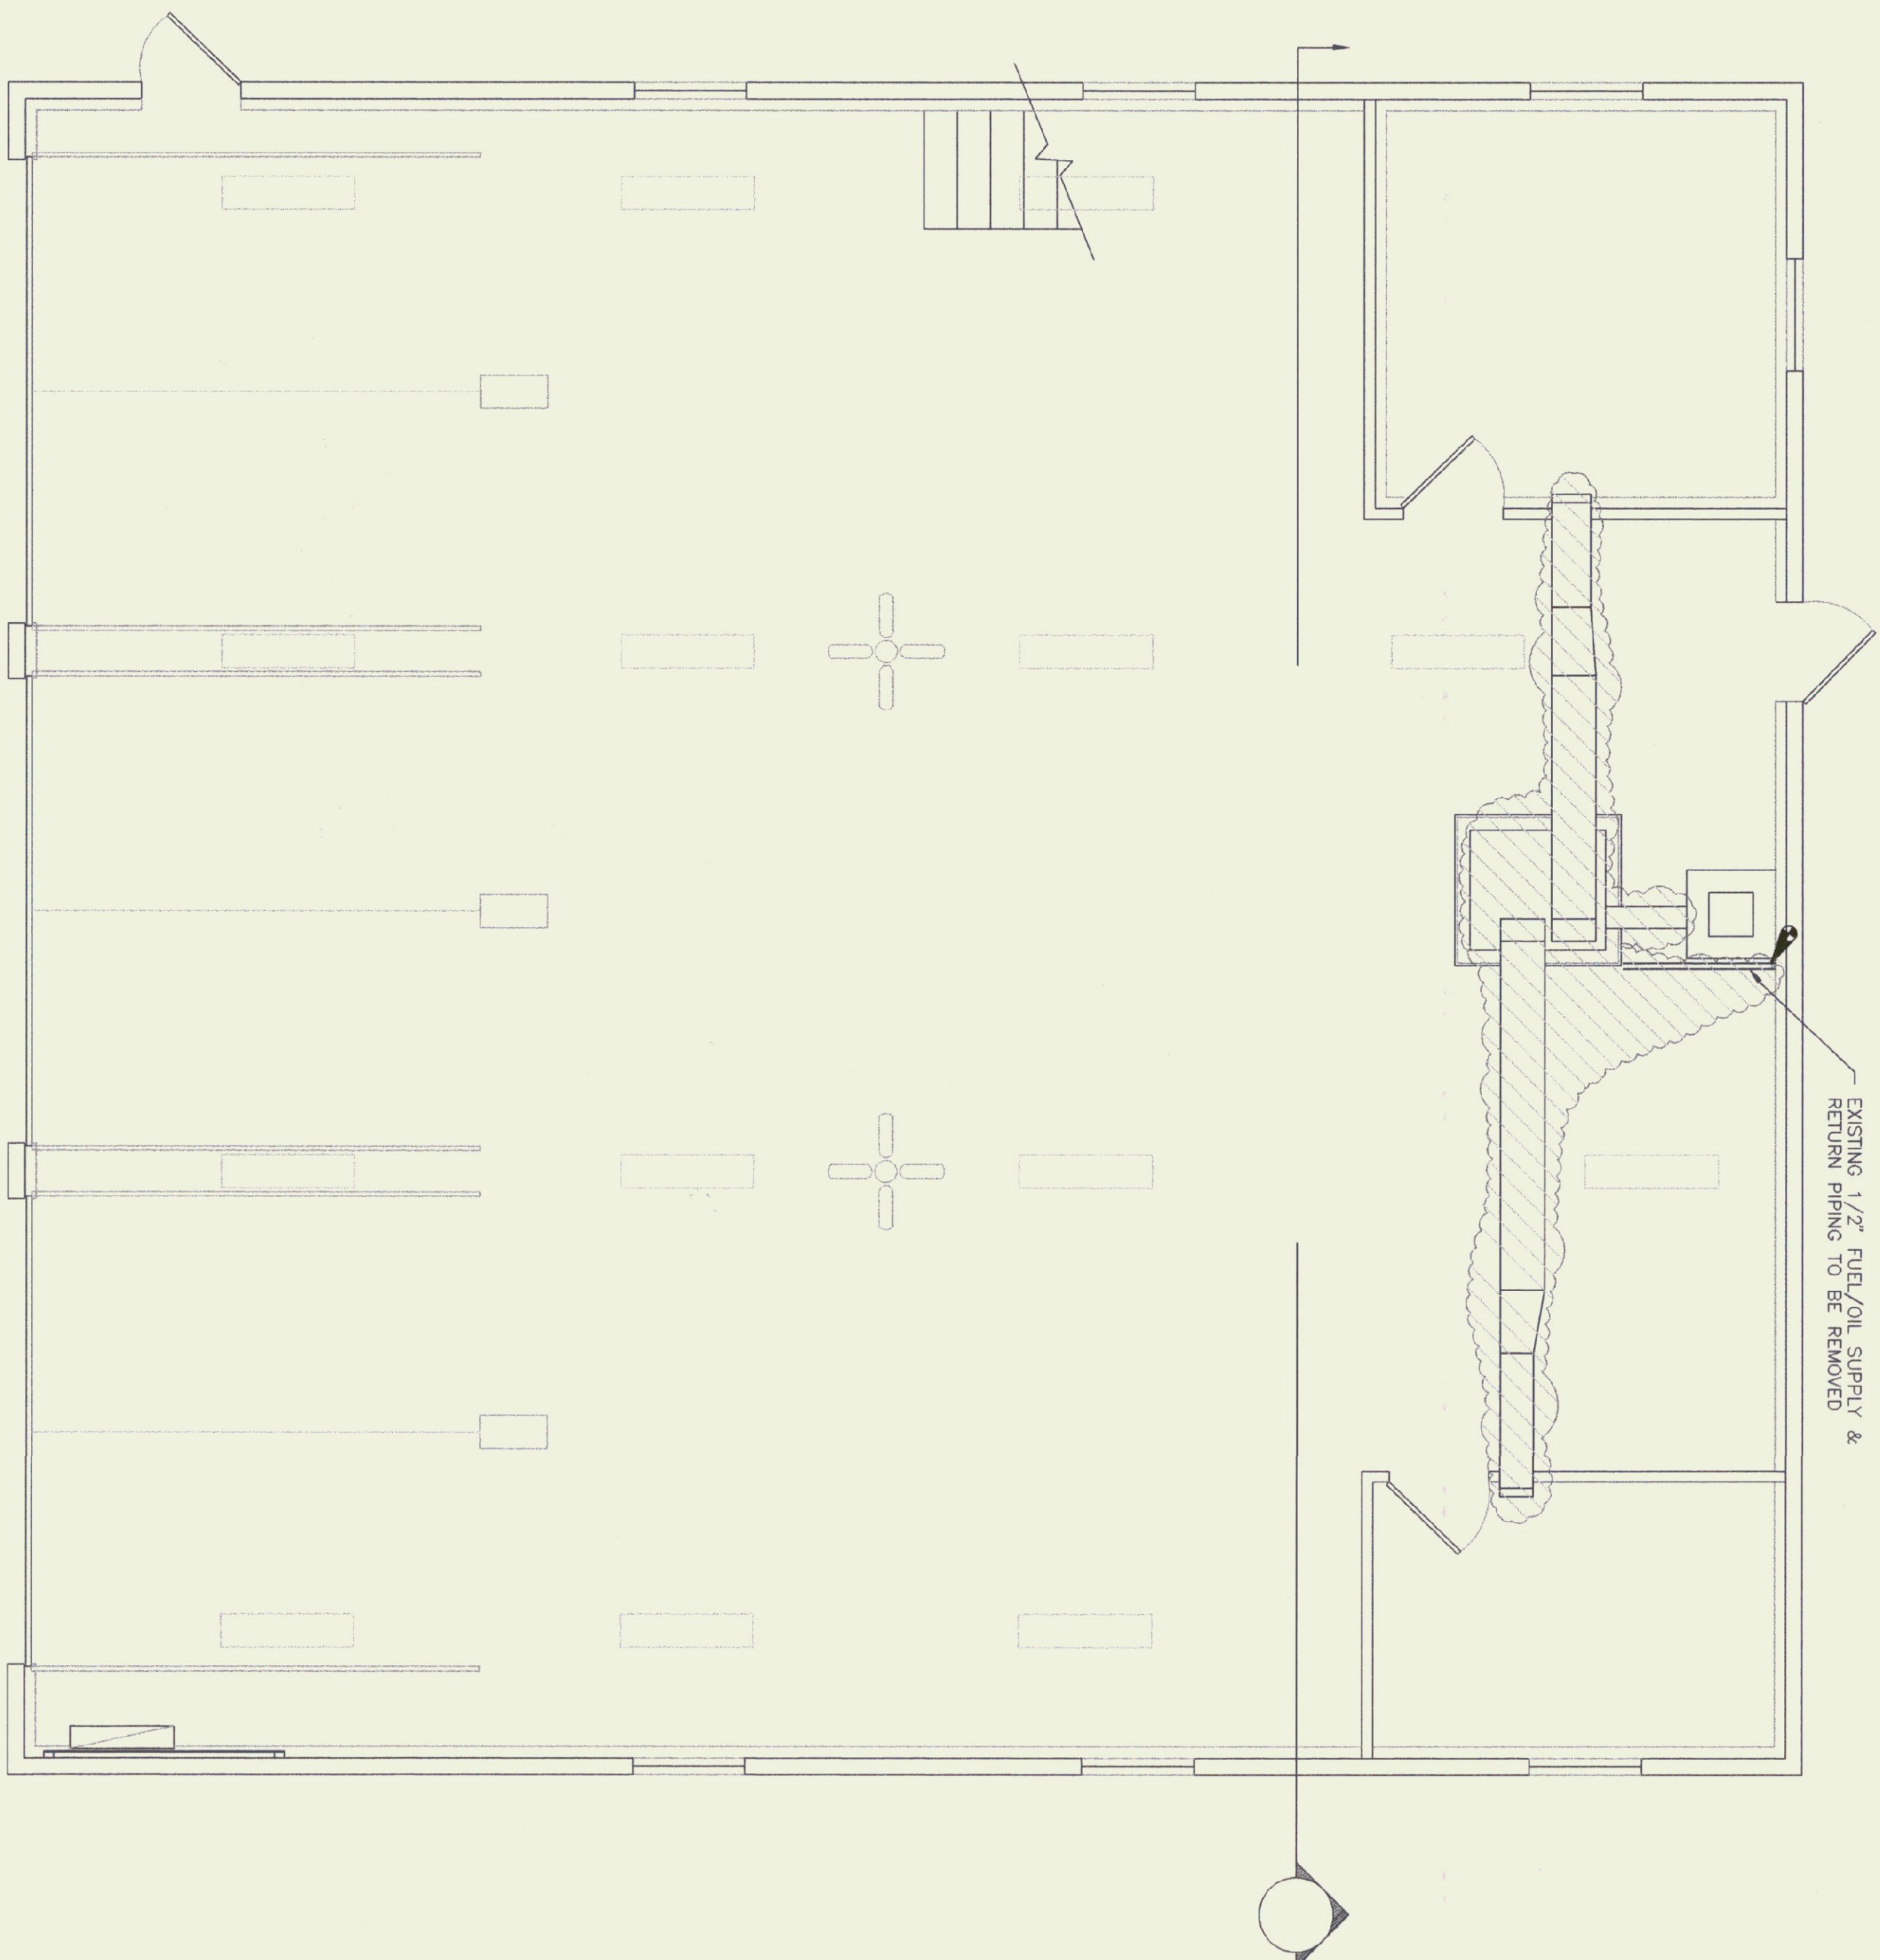


FLOOR PLAN
1/4" = 1'-0"

LEGEND	
	BALL VALVE
	FUSE-MATIC VALVE
	UNION
	SPRING ISOLATOR
	CHECK VALVE
	CONNECTION BETWEEN EXIST. & NEW
	WEBSTER OSV
	THERMOSTAT MOUNT @ 5' A.F.F.
	FUEL/OIL TRANSFER PUMP
	PRESSURE GAUGE
	TO BE REMOVED

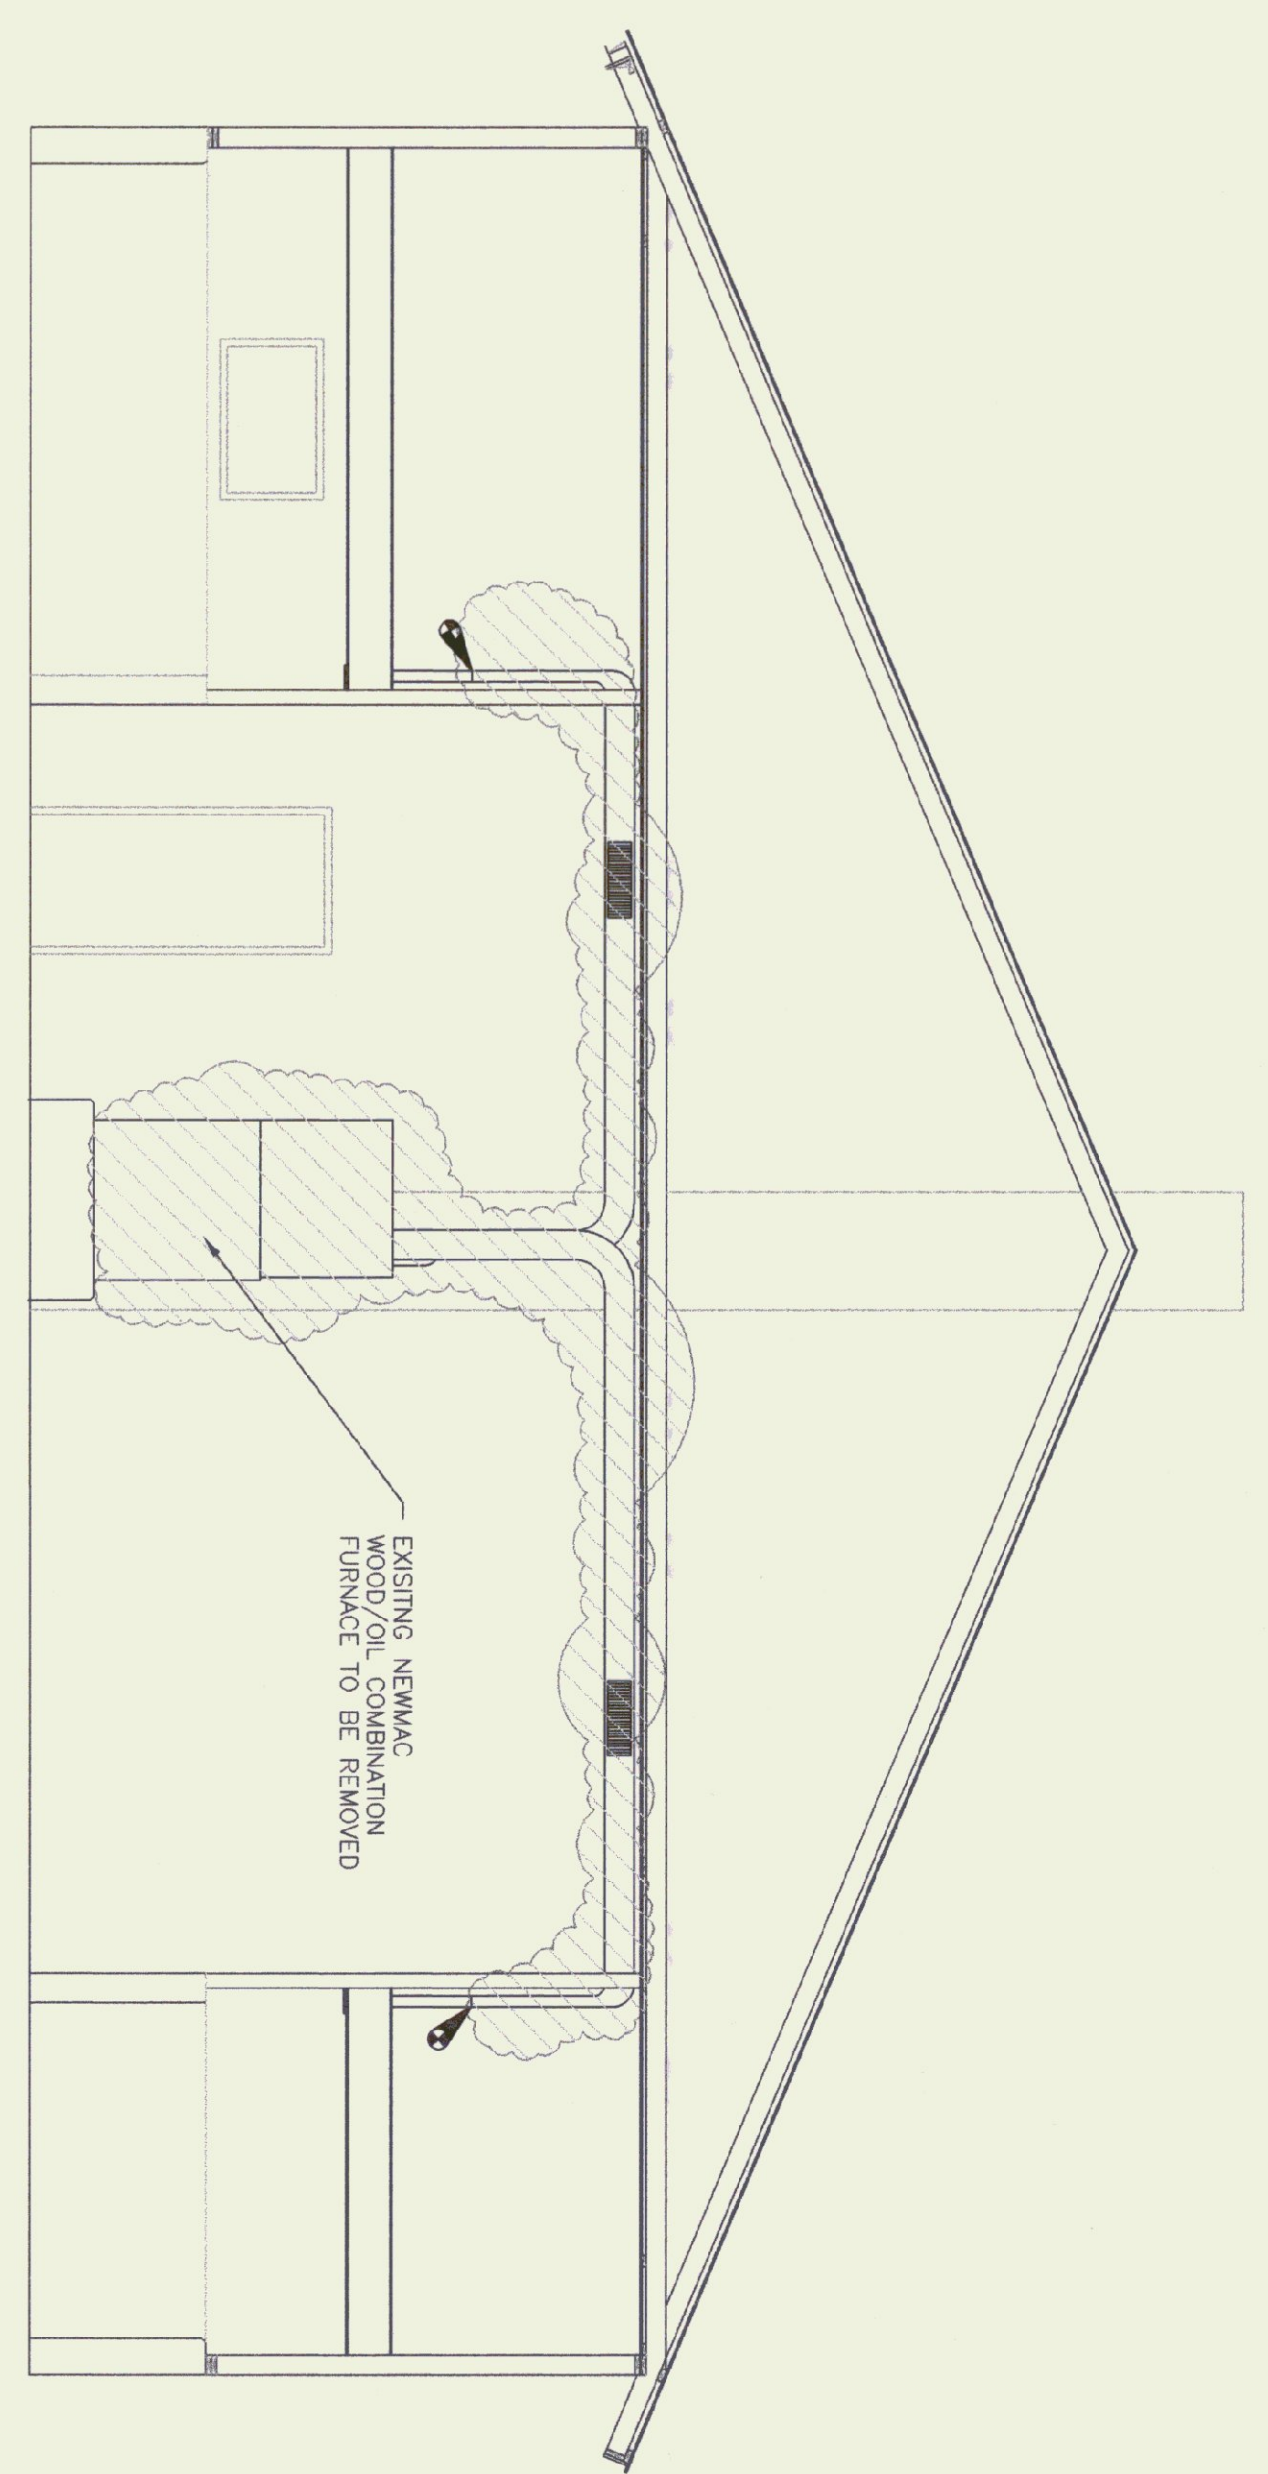


SECTION
1/4" = 1'-0"

NOTES:
EXISTING FURNACE TO REMAIN OPERATIONAL UNTIL THE NEW OIL FURNACE IS FUNCTIONAL.
UNLESS CONTRACTOR PROVIDES ADEQUATE TEMPORARY HEAT.

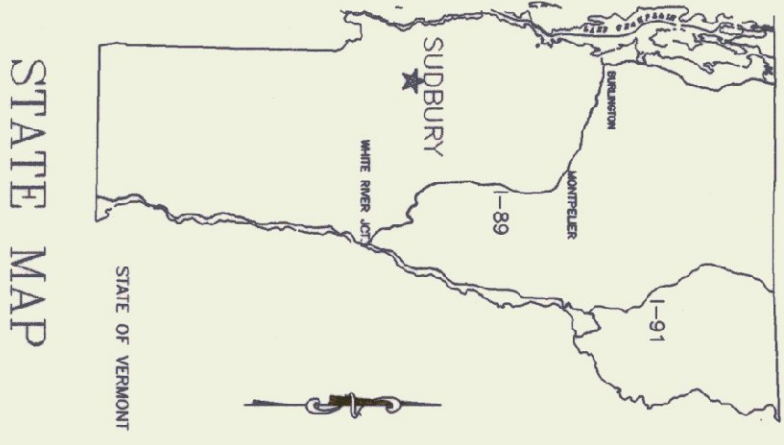


STATE MAP

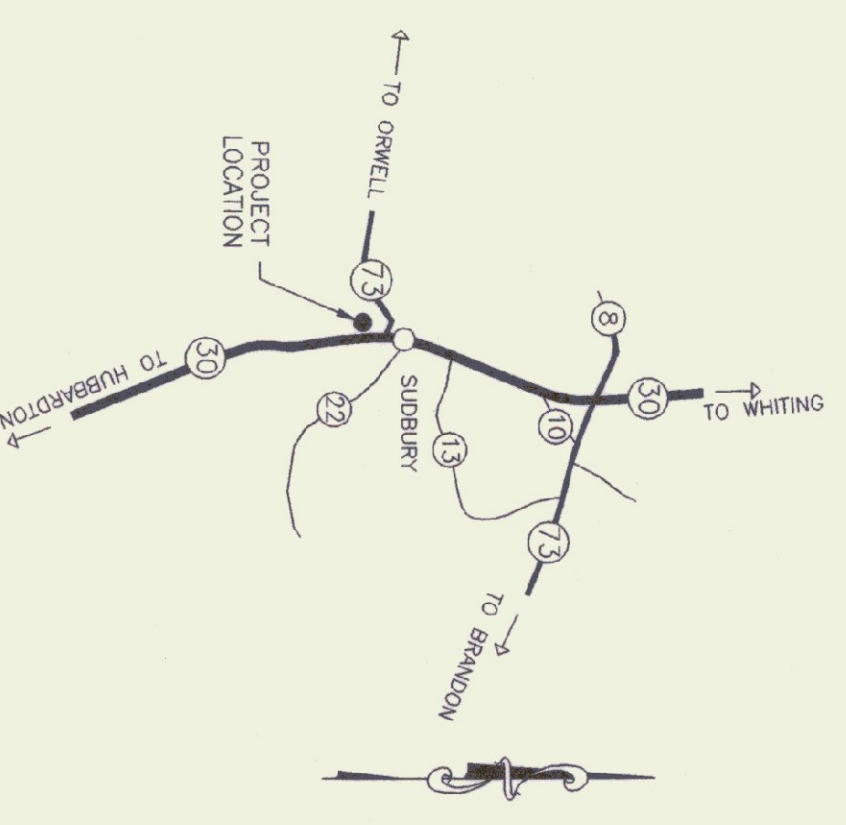

TOWN of SUDBURY MAP


SCALE: AS NOTED DATE: OCT 1996 DRAWN BY: G. D. NORWOOD APPR. BY: <i>[Signature]</i>	REVISIONS	SUDBURY - A.O.T. GARAGE HEATING DEMO PLAN & NOTES SUDBURY, VERMONT	STATE OF VERMONT Department of Buildings & General Services Agency of Administration Montpelier, Vermont
	SUDBURY		
	HEATING		
	DEMO PLAN		
A-1 1 OF 2			

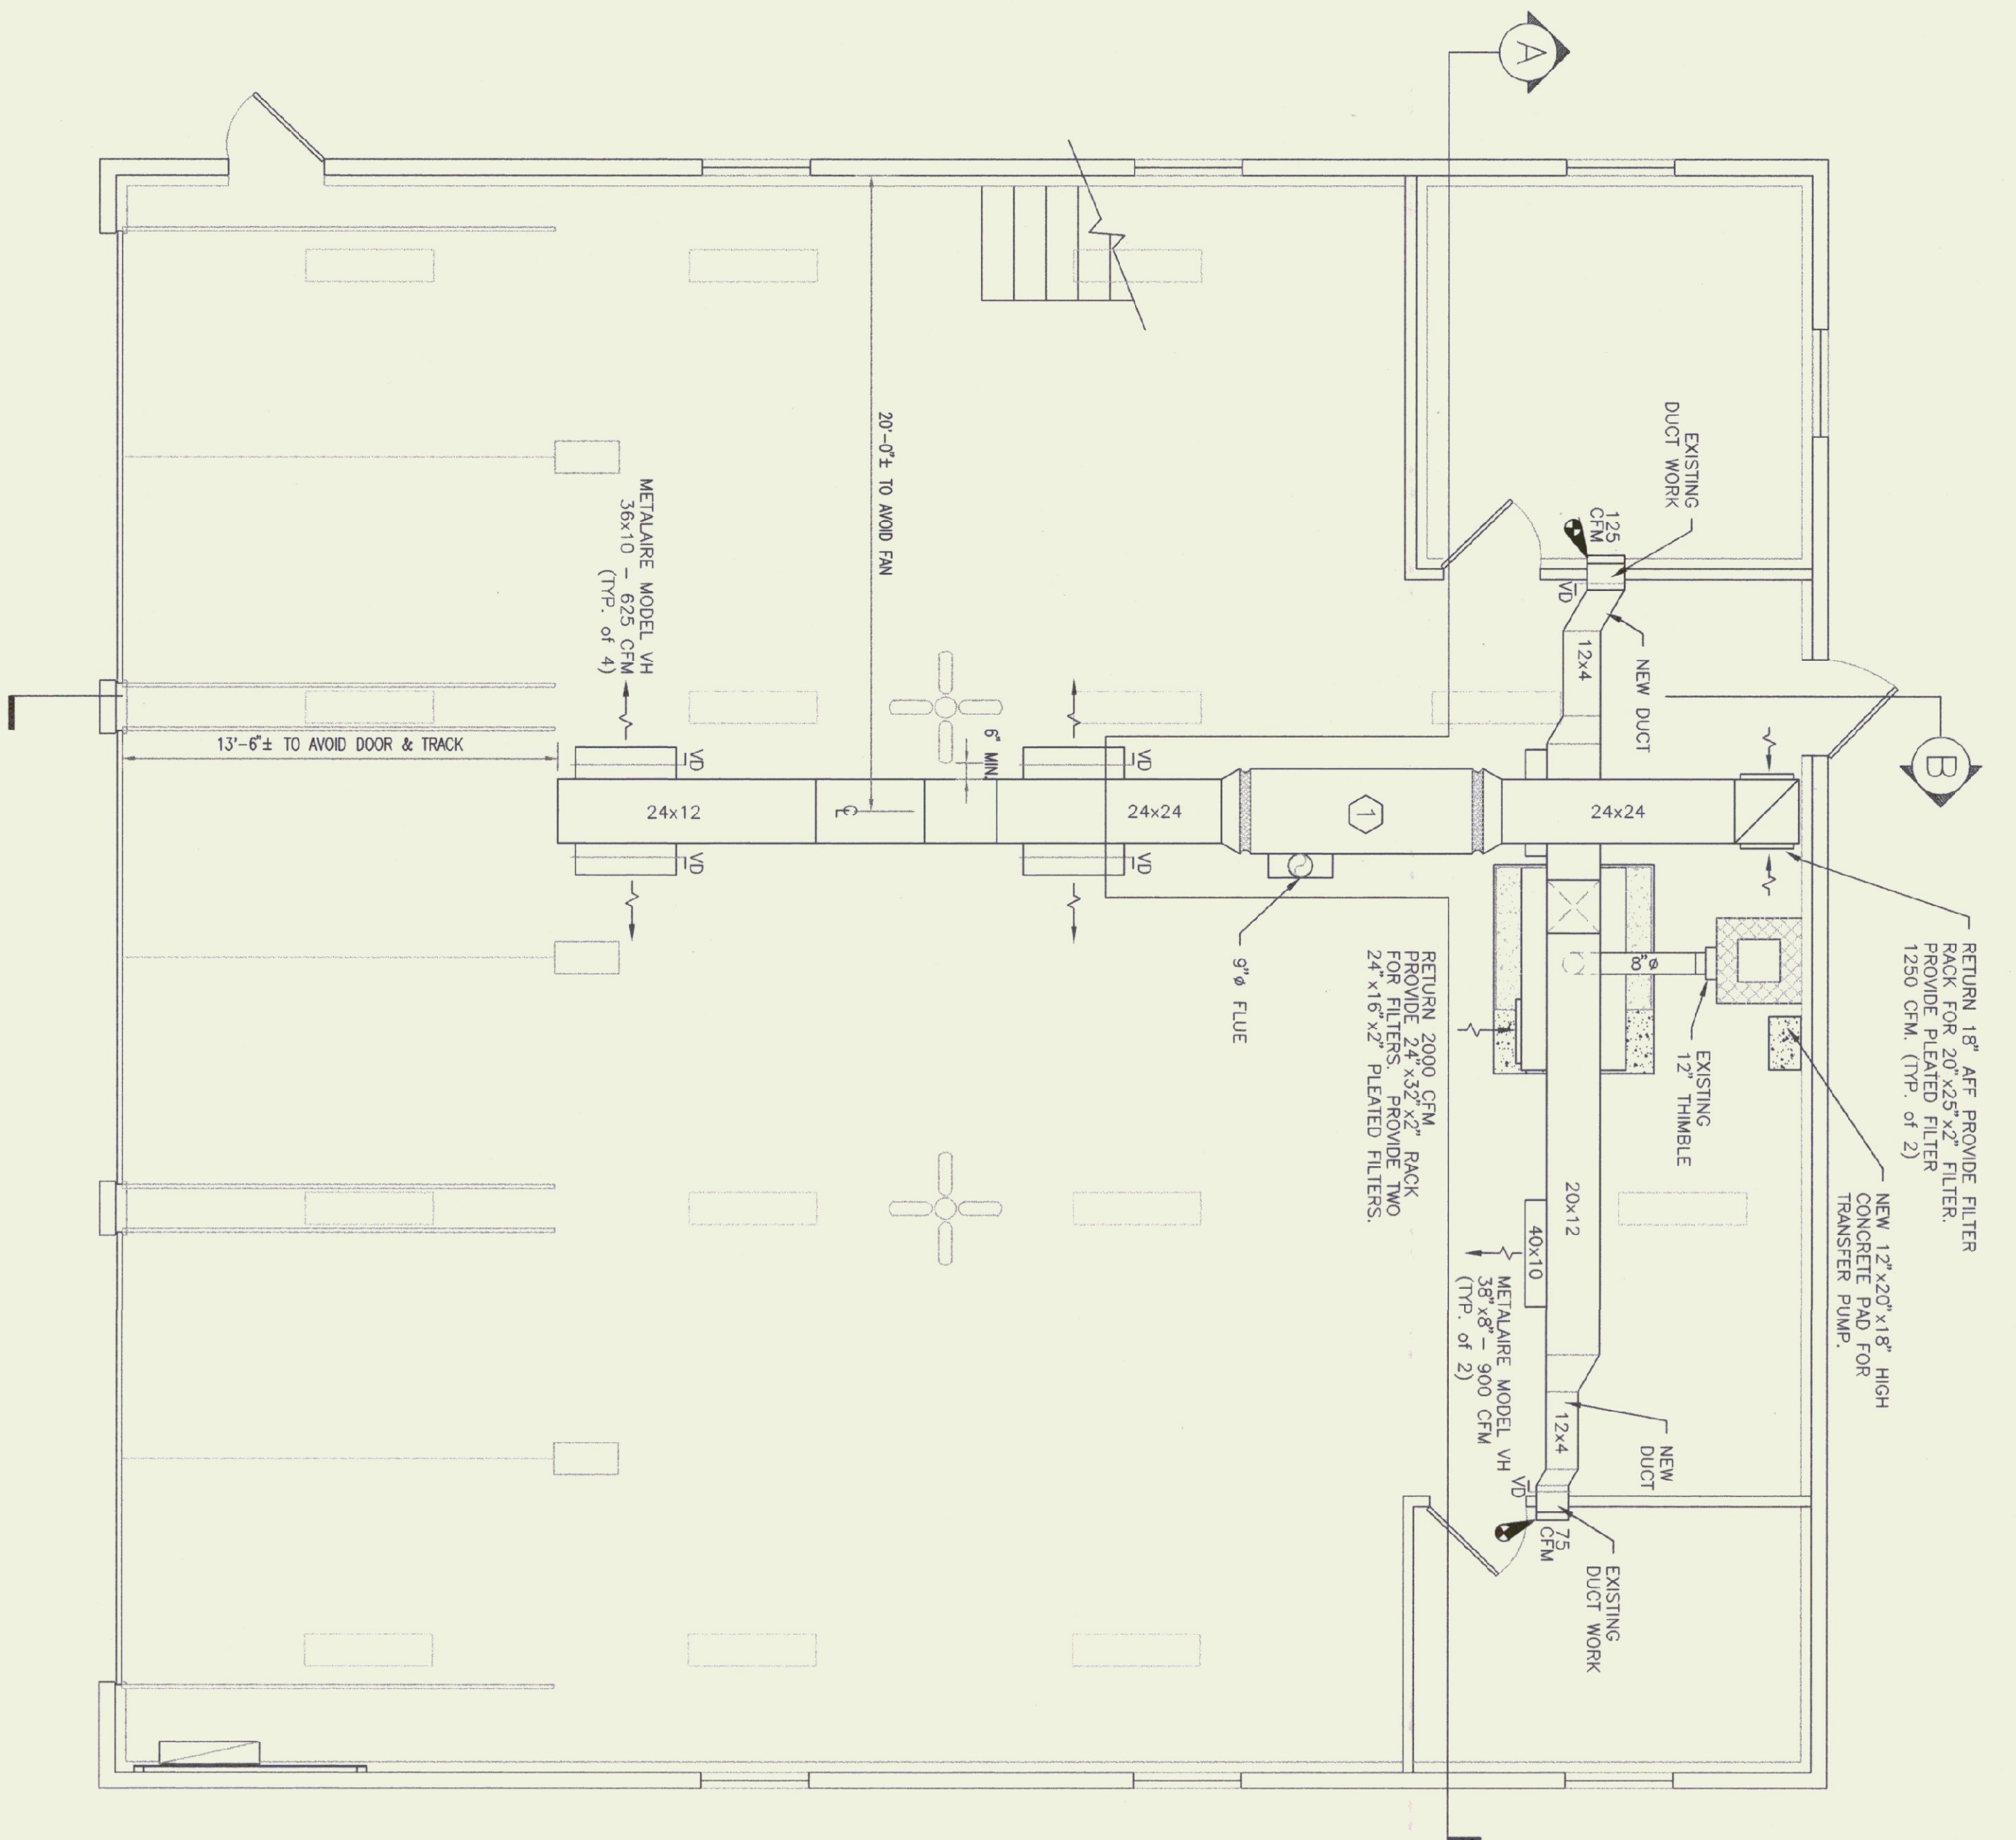


FLOOR PLAN
1/4" = 1'-0"

FURNACE SCHEDULE

MAKE / MODEL	BTU OUTPUT	FUEL	CFM	BLOWERS HP	VOLTAGE	FLUE
1 JACKSON - CHRUCH 280-23	224,000	# 2 OIL	2440	3/4	115	8"
2 LYNDALE 915	250,000	CHUNK WOOD	2000	3/4	115	8"

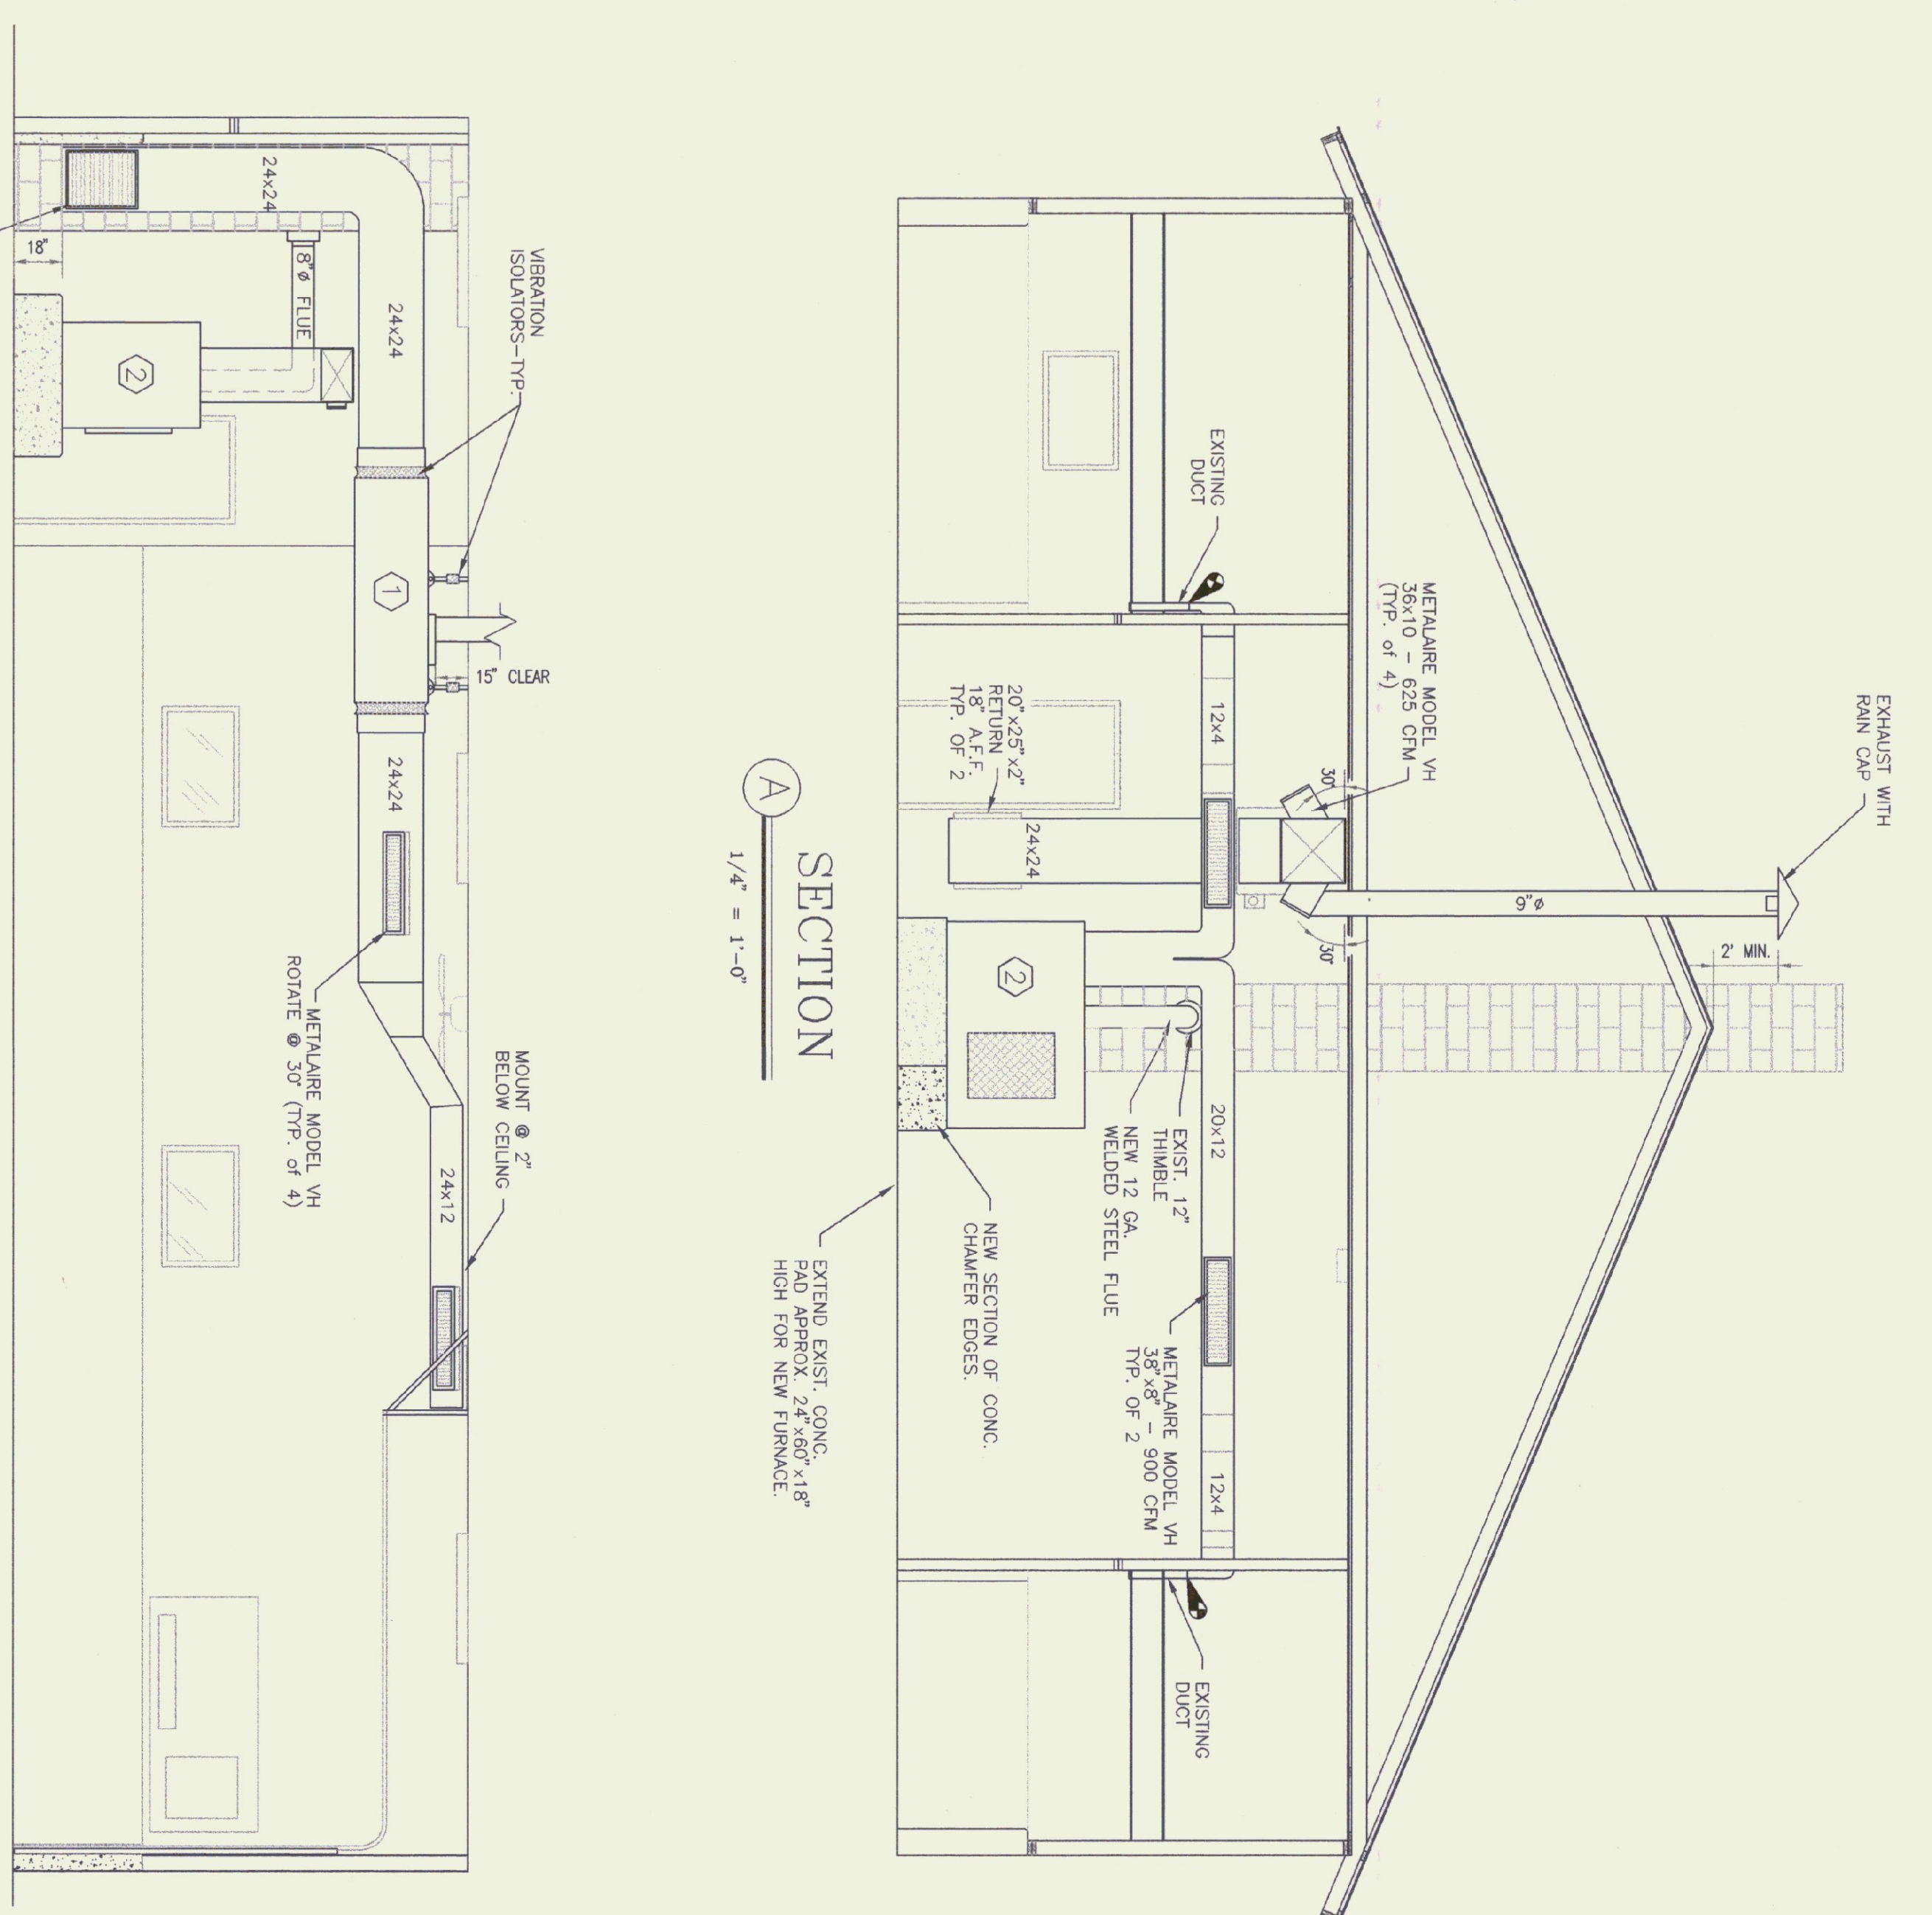

SECTION A
1/4" = 1'-0"

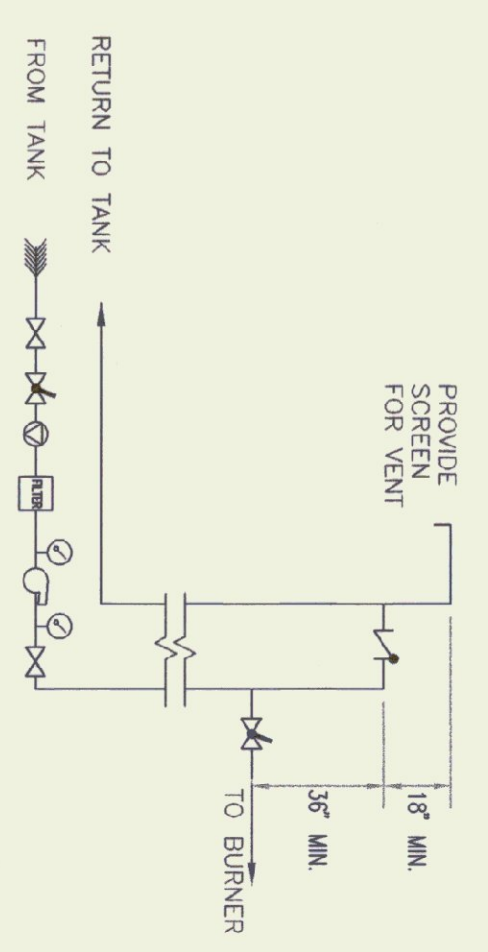

FUEL PIPING SCHEMATIC
NTS

