


12 ROOF DRIP EDGE  
SCALE: 3" = 1'-0"

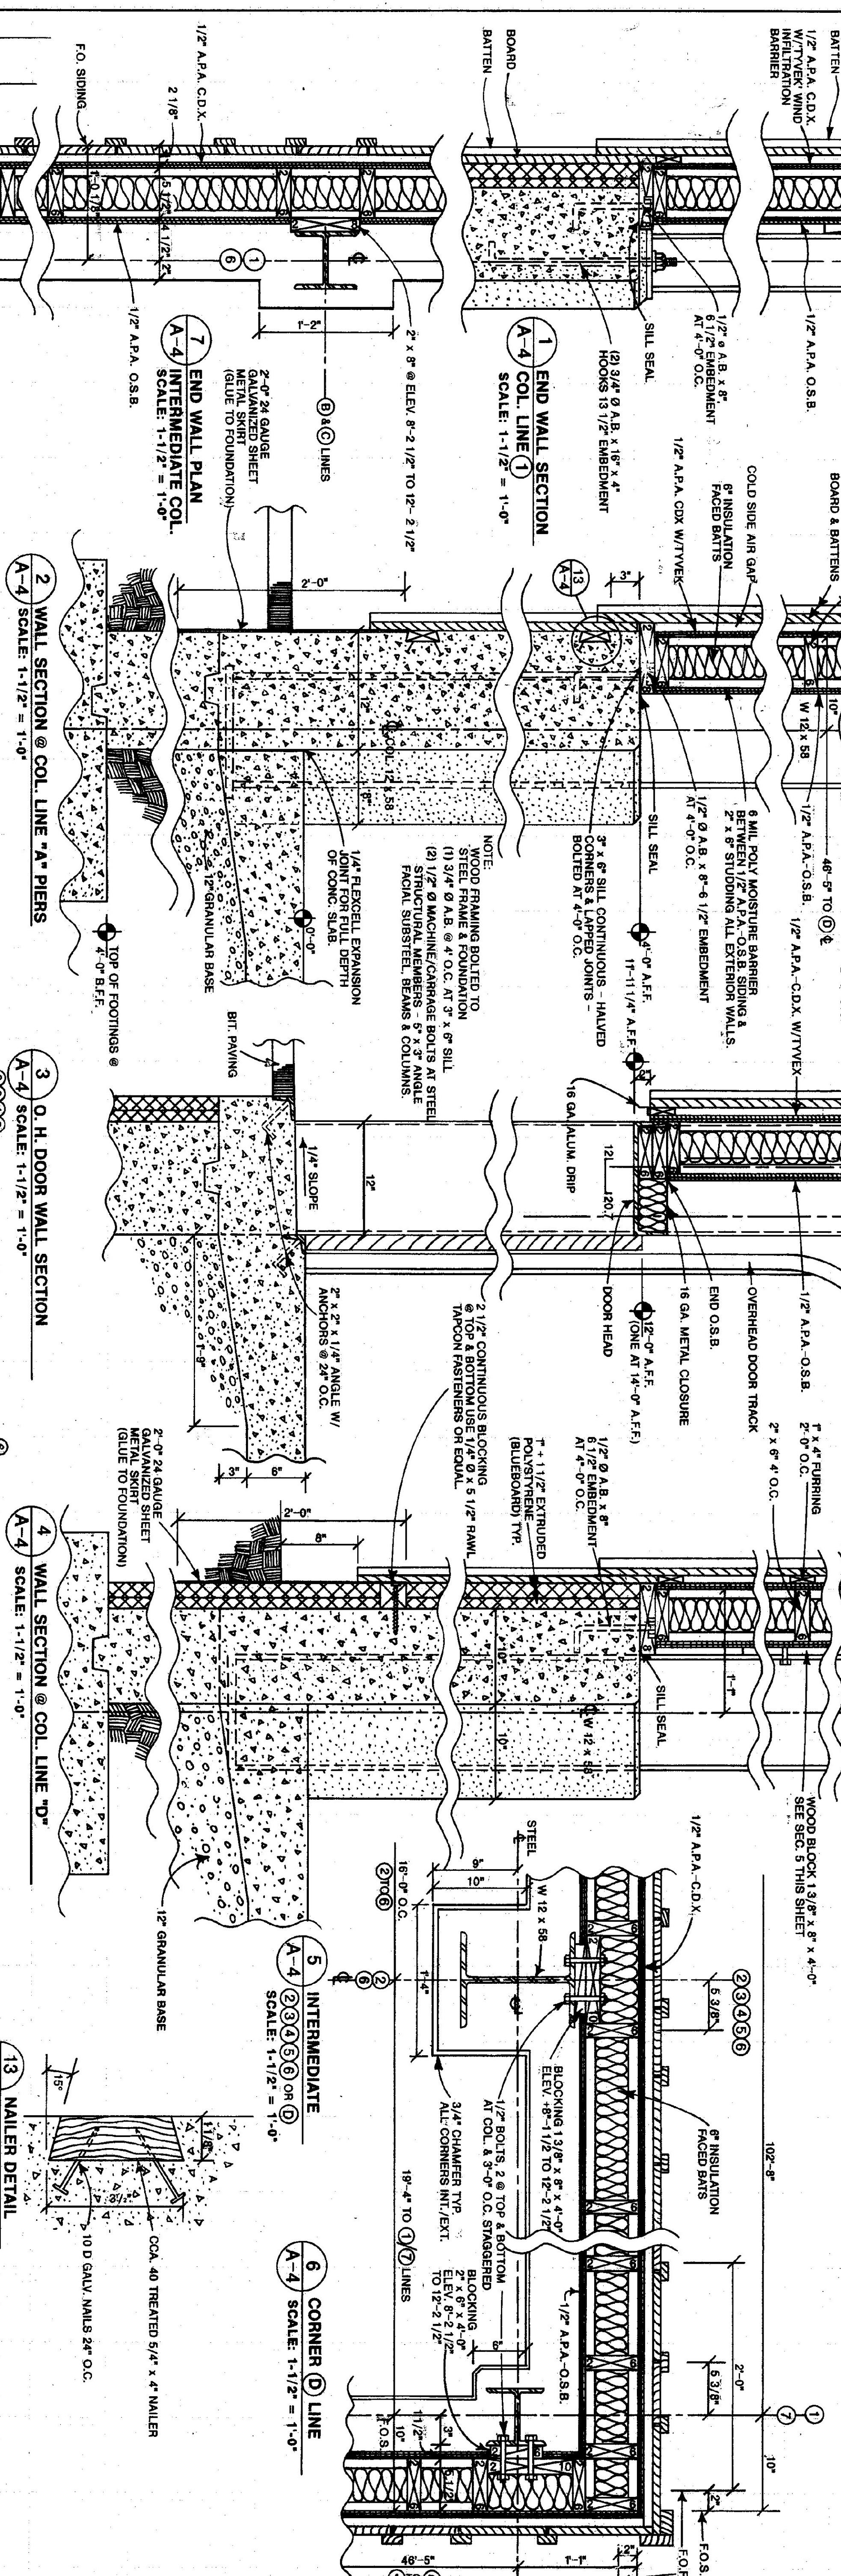

1 END WALL SECTION  
SCALE: 1-1/2" = 1'-0"

2 WALL SECTION @ COL. LINE 'A' PIERS  
SCALE: 1-1/2" = 1'-0"

3 O. H. DOOR WALL SECTION  
SCALE: 1-1/2" = 1'-0"

4 WALL SECTION @ COL. LINE 'D'  
SCALE: 1-1/2" = 1'-0"

5 INTERMEDIATE  
SCALE: 1-1/2" = 1'-0"

6 CORNER 'D' LINE  
SCALE: 1-1/2" = 1'-0"

7 END WALL PLAN  
SCALE: 1-1/2" = 1'-0"

8 CORNER 'A' LINE  
SCALE: 1-1/2" = 1'-0"

9 DOOR JAMB  
SCALE: 3/4" = 1'-0"

10 TYPICAL COLUMN  
SCALE: 1-1/2" = 1'-0"

11 COL. 'A' DOOR JAMB/WALL  
SCALE: 1-1/2" = 1'-0"

13 NAILER DETAIL  
NOT TO SCALE

NOTE:  
ALL LUMBER AT ROOF EDGE  
AND ROOF PENETRATIONS TO  
BE COA PRESSURE TREATED

NOTE:  
2" LAYERS OF INSULATION (SEE SPEC)  
WITH OFFSET JOINTS  
MEMBRANE  
HOT AIR WELD  
SEAM CAULK

STATE OF VERMONT		VERMONT	
DEPARTMENT OF STATE BUILDINGS		AGENCY OF ADMINISTRATION	
MONTPELIER, VERMONT		VERMONT	
<b>VERMONT AGENCY OF TRANSPORTATION</b>			
<b>WALL PLANS &amp; SECTIONS</b>			
<b>5 BAY MAINTENANCE GARAGE</b>			
LUDLOW,		VERMONT	
DATE	SCALE	REVISIONS:	DWG. NO.
Aug. 1968	AS NOTED		A-4
DRAWN BY:	APPROVED BY:		19 OF 30
A. POULIN			