




GARAGE STORAGE MEZZANINE
SCALE: 1/4" = 1'-0"

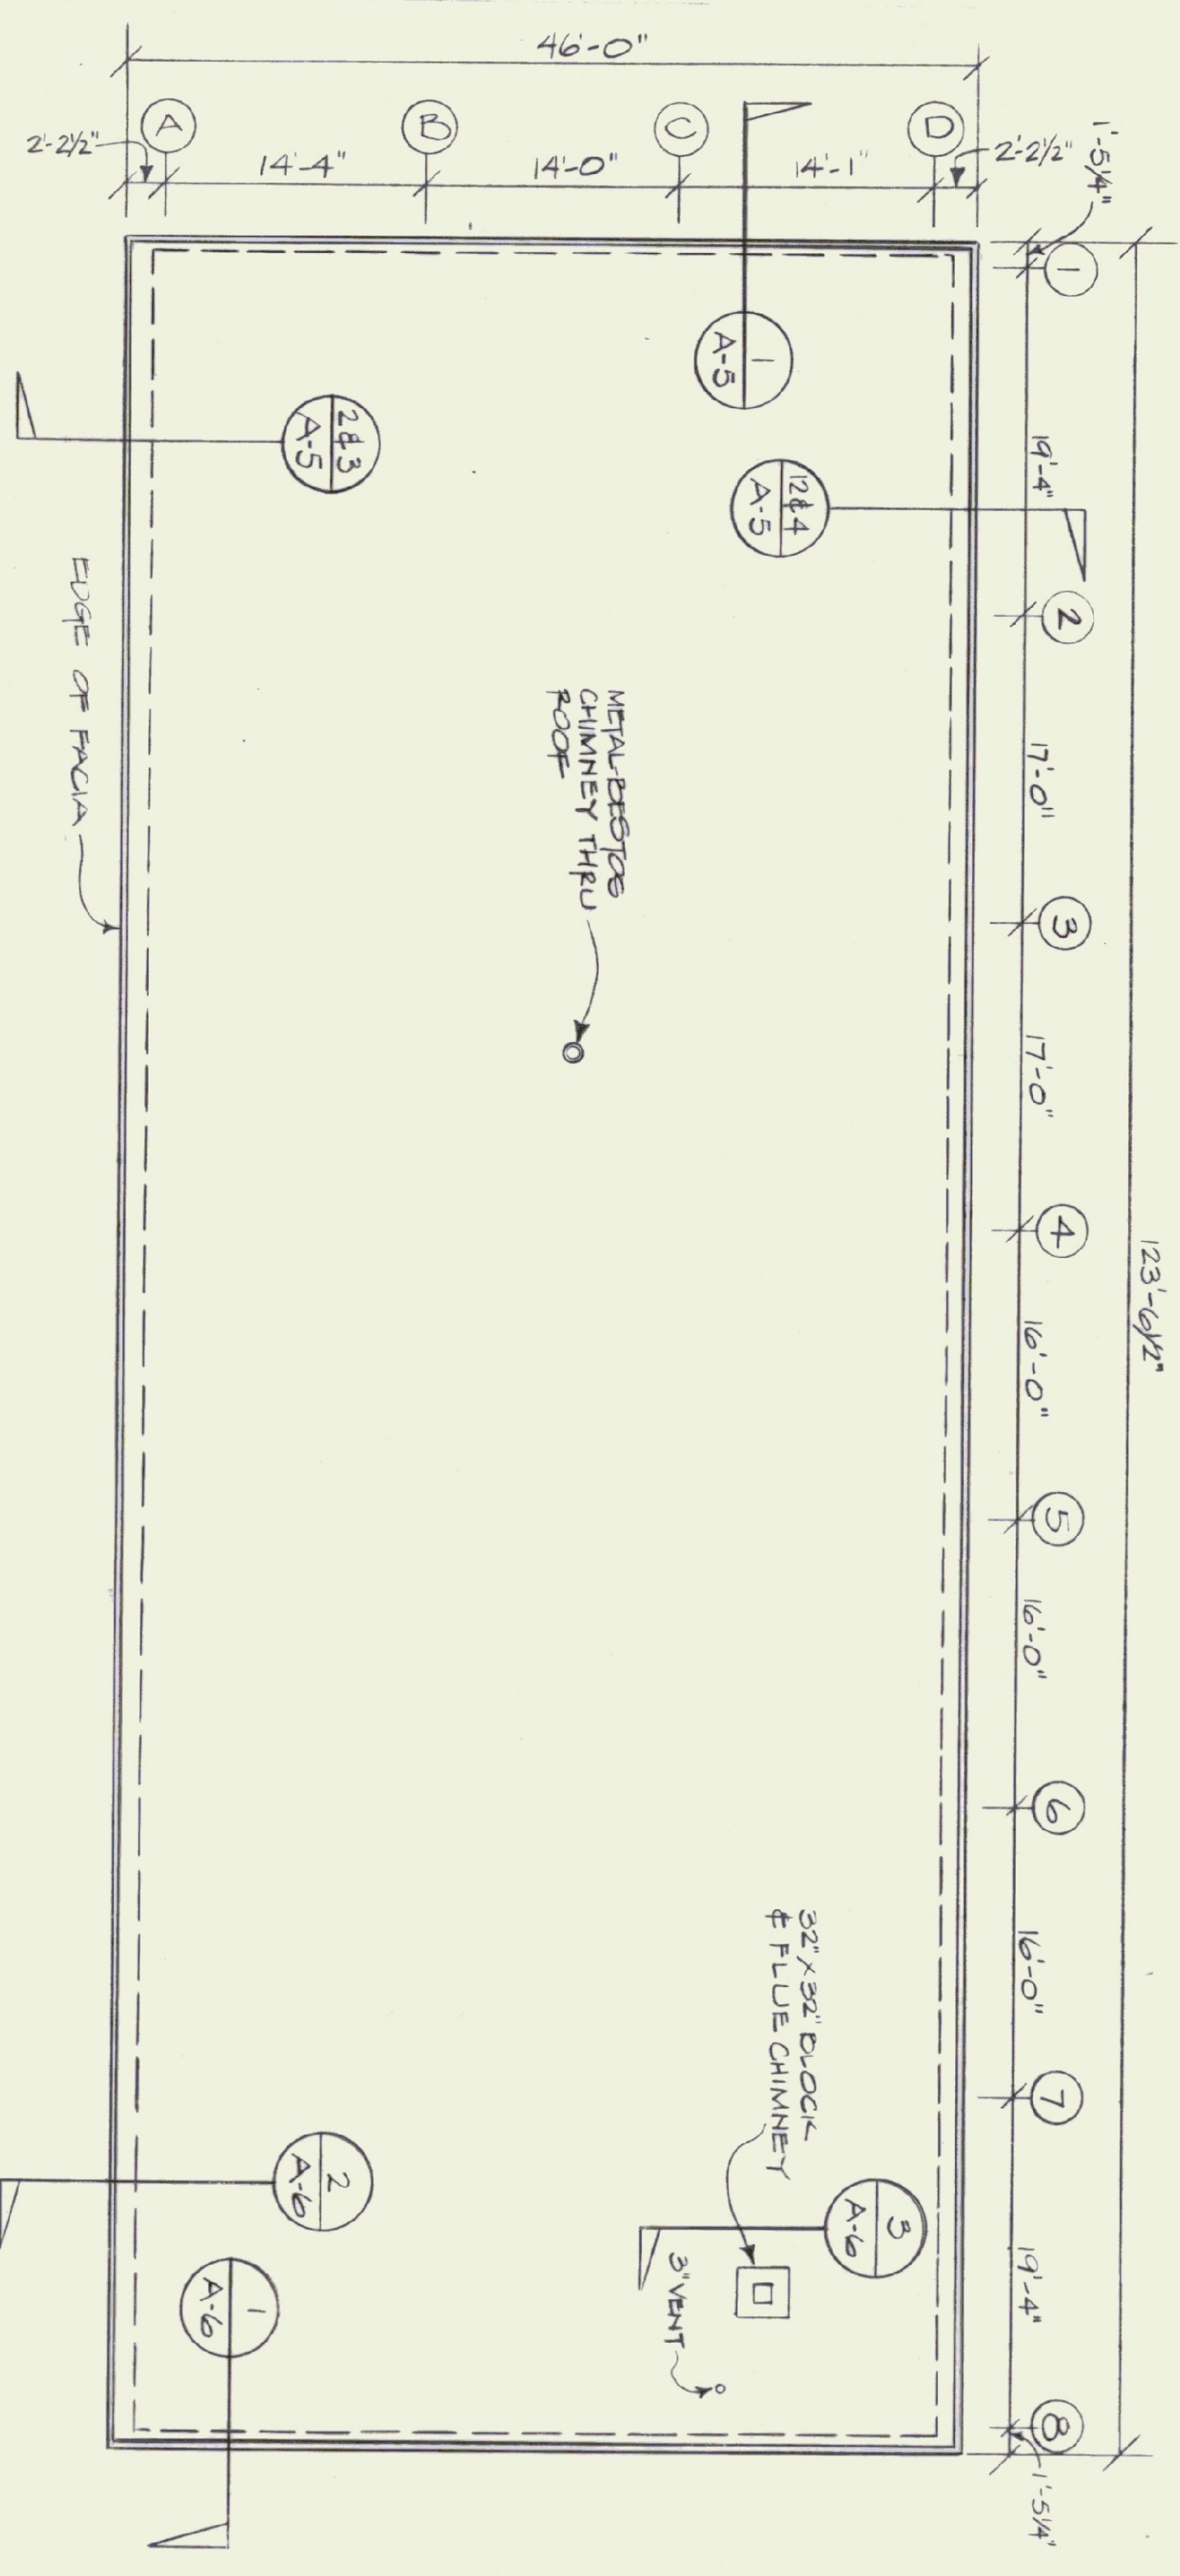

ROOF PLAN
SCALE: 1/8" = 1'-0"

DOOR SCHEDULE												
NO.	QUANTITY	SIZE	TYPE	FRAME MATERIAL	GLASSING MATERIAL	GLASSING SETTING	GLASSING FINISH	BUTTS	LIGHT FIXTURE	WEIGHTS	CLOSERS	REMARKS
D1-D3	3	3'-0" x 7'-0"	I	C	INSULATED METAL	1	4" x 4" WIPERGLASS	4 1/2" x 4 1/2" 3/4" x 10 1/8" WIPERGLASS REMOVABLE PINS STEEL		VINYL	ARGENTS 155X P.A.H.D.	THERMAL BREAK FRAME,
D4	1	2'-8" x 6'-8"	II	C	HD. MTL.	2	20" x 32" SWIFT	4 1/2" x 4 1/2"		NONE	ARGENTS 155X H.O.	
D5	1	"	III	B	"	4	"	"	"	"	"	
D6	1	"	III	B	"	3	"	"	"	"	"	
D7	1	"	III	B	"	4	"	"	"	"	"	
D8-D9	4	14'-0" x 12'-0" / 14'-0" x 14'-0"	IV	C	INSULATED STEEL						ELECTRIC	ATTEND DOOR SERIES 311 THERMASCOPIC W/ASTATIC WINDOWS
D9	1	16'-0" x 14'-0"	IV	C	"						"	"

WINDOW SCHEDULE			
NO.	QUANTITY	TYPE	REMARKS
11	1	WINNING METAL	5'-4 1/2" W ADORN BLDD. COMPONENTS 2'-0" H 4200 SERIES 3420C

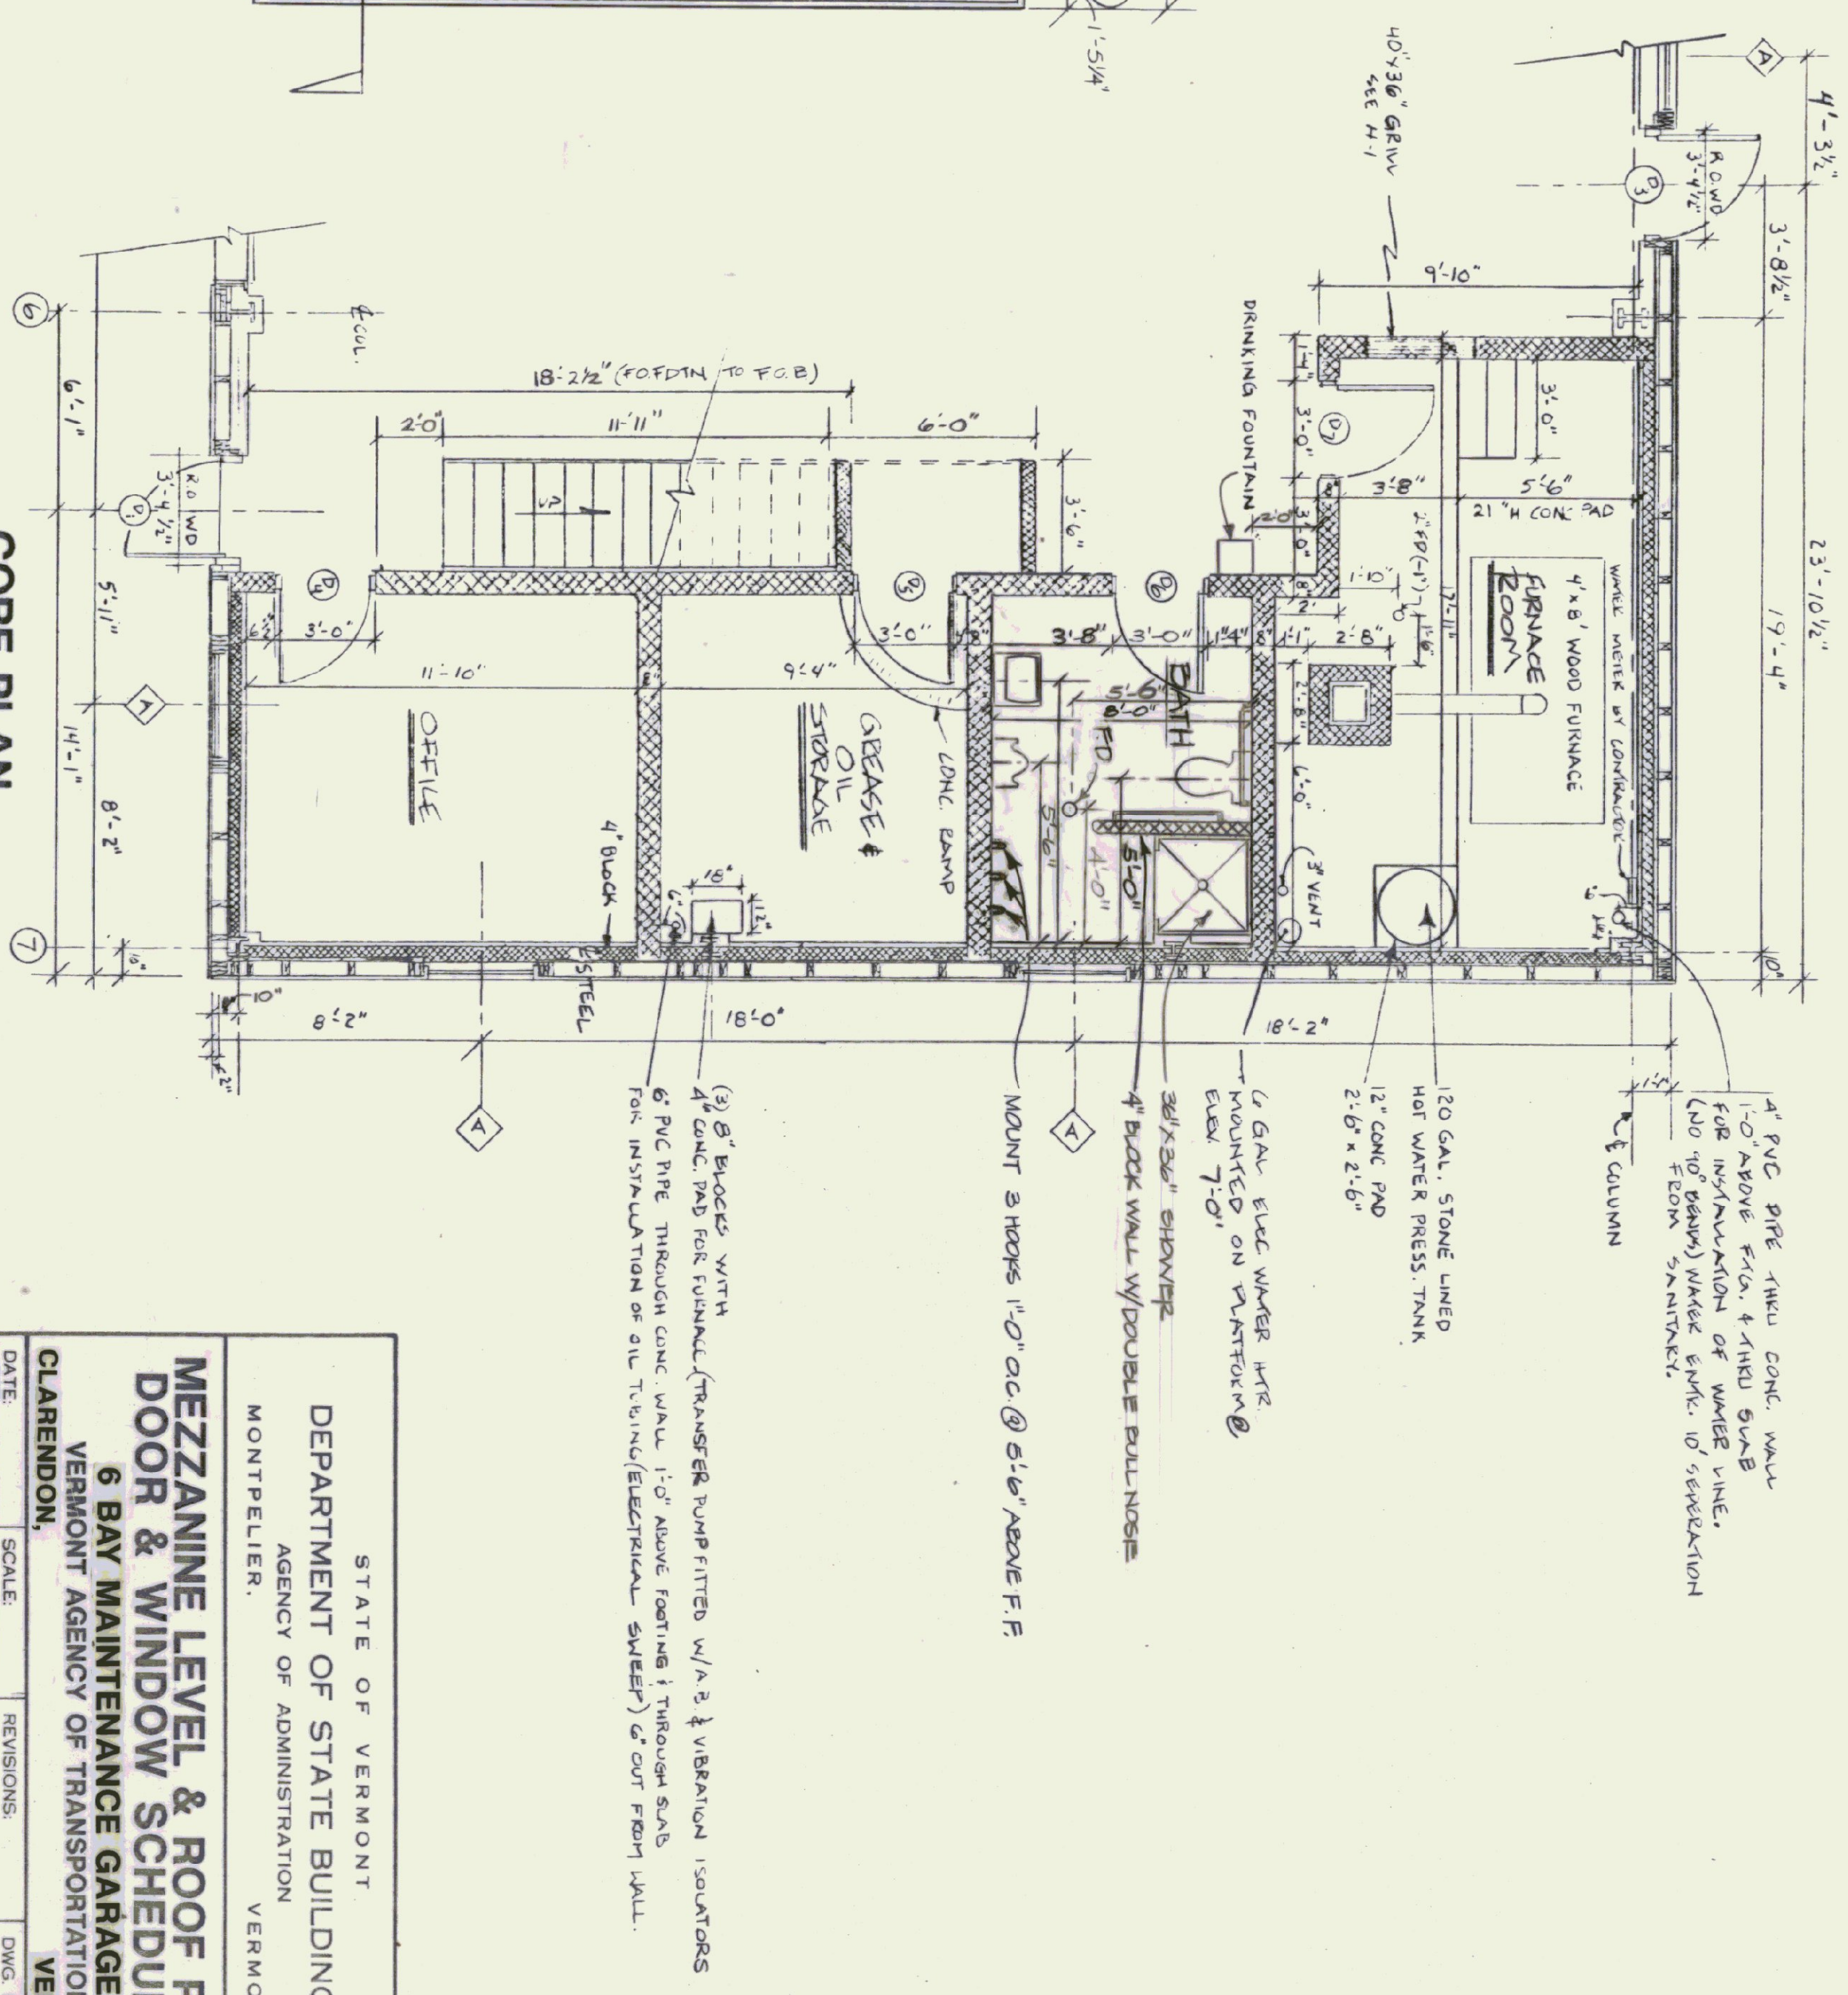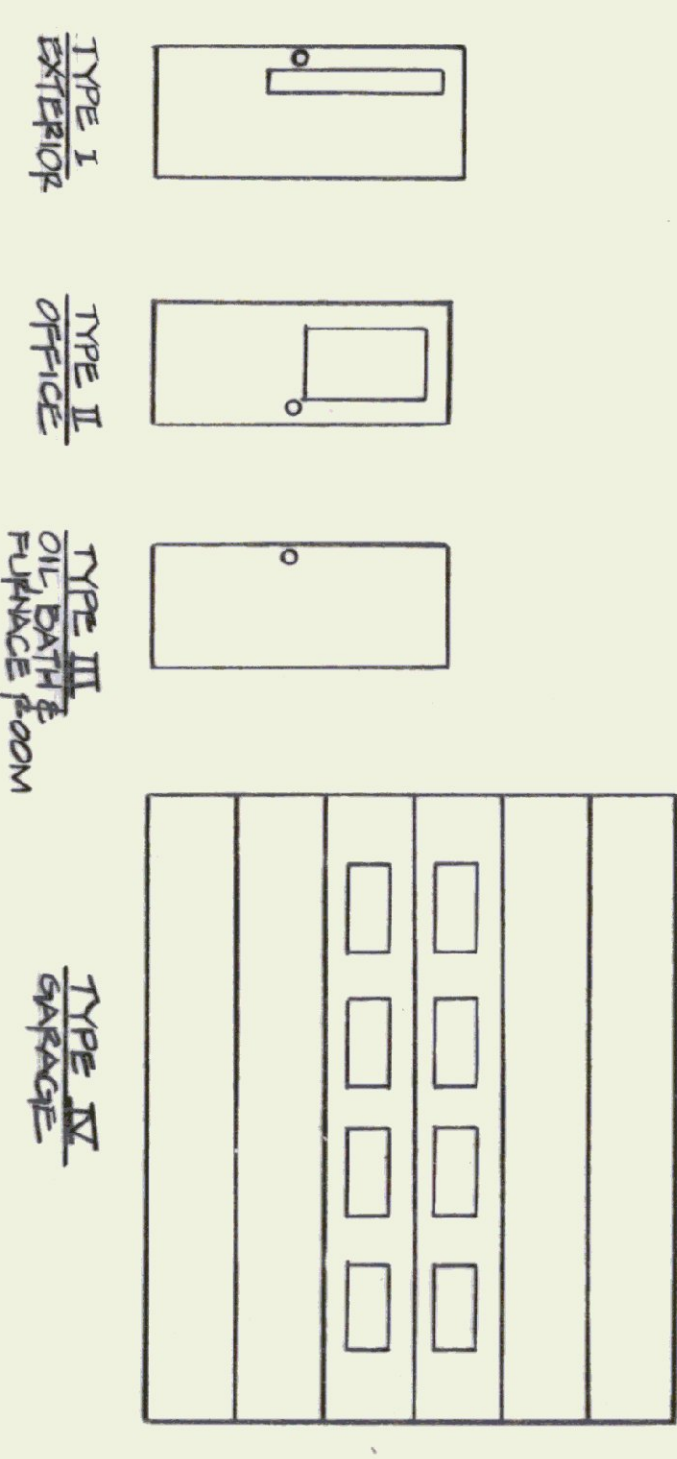

CORE PLAN
SCALE: 1/4" = 1'-0"

STATE OF VERMONT
DEPARTMENT OF STATE BUILDINGS
AGENCY OF ADMINISTRATION
MONTPELIER, VERMONT

**MEZZANINE LEVEL & ROOF PLAN
DOOR & WINDOW SCHEDULES
6 BAY MAINTENANCE GARAGE
VERMONT AGENCY OF TRANSPORTATION
CLARENDON, VERMONT**

DATE: APRIL 19, 1993
DRAWN BY: R. TETREAU
APPROVED BY: A. POLI
SCALE: AS NOTED
REVISIONS:
DWG. NO. A-2
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