



- KEYED NOTES:**
- 1 LOCATION OF RELOCATED PADDLE FAN, COORDINATE EXACT LOCATION WITH MECHANICAL CONTRACTOR AND GAS UNIT HEATERS
  - 2 LOCATION OF RELOCATED EXHAUST FAN, COORDINATE EXACT LOCATION WITH MECHANICAL CONTRACTOR. INSTALLATION BY MC, EXTEND EXISTING CIRCUIT AS REQUIRED, WIRING BY EC.

**MEZZANINE LEVEL NEW WORK PLAN**  
SCALE: 1/8" = 1'-0"


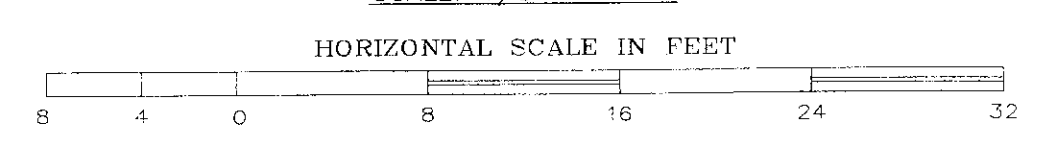


- GENERAL NOTES:**
- ANY PLACE WHERE THE CONTRACTOR PENETRATES, CUTS AND/OR REMOVES WALLS, CEILING, OR WOODWORK, CONTRACTOR IS TO REPLACE, PATCH AND PAINT FINISH SURFACES TO ORIGINAL FINISHES.
  - FIELD VERIFY ALL DIMENSIONS BEFORE COMMENCEMENT OF WORK IS TO BEGIN. NOTIFY ENGINEER OF ANY ERRORS.
  - REFER TO THE MECHANICAL PLANS FOR FINAL LOCATIONS OF EQUIPMENT. COORDINATE LOCATIONS OF ALL THE ELECTRICAL CONNECTIONS WITH MC PRIOR TO ELECTRICAL ROUGH-IN WIRING.
  - EC TO PROVIDE AND INSTALL ALL DISCONNECT SWITCHES, MC TO PROVIDE ALL MOTOR STARTERS, EC TO INSTALL.

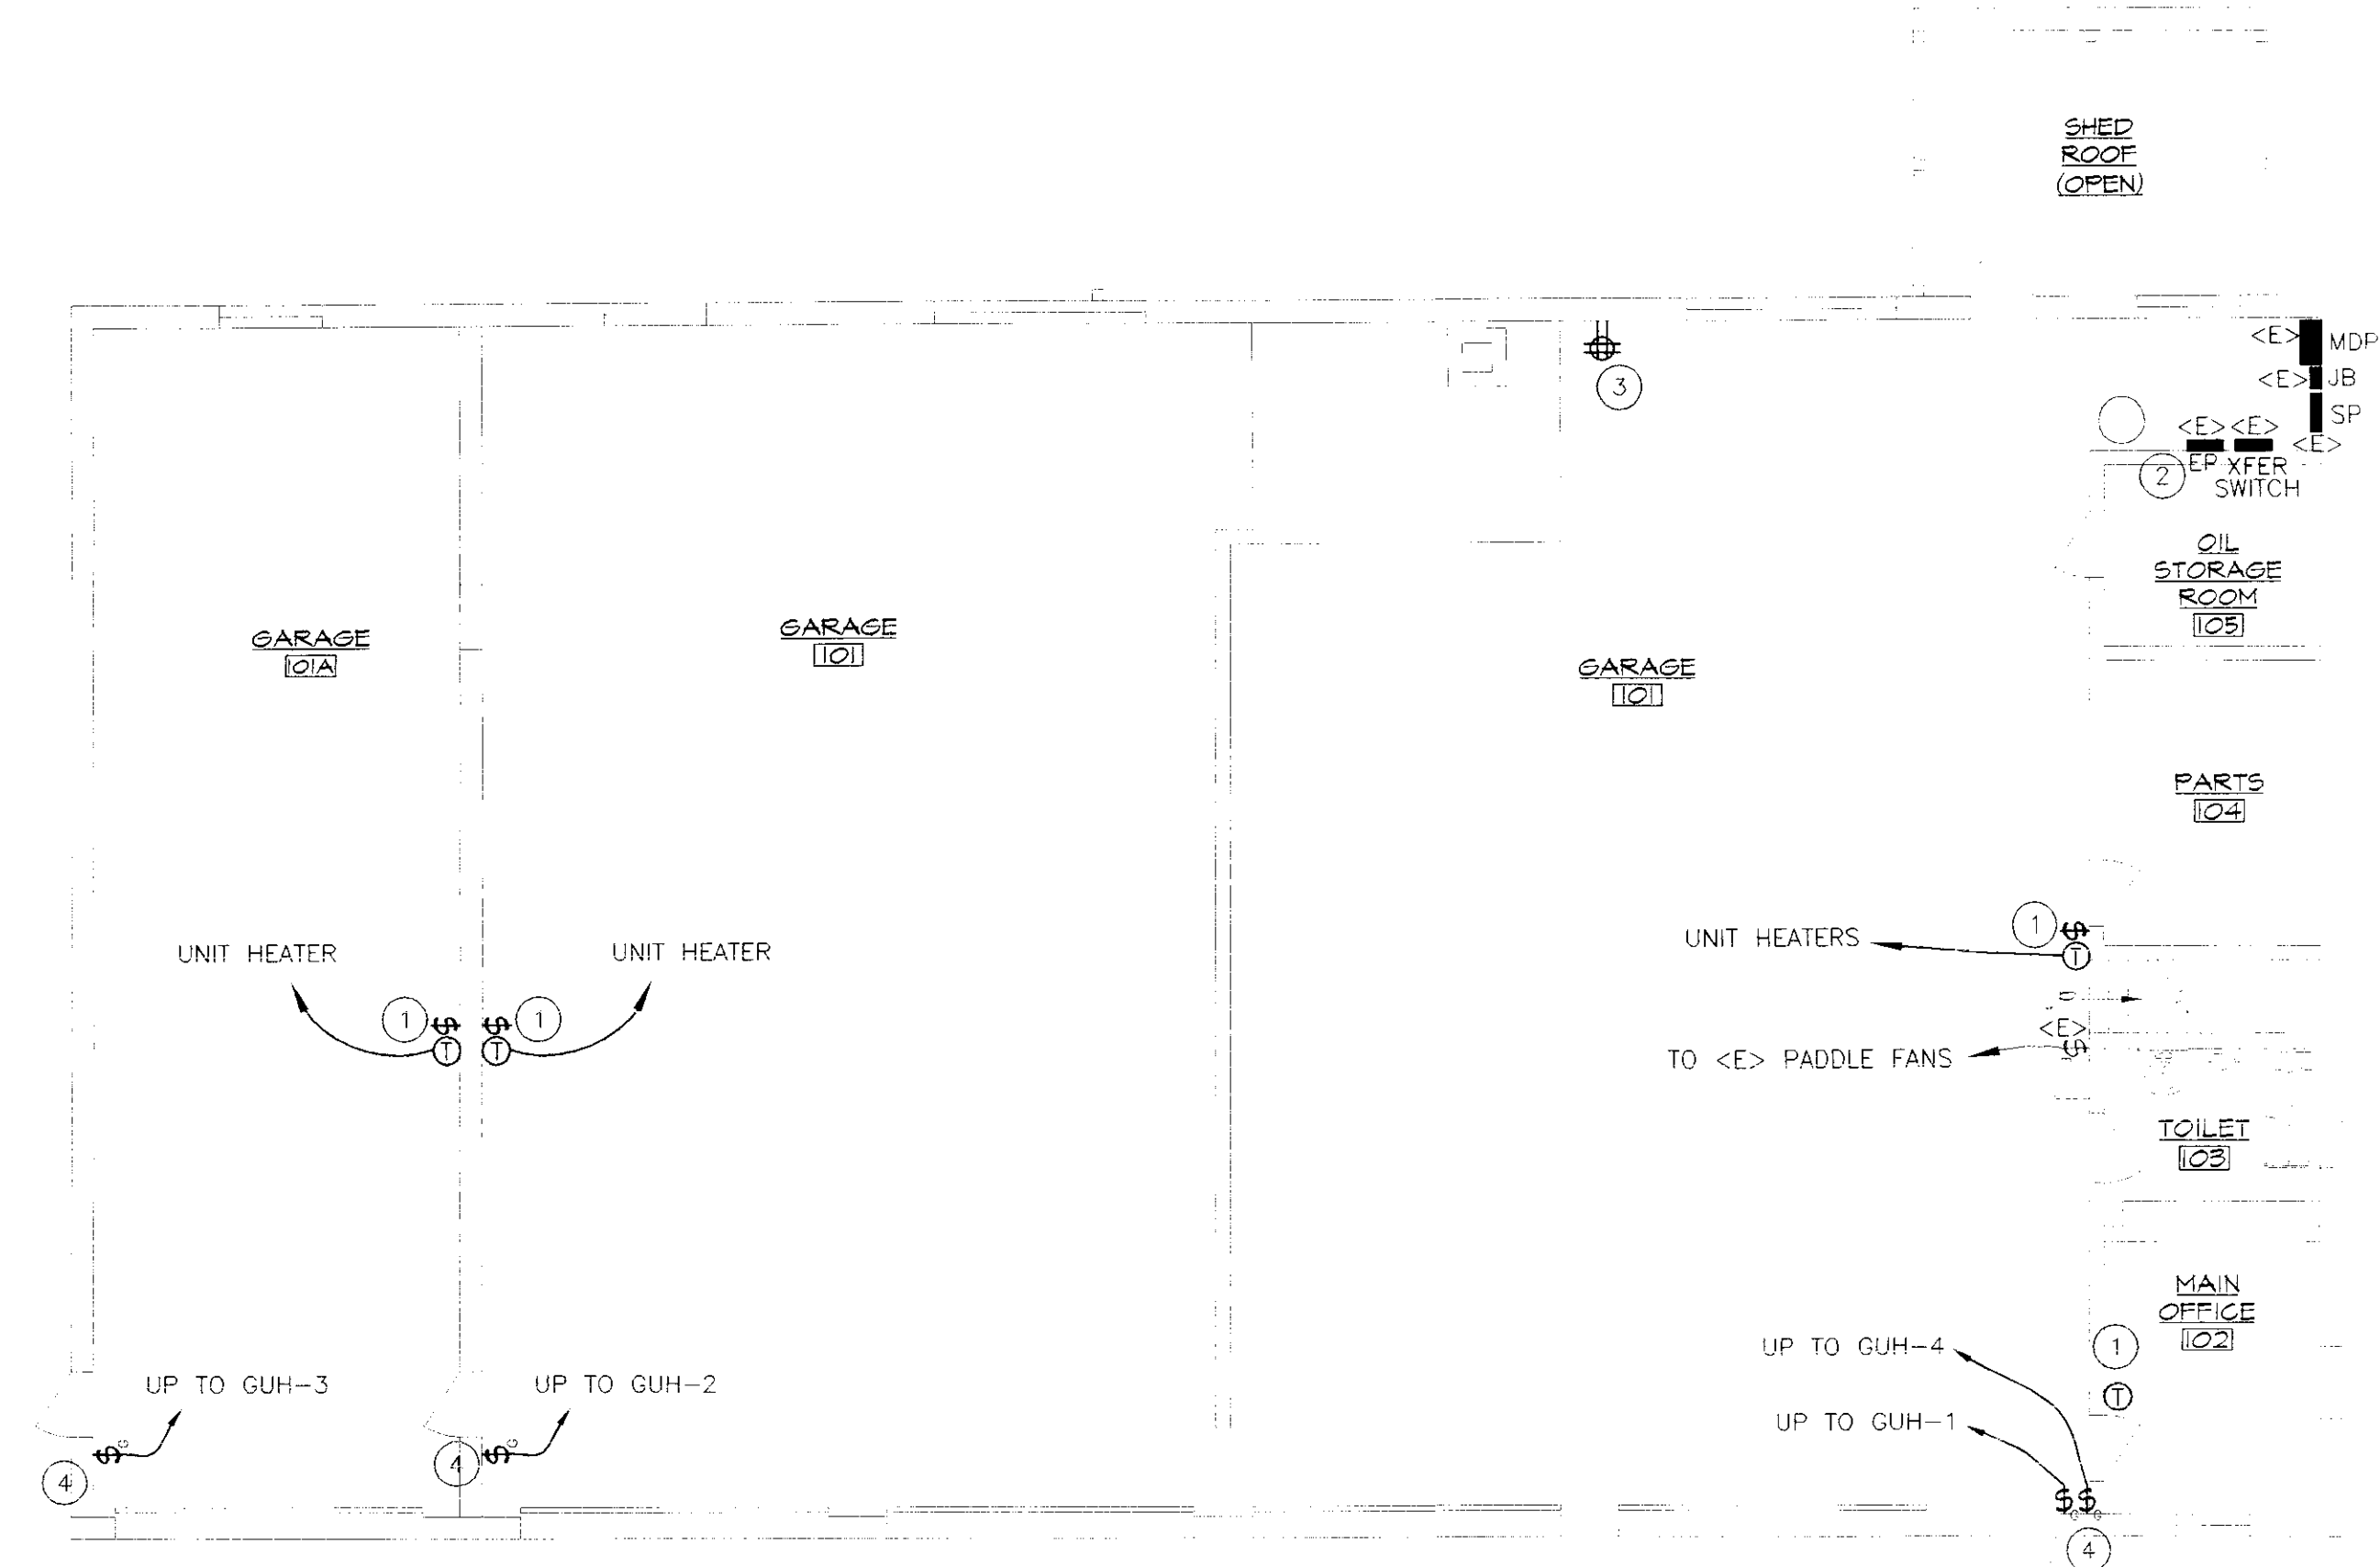


- KEYED NOTES:**
- 1 24-VOLT T-STAT & "SUMMER FAN" SWITCH BY MC. LOW VOLTAGE WIRING BY MC.
  - 2 PANEL EP IS A SQUARE D HOMELINE LOADCENTER WITH TYPE HOM BREAKERS. PROVIDE ALL NEW BREAKERS FOR NEW CIRCUITS AS REQUIRED.
  - 3 LOCATION OF RELOCATED QUAD RECEPTACLE, CHANGE TO GFI PROTECTED RECEPTACLES, RE-USE & EXTEND EXISTING CIRCUIT AS REQUIRED.
  - 4 PROVIDE EMERGENCY SHUT-OFF SWITCHES FOR EACH GAS HEATER. SWITCH SHALL HAVE RED "GAS" PLATE. USE 2-POLE SWITCHES FOR 240V UNITS.

**FIRST FLOOR NEW WORK PLAN**  
SCALE: 1/8" = 1'-0"

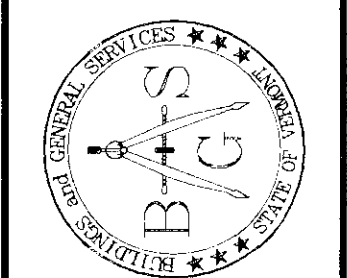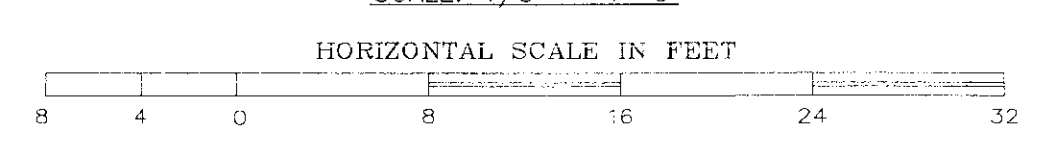

STATE OF VERMONT  
Department of Buildings  
and General Services  
Agency of Administration  
Montpelier, Vermont

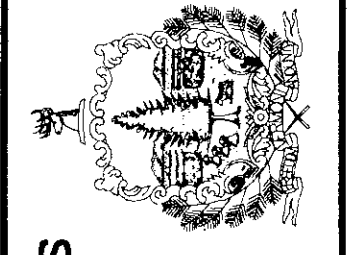

**Pearson & Associates**  
MECHANICAL & ELECTRICAL ENGINEERS  
P.O. BOX 510 STOWE, VERMONT 05672  
TEL. (802) 253-9607 FAX. (802) 253-9990  
EMAIL: pearson@stowe.net

AGENCY OF TRANSPORTATION  
CASTLETON MAINTENANCE  
GARAGE HEATING RENOVATIONS  
RUTLAND VERMONT

REVISIONS	SCALE: AS SHOWN	DATE: DEC. 2004	DRAWN BY: ASG	APPR. BY: EEP

AGENCY OF TRANSPORTATION  
GARAGE & OFFICES  
ELECTRICAL NEW WORK & DETAILS

