

AIR CONDITIONER SCHEDULE




MAKE/MODEL	CAPACITY @95°	VOLTS	AMPS	MAXIMUM FUSE SIZE	SEER	REMARKS
AC 1 MITSUBISHI PL24AK	24,000 BTU	115/1/60	3.0	15	10.0	
ACC 1 MITSUBISHI PL24EK		230/1/60	16.0	20		MATCHED TO INDOOR UNIT


EQUIPMENT SCHEDULE

PLAN SYMBOL	DESCRIPTION	MANUF. & MODEL	CHARACTERISTICS	ELECTRIC VOLTS/ # /HZ	NOTES
L-1	RELIEF LOUVER VENT PRODUCTS 2750		12"x12"		
MOD-1	RELIEF DAMPER VENT PRODUCTS 5703		12"x12"		BELOW DIRECT COUPLED ACTUATOR
L-2	RELIEF LOUVER VENT PRODUCTS 2740		12"x12"		
MOD-2	RELIEF DAMPER VENT PRODUCTS 5703		12"x12"		BELOW DIRECT COUPLED ACTUATOR
RH-1	REHEAT COIL	McQUAY 5850801H	12x12 EWT 40°F LWT 95°F 180 EWT 160 LWT 2.4 gpm 24,412 BTU		PROVIDE 3 - WAY CONTROL VALVE

AIR HANDLER SCHEDULE

MAKE/MODEL	CFM	ESP	VOLTS	PHASE	MAXIMUM CIRCUIT CAPACITY	REMARKS
HX-1 SEMCO PL-500	550	0.9	115	1	15	PROVIDE AN OFF/HIGH/LOW SPEED SWITCH FOR OPERATION. DISCHARGE AIR SENSOR TO MODULATE VALVE TO MAINTAIN DISCHARGE AIR TEMP 65° F (ADD.)

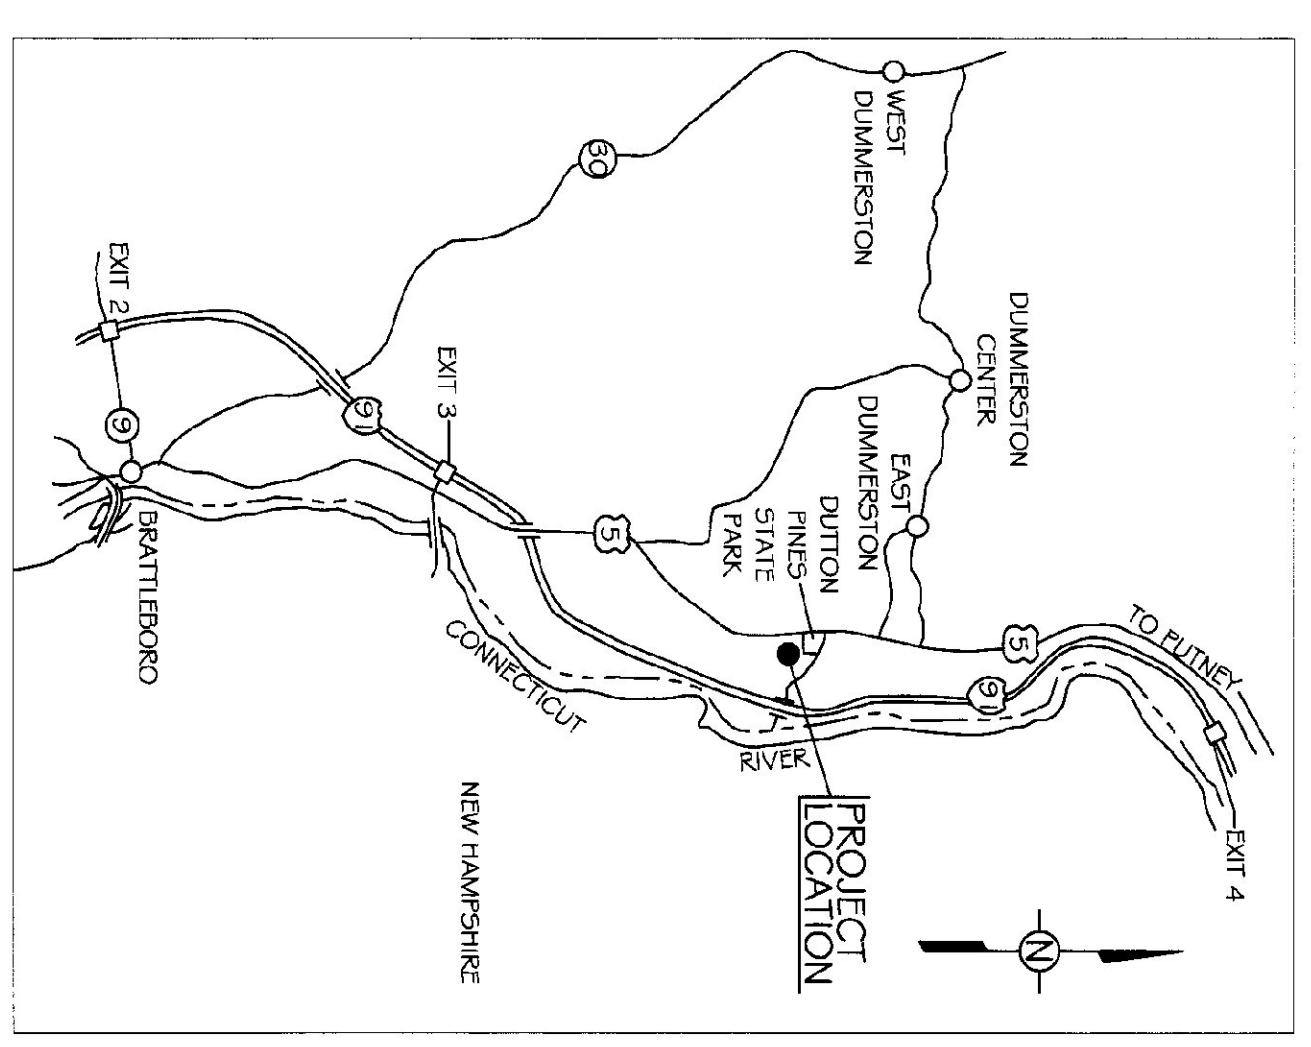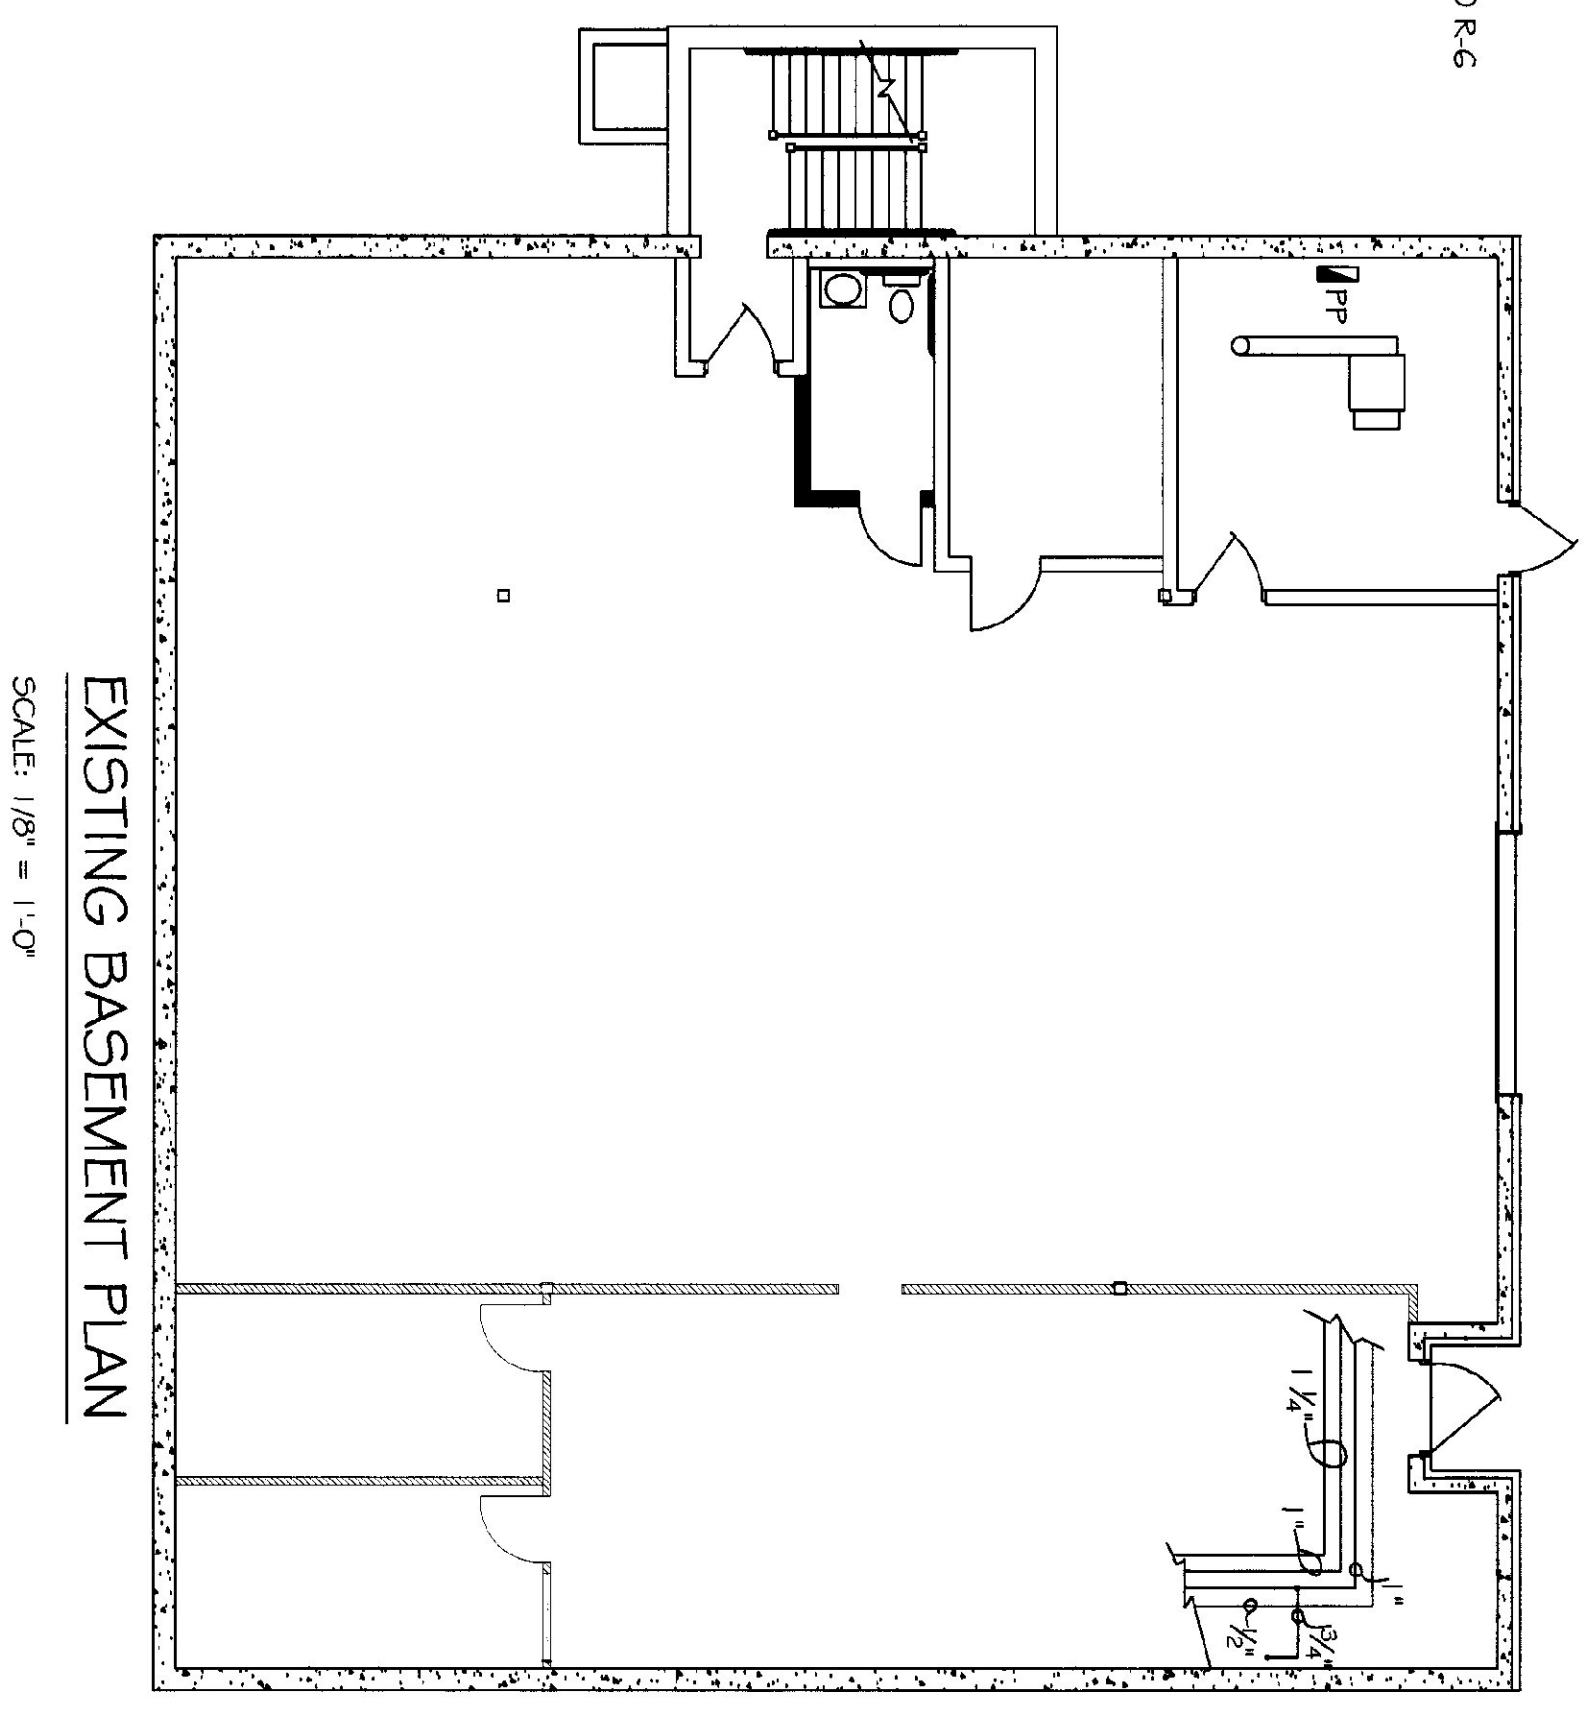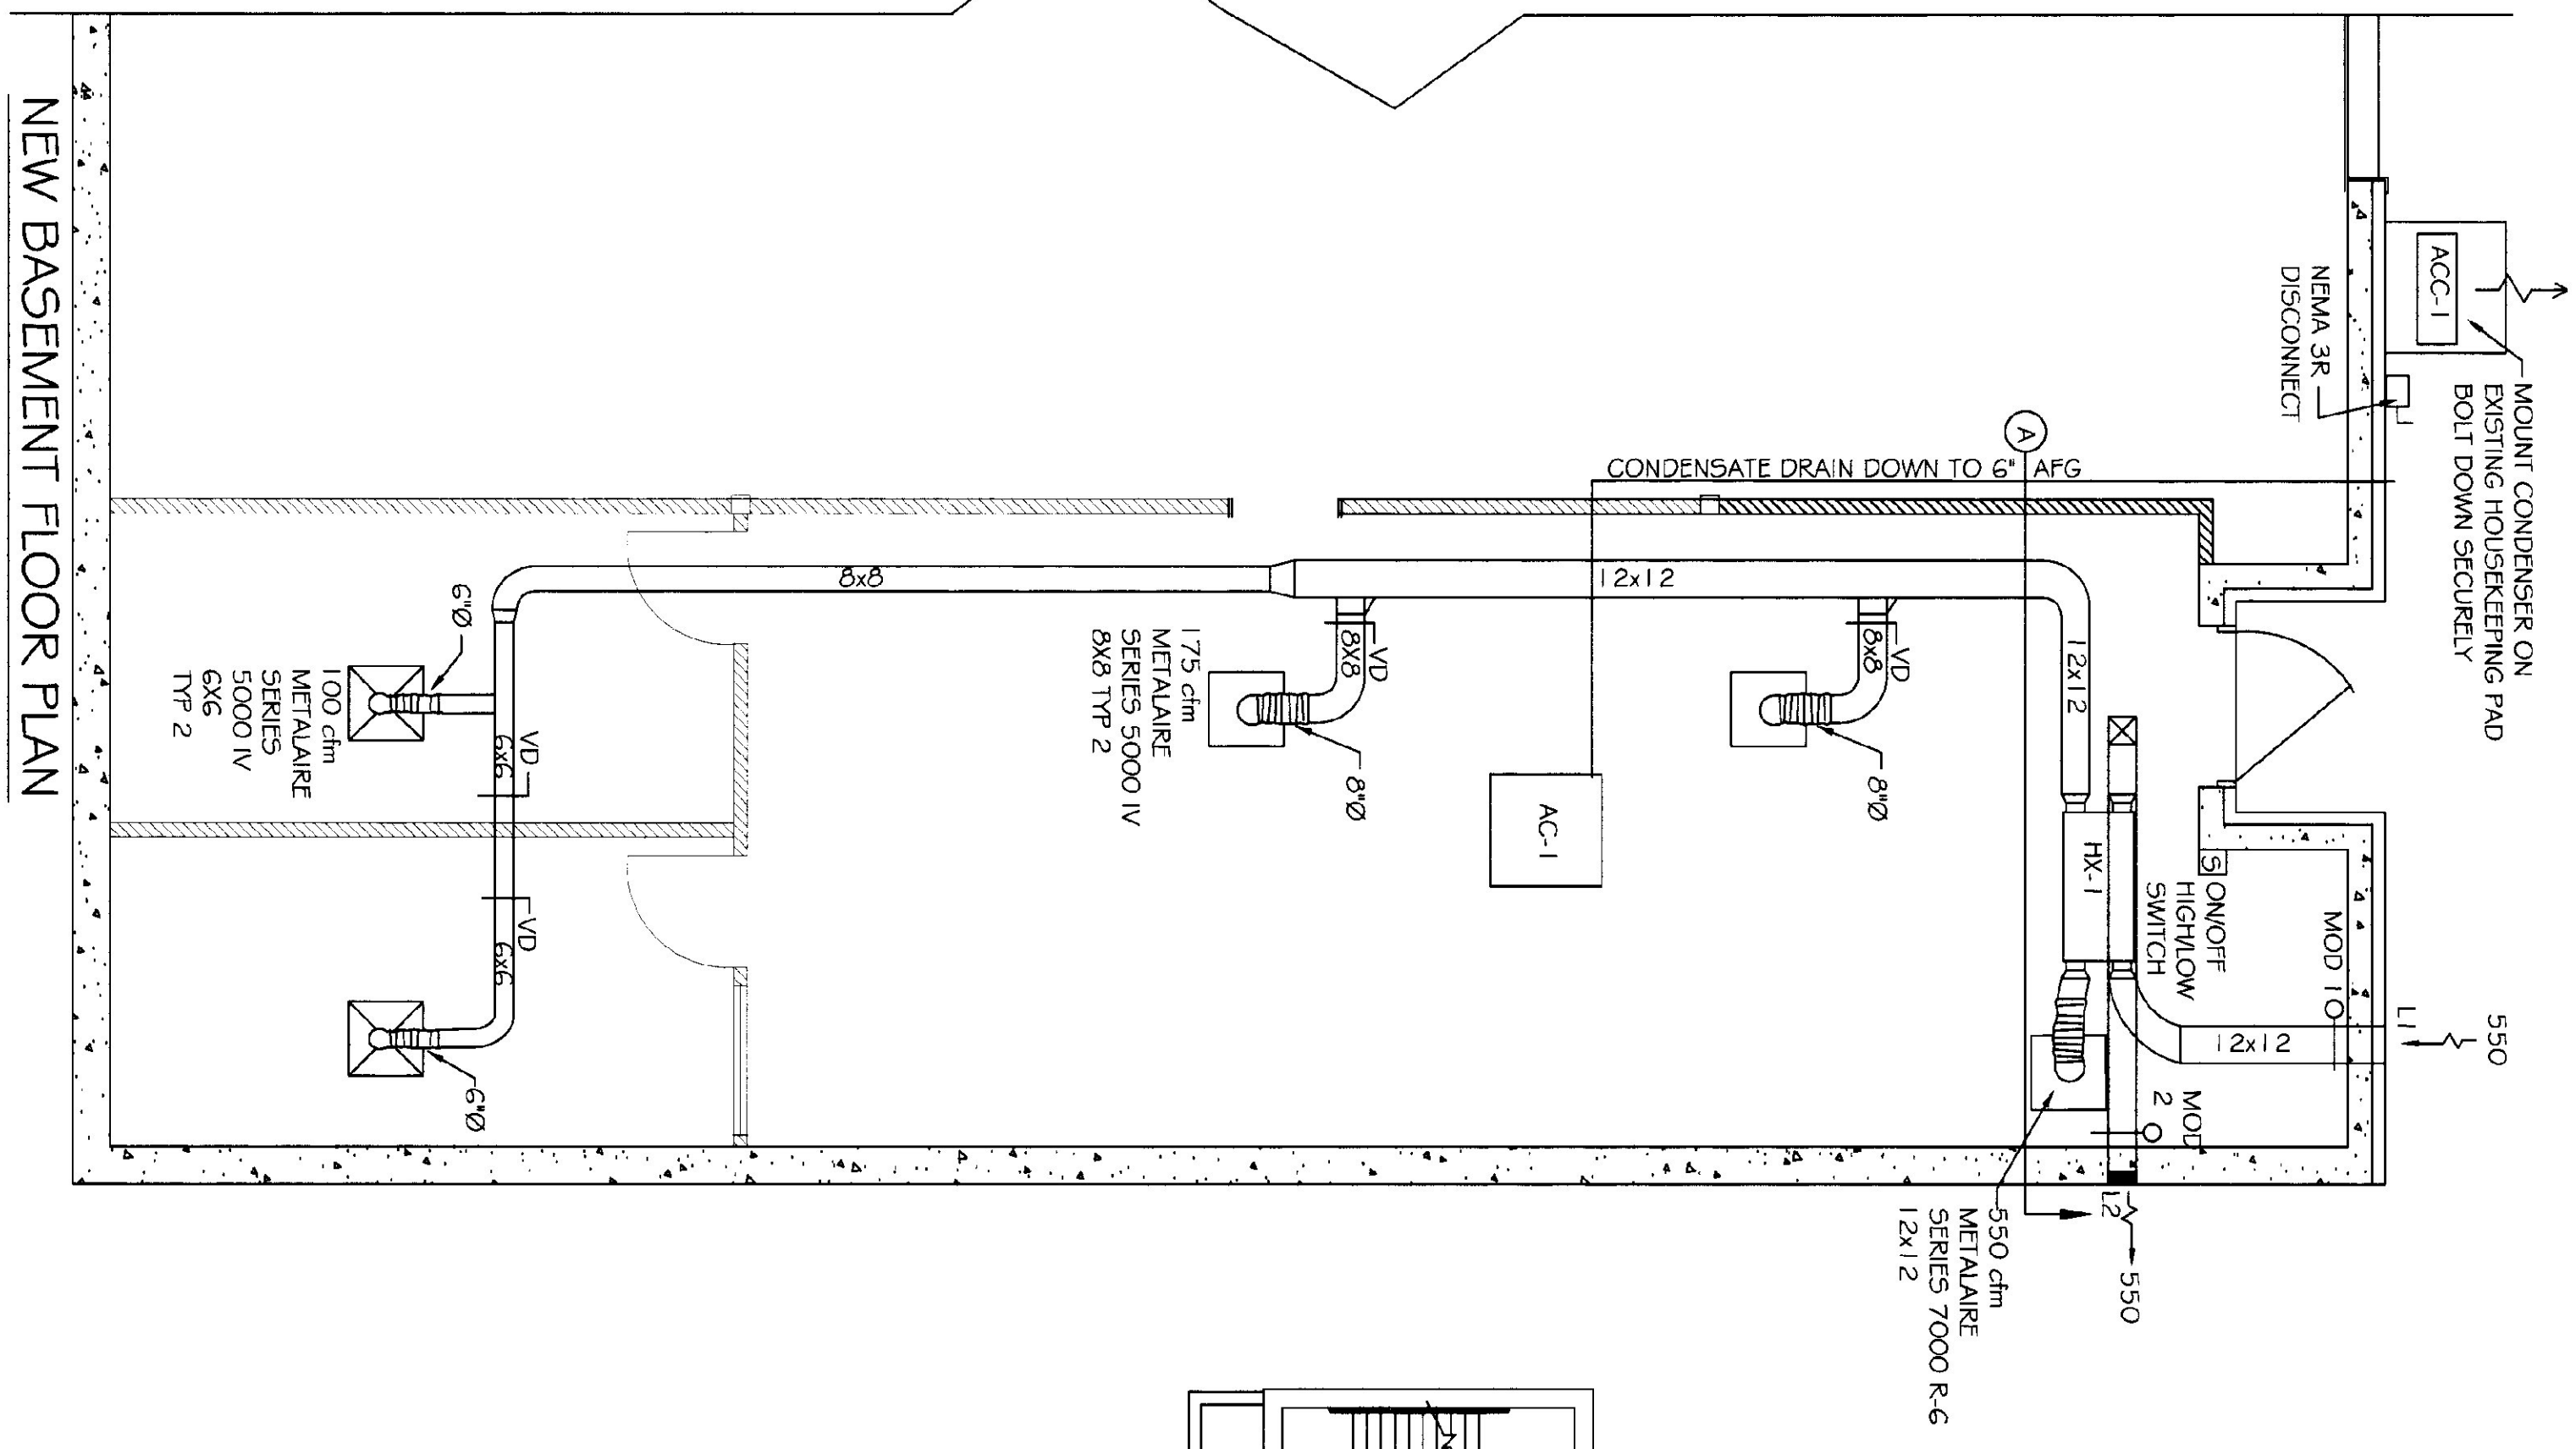

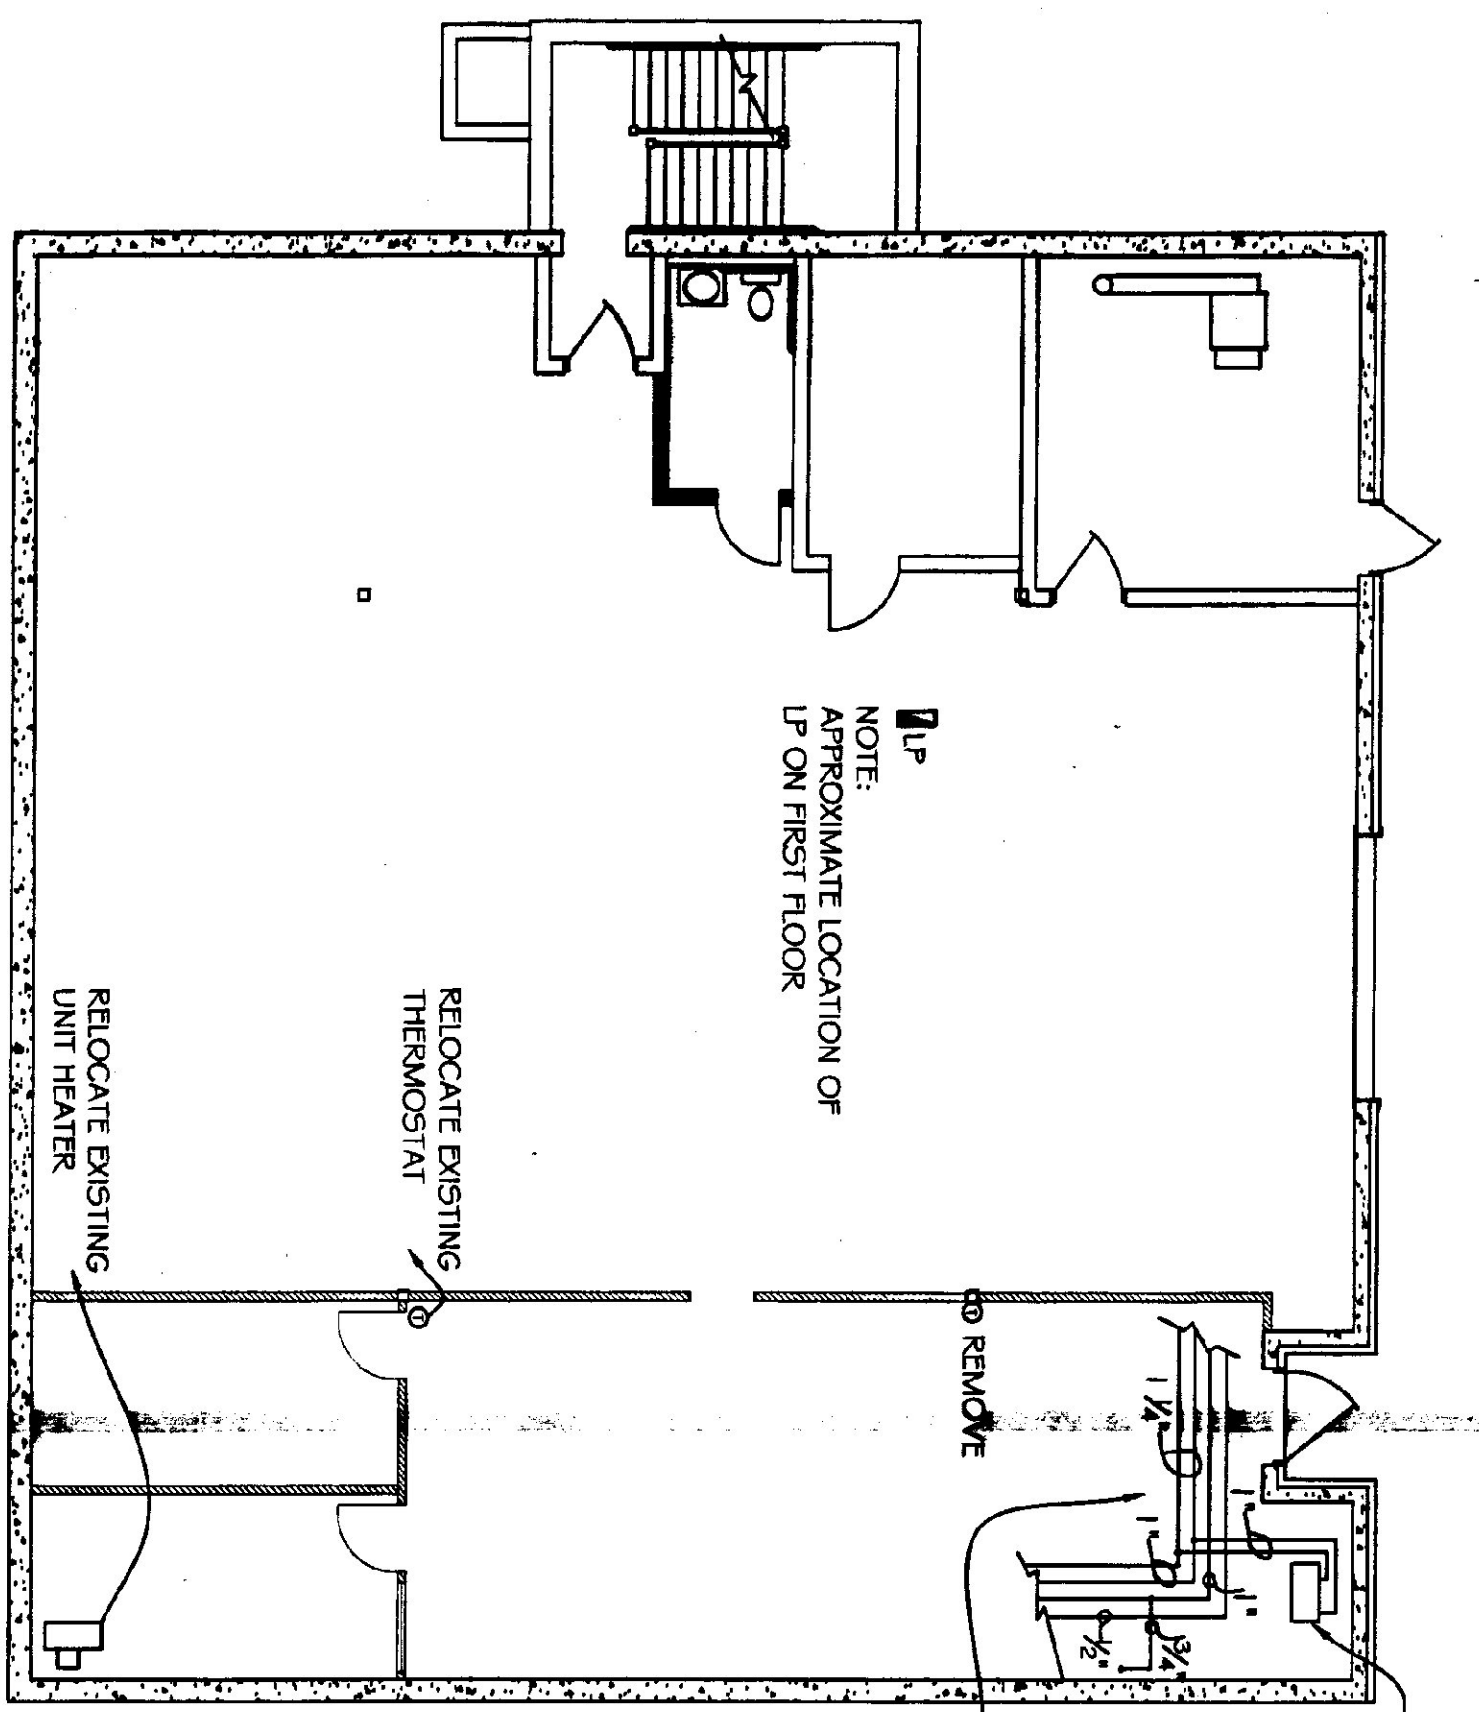

DEMOLITION PLAN
SCALE: 1/8" = 1'-0"

EQUIPMENT SCHEDULE


PLAN SYMBOL	DESCRIPTION	MANUF. & MODEL	CHARACTERISTICS	ELECTRIC VOLTS / # / HZ	NOTES
L-1	RELIEF DAMPER VENT PRODUCTS 2750		48" x 12"	120/1/60	BEHIND DIRECT COOLED ACTUATOR
MOD-1	RELIEF DAMPER VENT PRODUCTS 5703		48" x 12"	120/1/60	BEHIND DIRECT COOLED ACTUATOR
L-2	RELIEF DAMPER VENT PRODUCTS 2740		24" x 24"	120/1/60	BEHIND DIRECT COOLED ACTUATOR
MOD-2	RELIEF DAMPER VENT PRODUCTS 5703		24" x 24"	120/1/60	BEHIND DIRECT COOLED ACTUATOR

AIR COOLED CONDENSOR SCHEDULE


FAN TYPE	QTY	VOLTS	PHASE	FUSE SIZE AMPS	MCA	CAPACITY @95°	MAKE/MODEL	SEER	REMARKS
ACC 1	PROP 1	208/230	1	35	21.1	3 TON	LENNOX HS29-036	11.0	

AIR HANDLER SCHEDULE


GF#	ESP	FAN/RPM	HP	VOLTS	PHASE	MCA	FUSE SIZE	AMH	GF#	COOLING CAPACITY AMH	MAKE/MODEL	REMARKS
UV-1	1300	0.5	1.35	1/2	115	1	7.53	15	8.3	6.3	ASHRAE CYCLE II CONTROLS PROVIDE TRIM RING FOR CEILING PENETRATION	

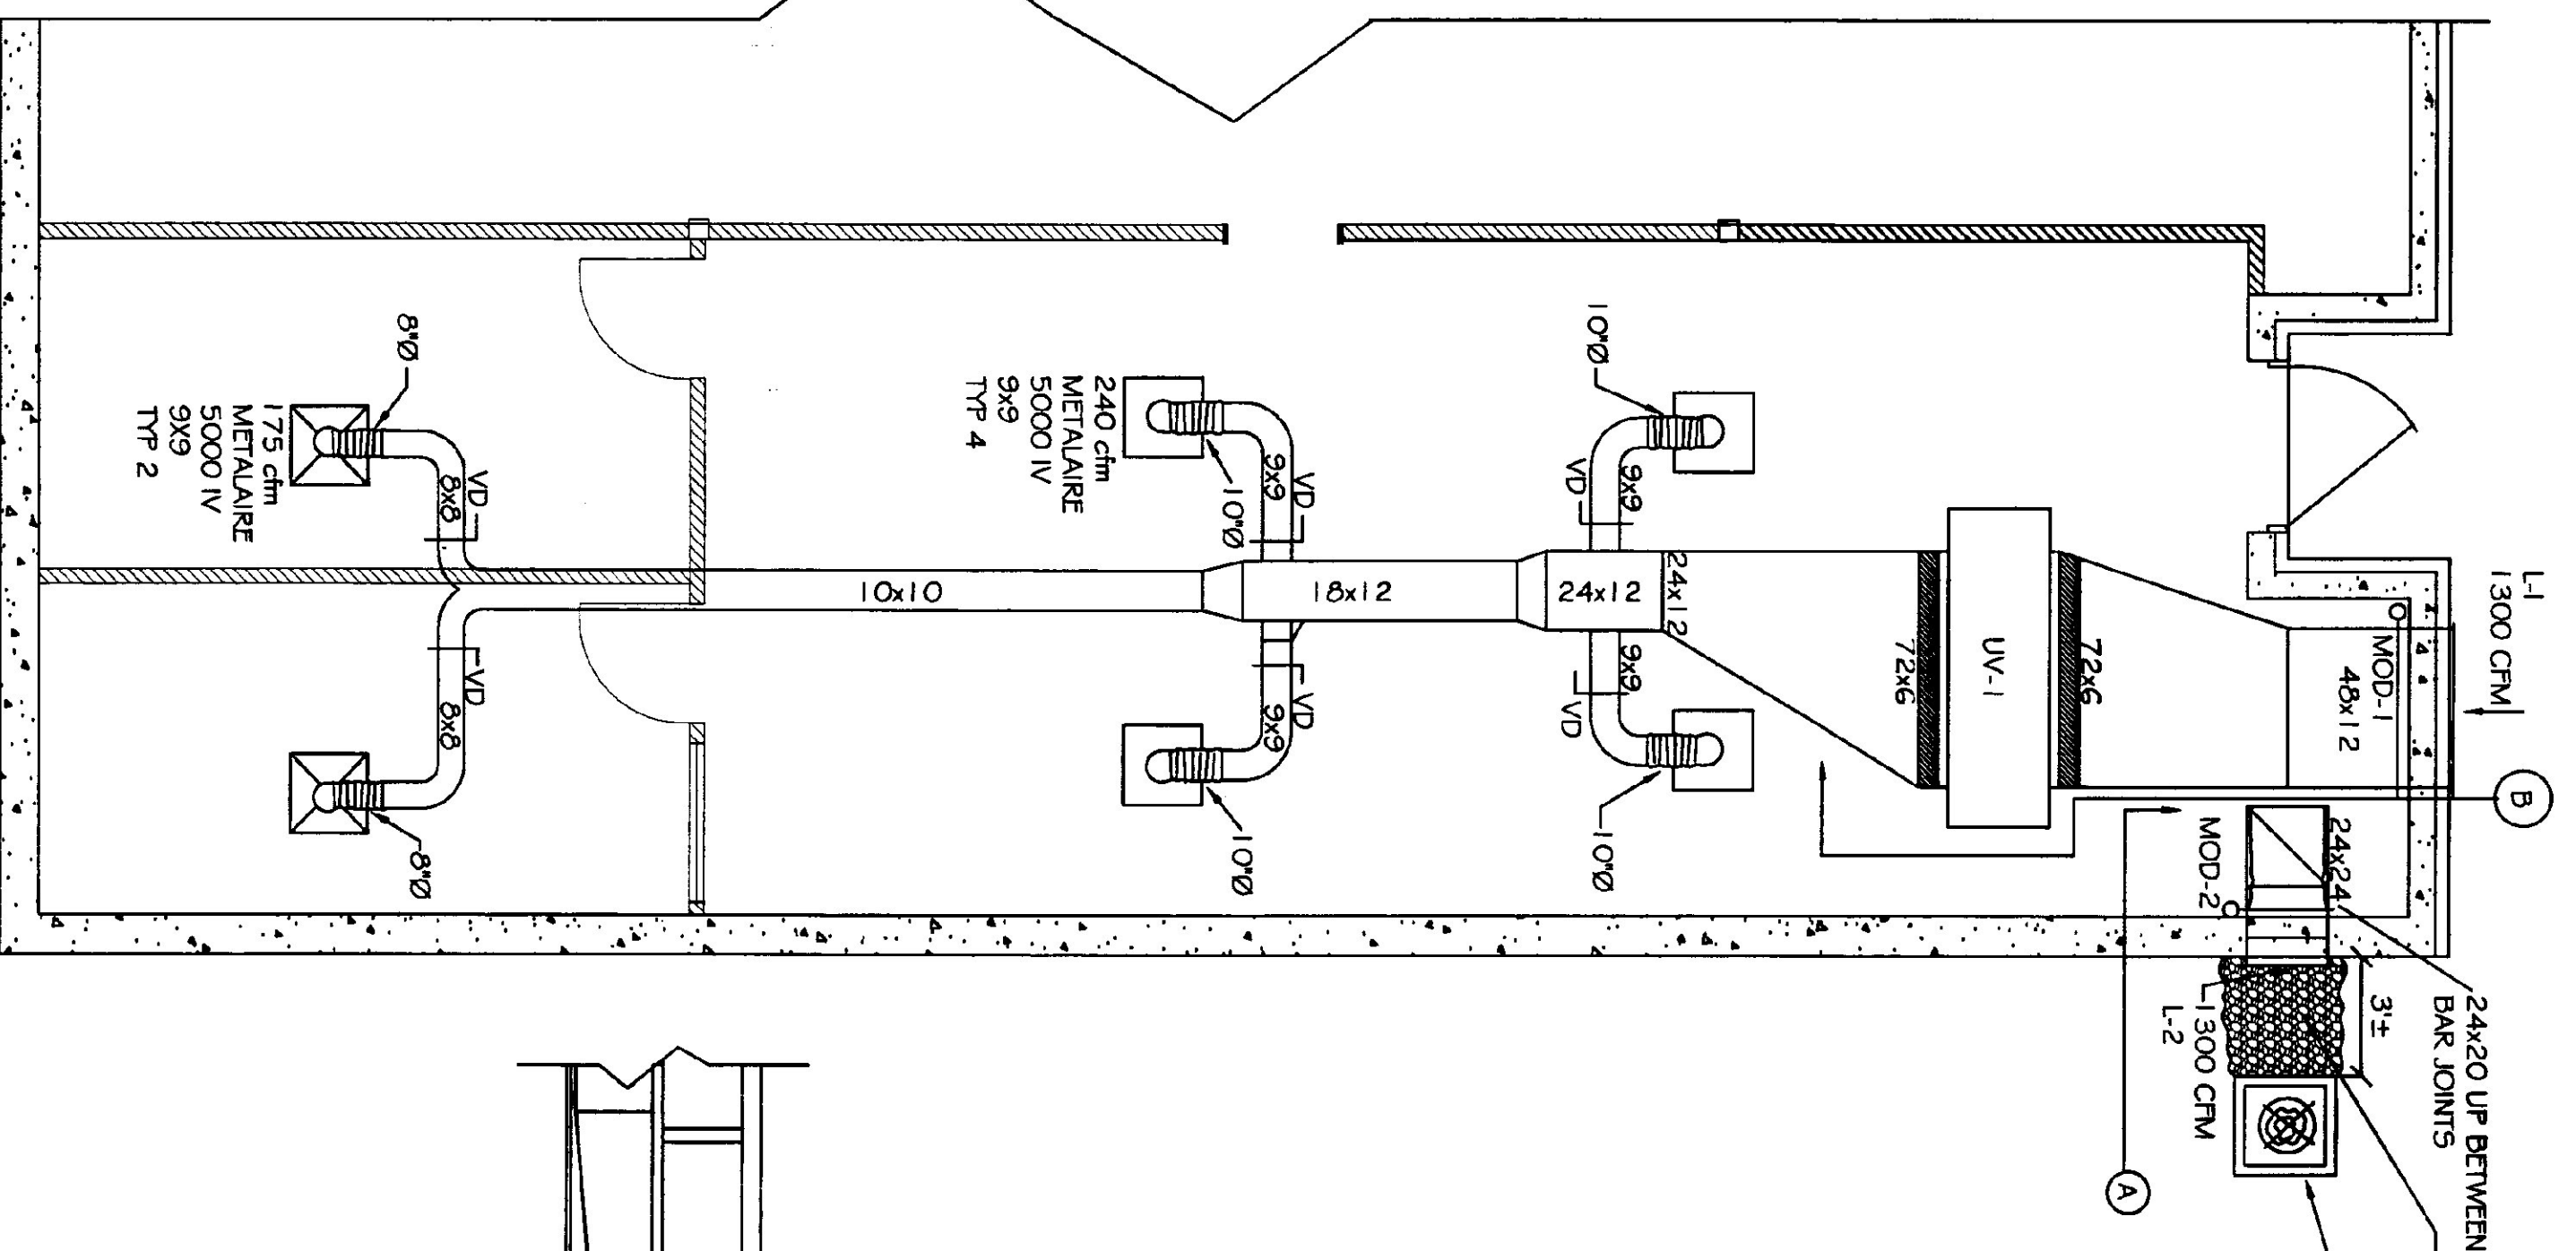


NEW BASEMENT FLOOR PLAN
SCALE: 1/4" = 1'-0"

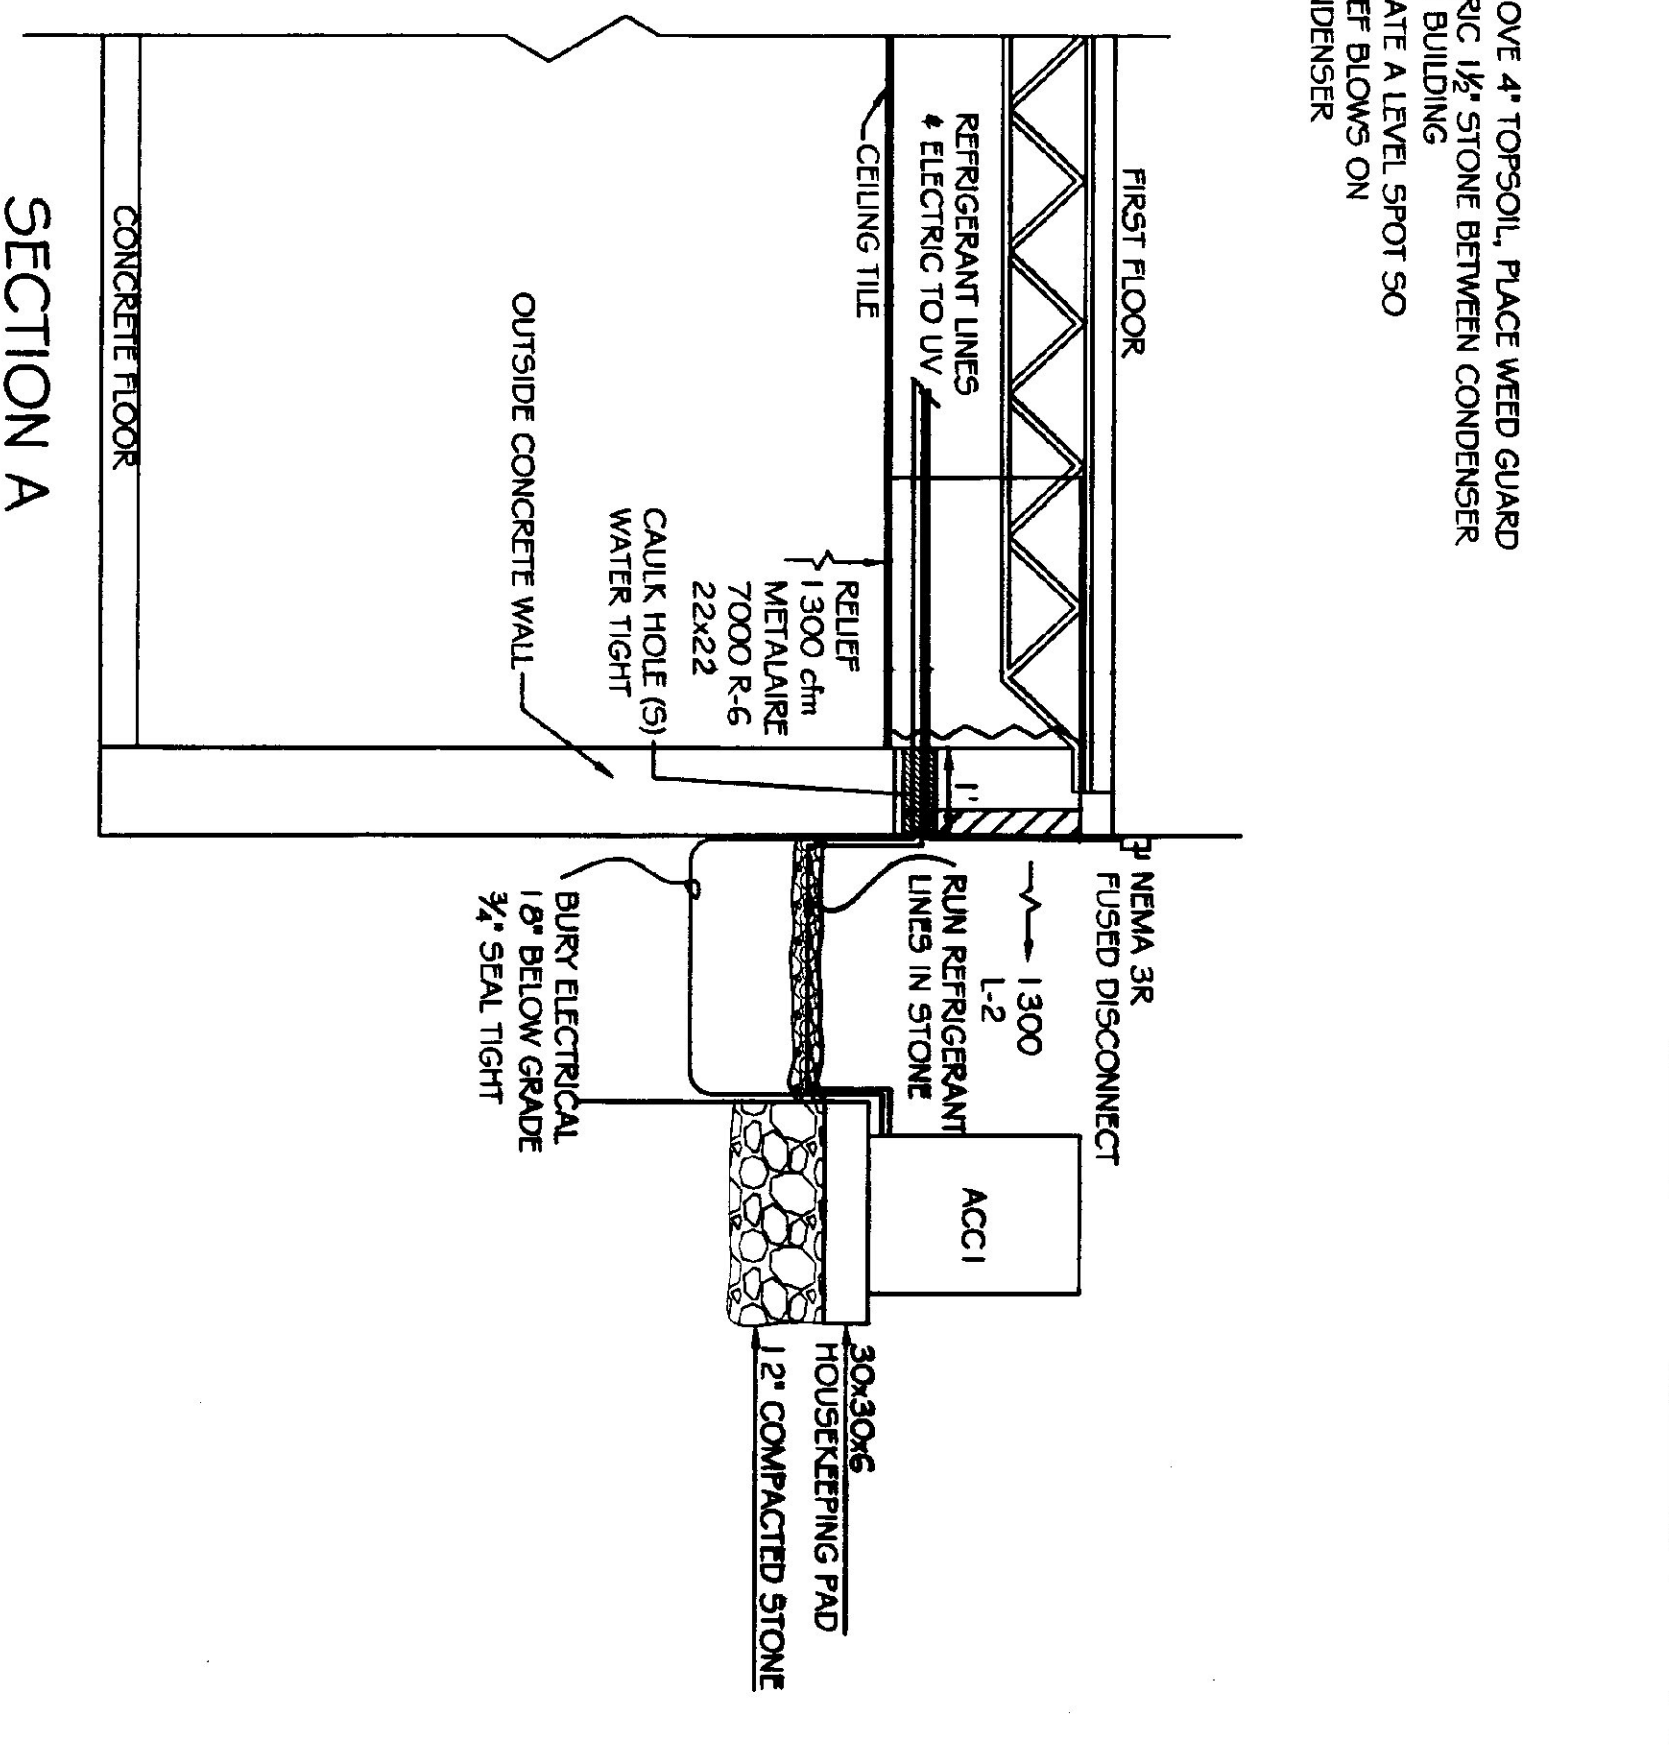

SECTION A
SCALE: 1/2" = 1'-0"

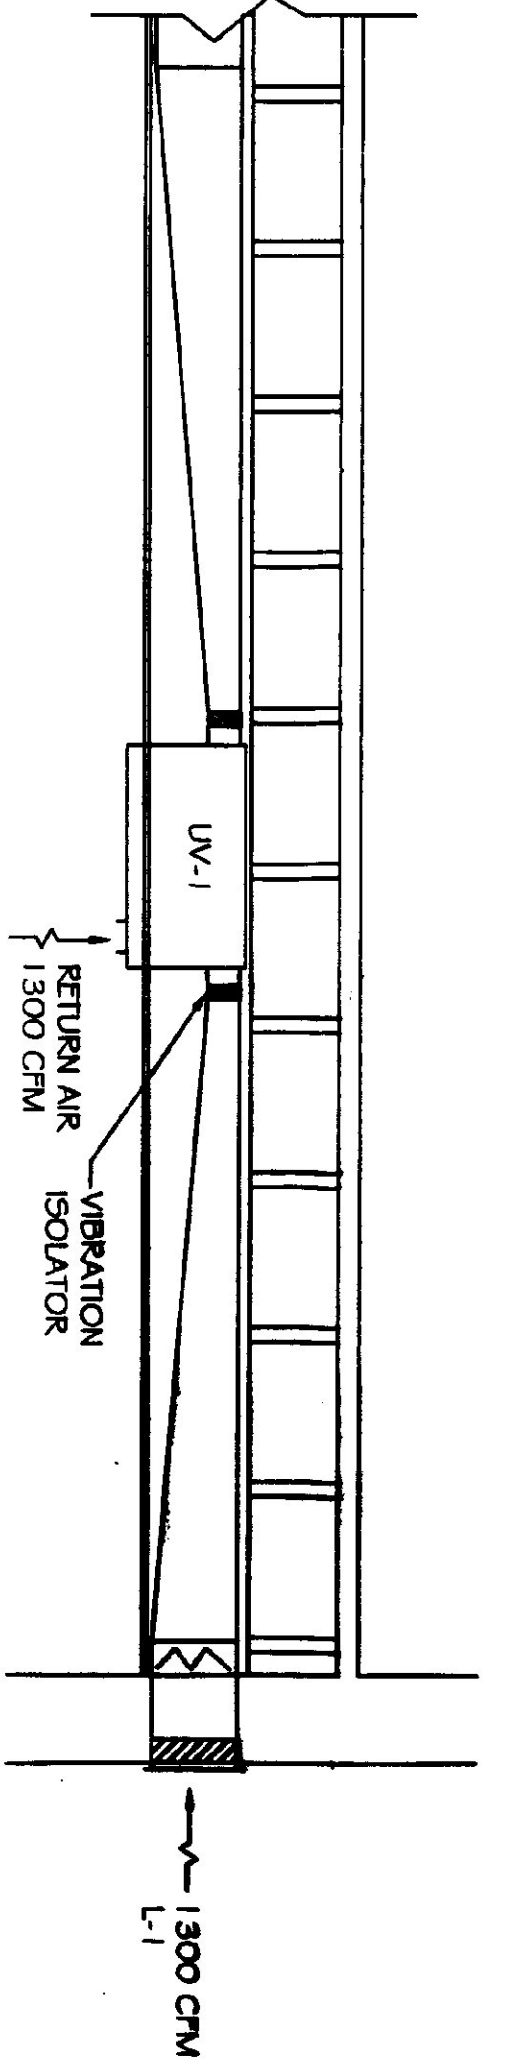


SECTION B
SCALE: 1/4" = 1'-0"

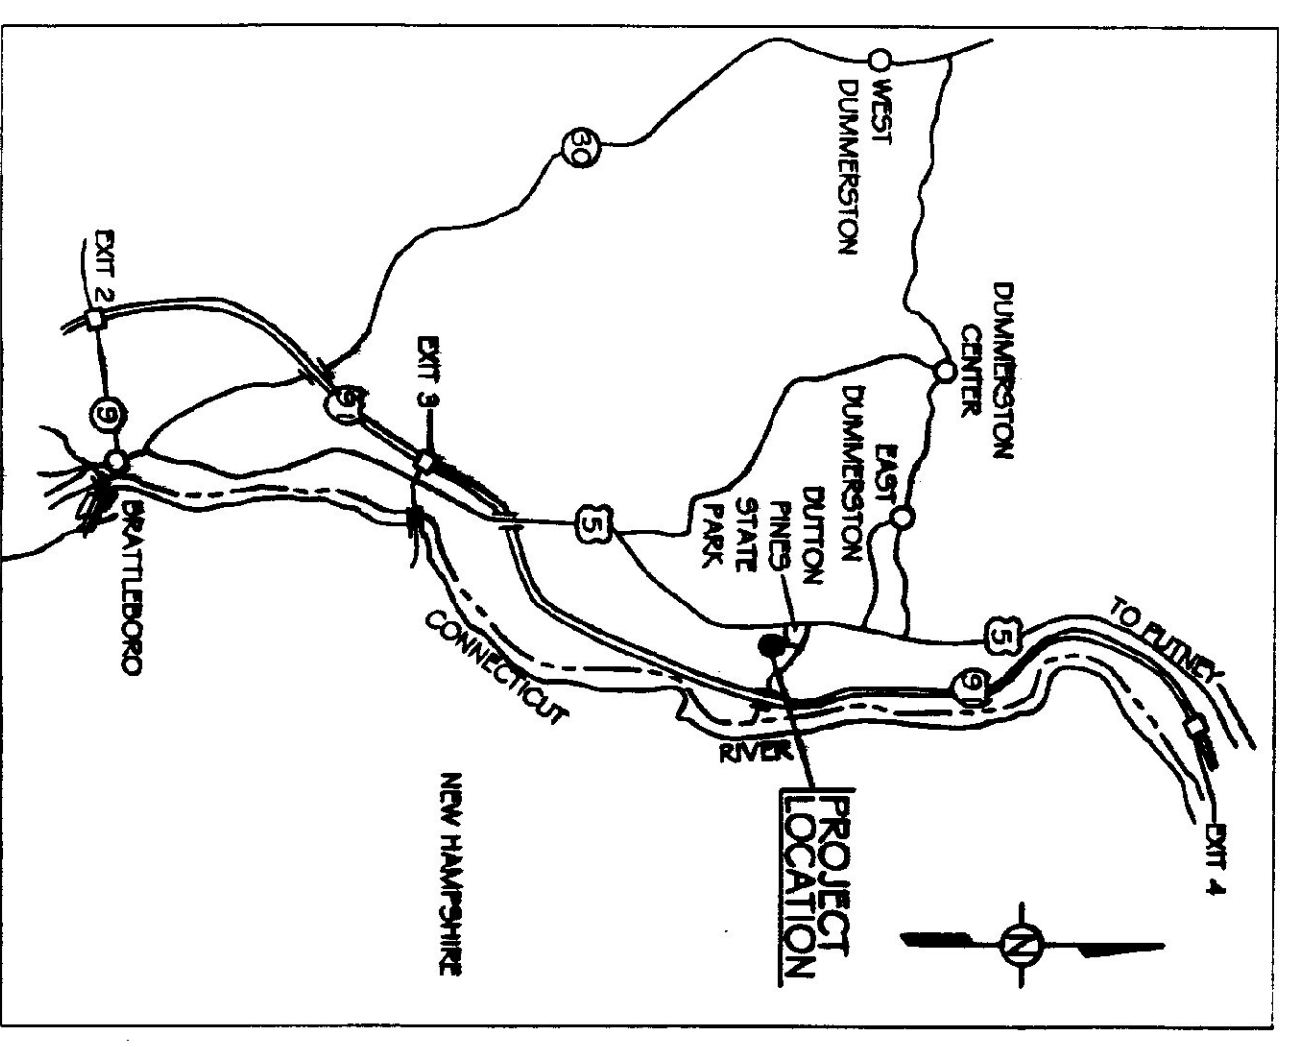

<p>A-1 1 OF 1</p>	SCALE:	1/4" = 1'-0"
	DATE:	AUGUST 2003
	DRAWN BY:	K. ROUELLE
	APP. BY:	SOUTHMOOR

AGENCY OF TRANSPORTATION
 DUMMERSTON OFFICE BUILDING
 NEW BASEMENT FLOOR PLAN & HVAC



STATE OF VERMONT
 Department of Buildings
 and General Services
 Agency of Administration
 Montpelier, Vermont

