

NEW REGIONAL EMERGENCY
OPERATING CENTER

DEPARTMENT OF PUBLIC SAFETY
CIVIL DEFENSE DIVISION

DUMMERSTON, VERMONT

CHARLES A. BRISTOW, COMM.

DEPARTMENT OF STATE BUILDINGS

JOHN J. ZAMPIERI, COMM.

ARCHITECTS:



GORDON G. WOODS ASSOC. ARCHITECTS, BURLINGTON VERMONT

MECHANICAL ELECTRICAL ENGINEERS:

RICHARD D KIMBALL CO. READING MASSACHUSETTS

STRUCTURAL ENGINEERS:

KNIGHT CONSULTING ENGINEERS INC. WILLISTON, VERMONT

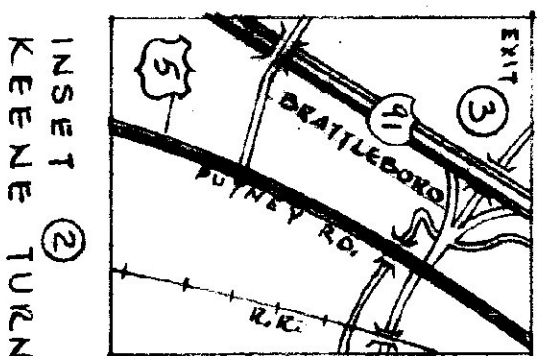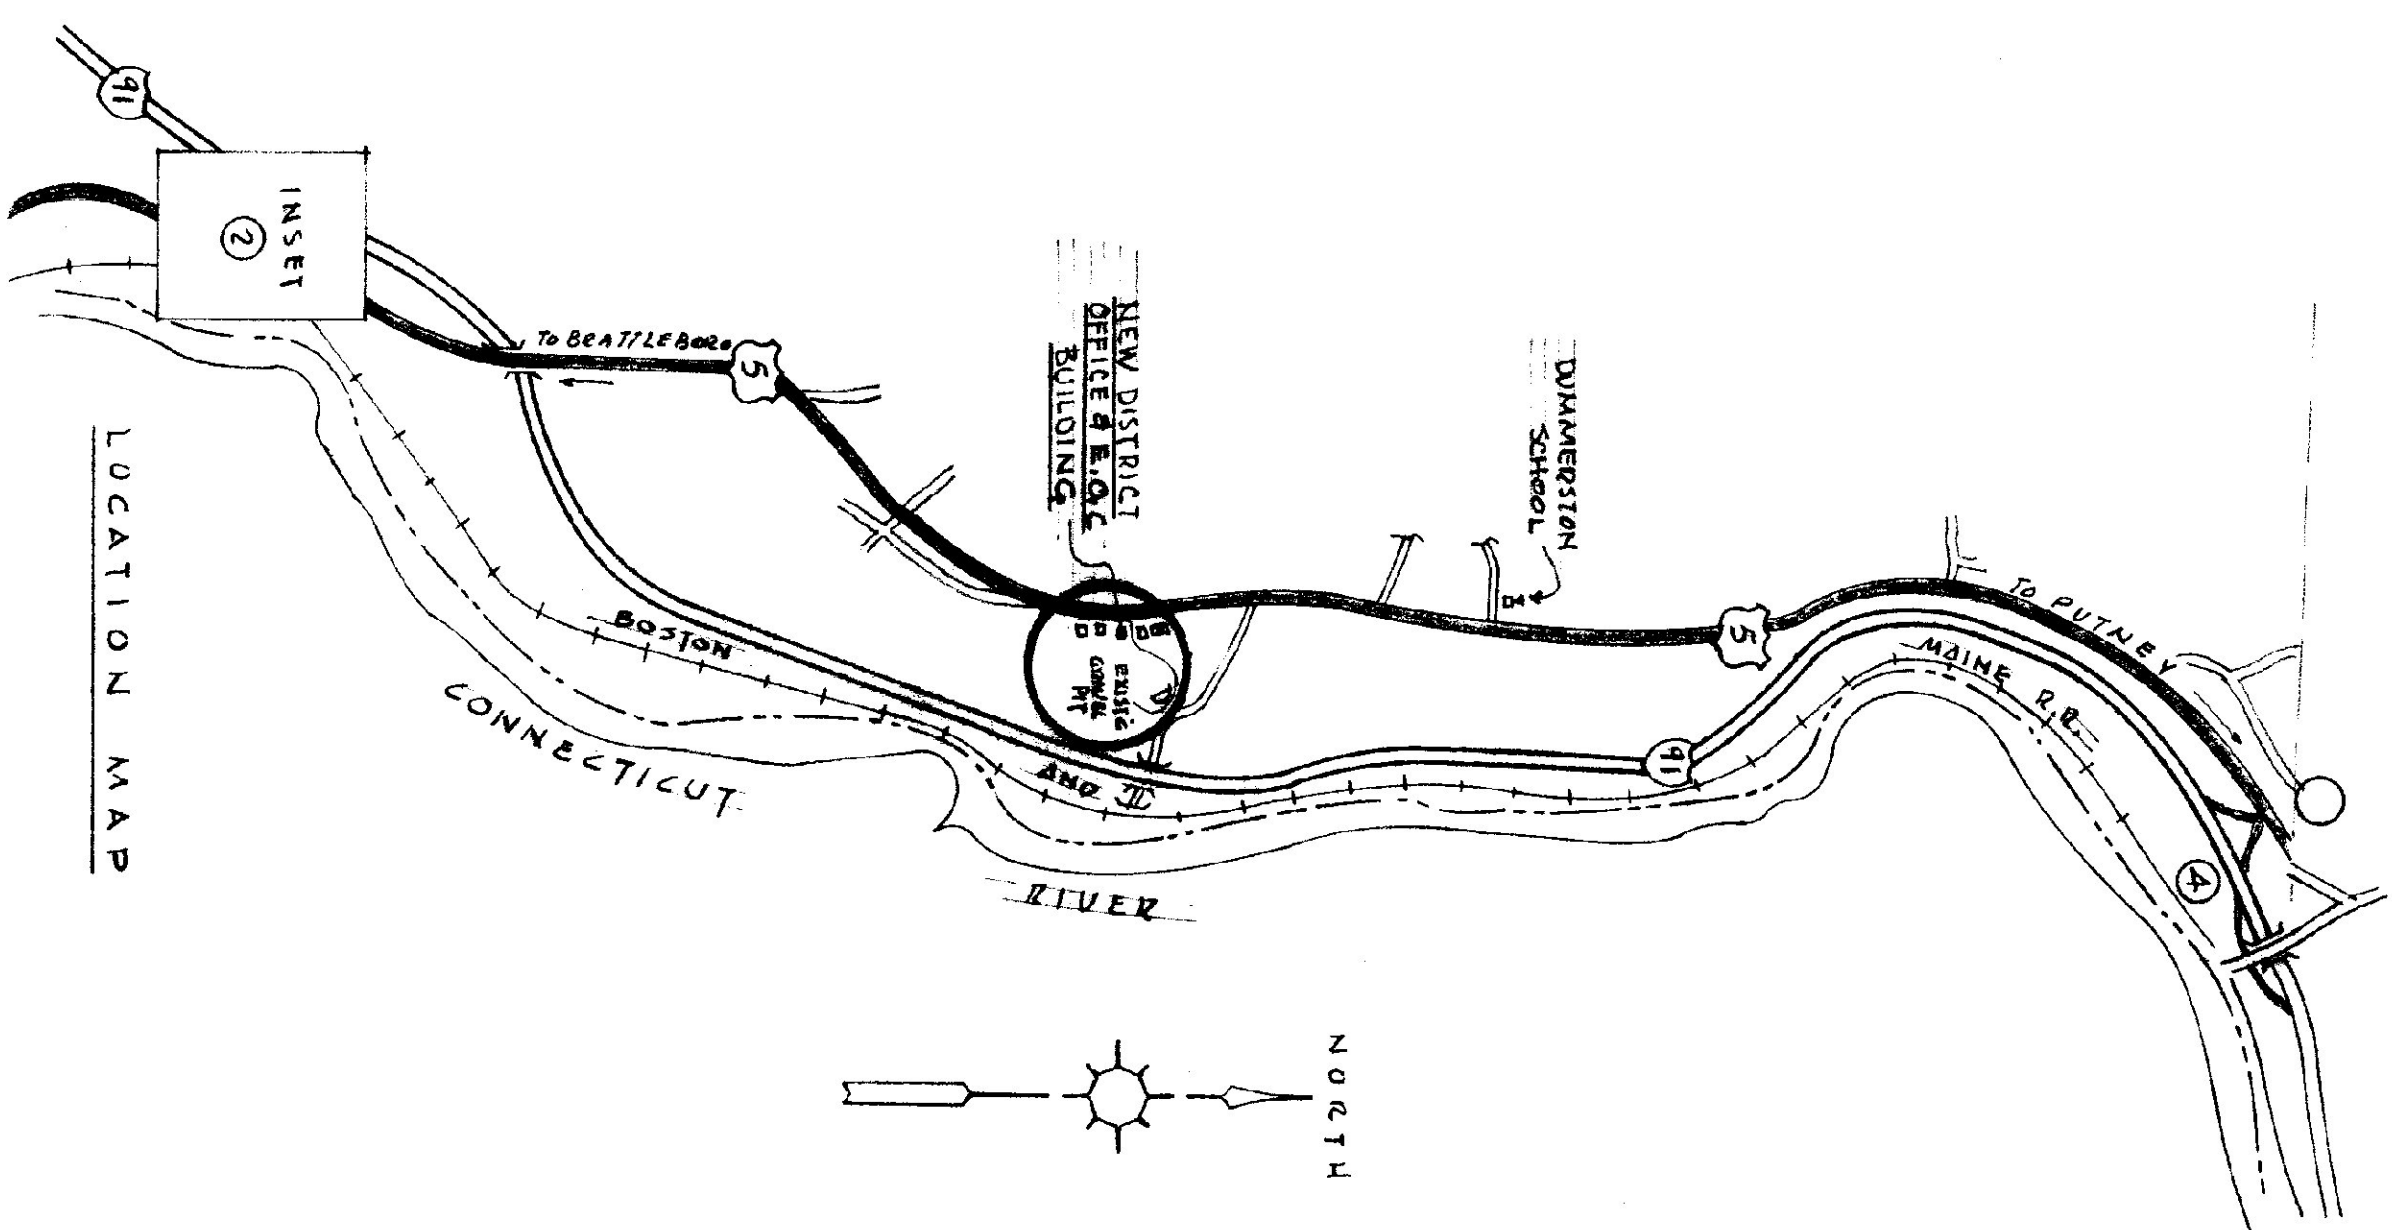

REVISIONS	BY

REGIONAL EMERGENCY OPERATING CENTER
STATE OF VERMONT - STATE BUILDINGS DEPT.
CIVIL DEFENSE DIV. DUMMERSTON, VERMONT
GORDON G. WOODS ASSOC. ARCHITECTS, BURLINGTON, VERMONT

DRAWN BY: **SM/dw/SW**
 CHECKED: **CS**
 DATE: **MAR. 27 1985**
 SCALE: **NONE**
 JOB NO.: **4420**
 SHEET: **6** OF **6**
CS Ed.C.
 INSET KEENE TURN

ARCHITECTURAL DRAWINGS

- CS. COVER SHEET - EMERGENCY OPERATING CENTER
- R-1 REFERENCE SHEET - E.O.C. SITE PLANS - SEE SP1 & SP2
- A-1 LOWER LEVEL - EMERGENCY OPERATING CENTER SECTIONS & DETAILS - E.O.C.
- G-1 LOWER LEVEL - EMERGENCY OPERATING CENTER - CEILING LAYOUT
- M-1 LOWER LEVEL - EMERGENCY OPERATING CENTER - MASTER PLAN

STRUCTURAL

STRUCTURAL PLANS - SEE AGENCY OF TRANSPORTATION DRAWINGS

MECHANICAL & ELECTRICAL

- P-1 LOWER LEVEL - EMERGENCY OPERATING CENTER - PLUMBING
- P-2 LOWER LEVEL - EMERGENCY OPERATING CENTER - SIGN DIAGRAMS
- HVAC - 1 LOWER LEVEL - EMERGENCY OPERATING CENTER - HEATING
- HVAC - 2 LOWER LEVEL - EMERGENCY OPERATING CENTER - DETAILS
- E-1 LOWER LEVEL - EMERGENCY OPERATING CENTER - ELECTRIC
- E-2 LOWER LEVEL - EMERGENCY OPERATING CENTER - POWER
- L-1 LOWER LEVEL - EMERGENCY OPERATING CENTER - LIGHTING

ABBREVIATIONS

ABB.	DESCRIPTION	SHRT.	SHEET
A.F.F.	ABOVE FINISH FLOOR	SPEC. INSTR.	SPECIAL INSTRUCTION
ALT.	ALTERNATE	STL.	STEEL
BIT. CONG.	BITUMINOUS CONCRETE	STOR.	STORAGE
CHI.	CEILING HEIGHT	TEMP.	TEMPERED
CHAN.	CHANNEL	TRK.	THICK
C.J.	CONTROL JOINT	T.O.S.	TOP OF STEEL
CLF.	CEILING	TRK.	TYPICAL
CMU.	CONCRETE MASONRY UNIT	UR.	ORIGINAL
CONC.	CONCRETE	VAR.	VARIABLE
CONF.	CONFERENCE	VAT.	VINYL ASBESTOS TILE
DRWA.	DRAWING	VEST.	VESTIBULE
ELEV.	ELEVATION	W.C.T.	WAINSCOT
FIN.	FINISH		
FL.	FLOOR		
GYP. BD.	GYPSUM BOARD		
H.M.	HOLLOW METAL		
H.P.	HIGH POINT		
HT.	HEIGHT		
JT.	JOINT		
LAV.	LAVATORY		
MET.	METAL		
MAT.	MATERIAL		
O.C.	ON CENTER		
P.C.C.	PRECAST CONCRETE CURB		
R.D.	ROOF DRAIN		
REQ'D	REQUIRED		

DRAWING SYMBOLS


	CONCRETE MASONRY UNIT		RIGID INSULATION		ROOM NUMBER
	STEEL		BATT INSULATION		SECTION LETTERS SEE SHEET NUMBER
	GYPSUM		SEALANT		DOOR NUMBER
	ROUGH WOOD BLOCKING		ACOUSTIC PANELS		FINISHED ELEVATION
	FINISHED WOOD		LARGER		COLUMN LINE
	CONCRETE				ELEVATION NUMBER SEE SHEET NUMBER
	MORTAR & GROUT				
	GRAVEL				
	COMPACTED SOIL				

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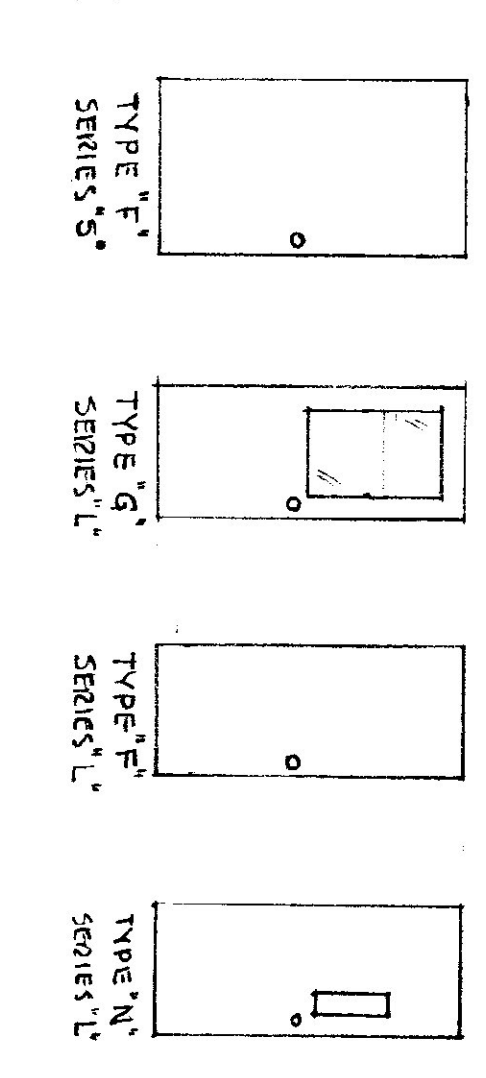
DATE	MAR 25, 1985
SCALE	NONE
JOB NO.	8420
SHEET	6
RI E.O.C.	

REVISIONS	BY
4-885	JW

LOWER LEVEL - EMERGENCY OPERATING CENTER

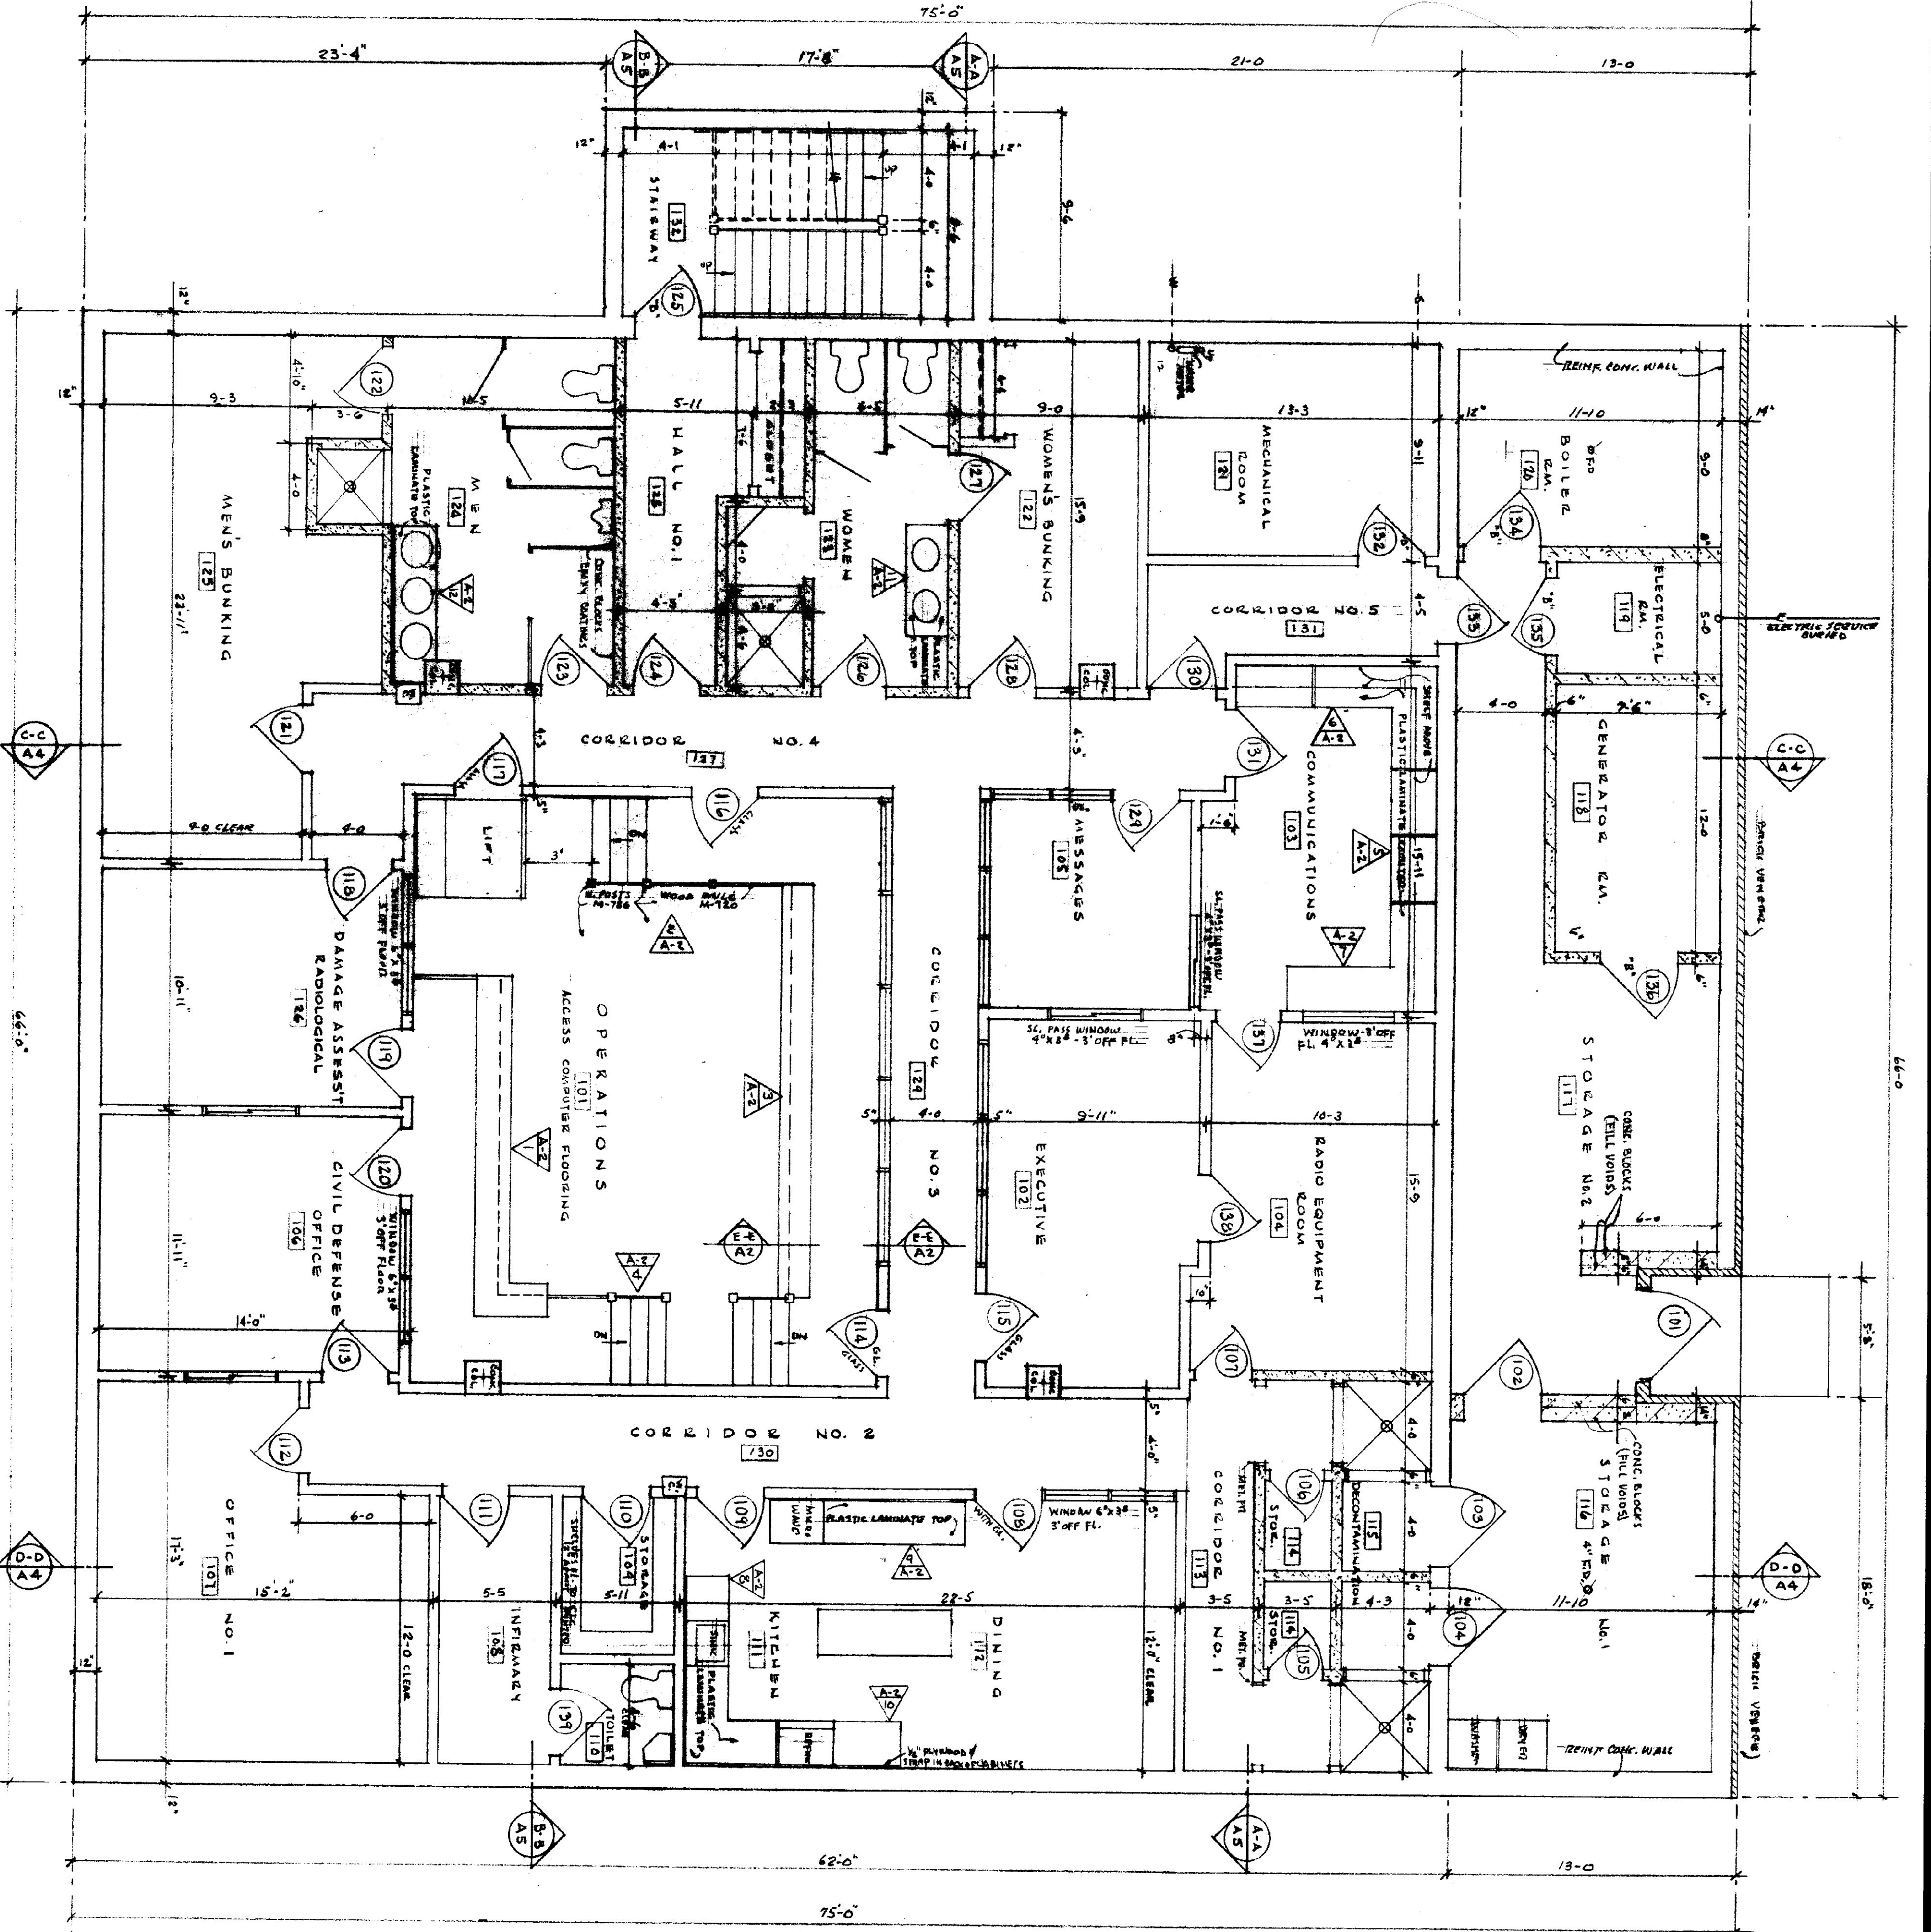

NO.	SIZE	THICK	FRAME	MAT'L	LABEL	BUTTS	REMARKS
101	4' x 11'	3/4"	16 GA. METAL	16 GA. METAL	1/2" PL.	YES	STANDARD TYPE 'F' SERIES
102	3' x 11'	3/4"	"	"	"	"	"
103	3' x 11'	"	"	"	"	"	"
104	3' x 11'	"	"	"	"	"	"
105	2' x 6'	"	"	"	"	"	"
106	2' x 6'	"	"	"	"	"	"
107	2' x 6'	"	"	"	"	"	"
108	3' x 6'	"	"	"	"	"	"
109	3' x 6'	"	"	"	"	"	"
110	3' x 6'	"	"	"	"	"	"
111	3' x 6'	"	"	"	"	"	"
112	3' x 6'	"	"	"	"	"	"
113	3' x 6'	"	"	"	"	"	"
114	3' x 6'	"	"	"	"	"	"
115	3' x 6'	"	"	"	"	"	"
116	3' x 6'	"	"	"	"	"	"
117	3' x 6'	"	"	"	"	"	"
118	3' x 6'	"	"	"	"	"	"
119	3' x 6'	"	"	"	"	"	"
120	3' x 6'	"	"	"	"	"	"
121	3' x 6'	"	"	"	"	"	"
122	3' x 6'	"	"	"	"	"	"
123	3' x 6'	"	"	"	"	"	"
124	3' x 6'	"	"	"	"	"	"
125	3' x 6'	"	"	"	"	"	"
126	3' x 6'	"	"	"	"	"	"
127	3' x 6'	"	"	"	"	"	"
128	3' x 6'	"	"	"	"	"	"
129	3' x 6'	"	"	"	"	"	"
130	3' x 6'	"	"	"	"	"	"
131	3' x 6'	"	"	"	"	"	"
132	3' x 6'	"	"	"	"	"	"
133	3' x 6'	"	"	"	"	"	"
134	3' x 6'	"	"	"	"	"	"
135	3' x 6'	"	"	"	"	"	"
136	3' x 6'	"	"	"	"	"	"




NOTES:
 ALL DIMENSIONS TO BE VERIFIED AT THE SITE BY THE CONTRACTOR. ANY ERROR OR POINT IN QUESTION MUST BE REFERRED TO THE ARCHITECT FOR A DECISION BEFORE PROCEEDING WITH THE WORK.


DRAWN BY: JWB
 CHECKED BY: JWB
 DATE: MAR. 24, 1965
 SCALE: 1/8" = 1'-0"
 JOB NO.: 8421
 SHEET: 6 OF 6

REGIONAL EMERGENCY OPERATING CENTER
 STATE OF VERMONT STATE BUILDINGS DEPT.
 CIVIL DEFENSE DIV., DUMMERSTON VERMONT
 GORDON G. WOODS ASSOC., ARCHITECTS BURLINGTON VERMONT

NO.	DATE	BY	REVISION

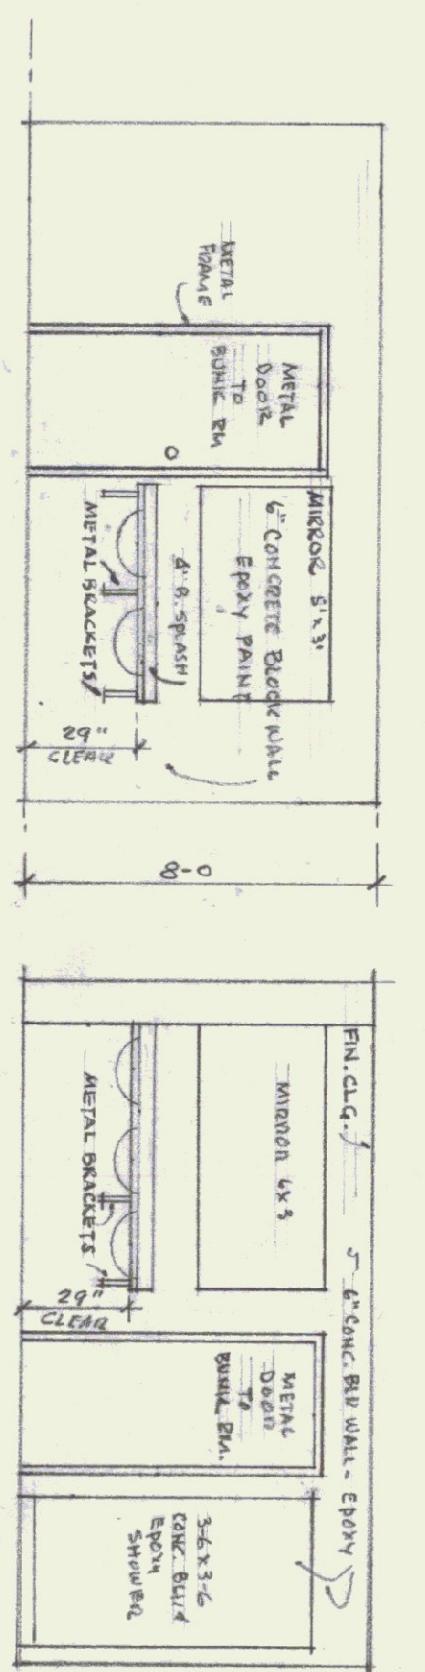


TOILET ELEVATIONS - ABOVE

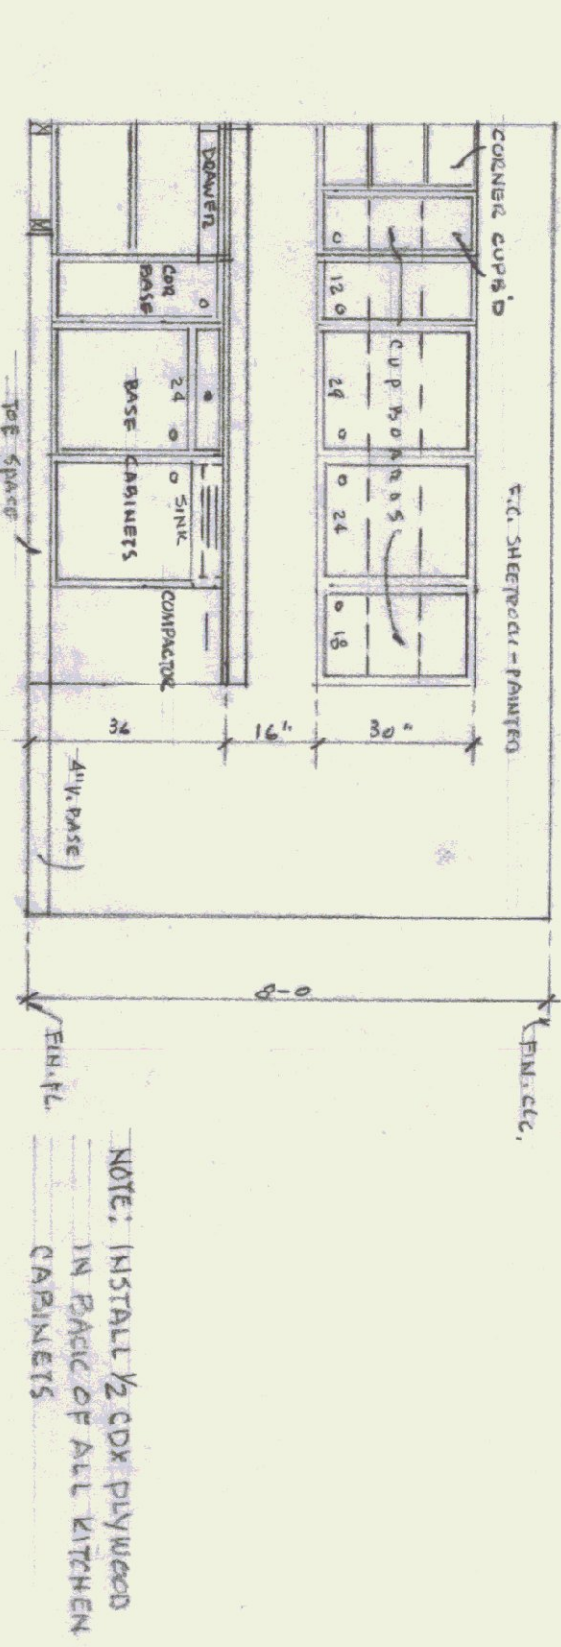

ELEVATION OF SINK WALL
SCALE: 3/8" = 1'-0"


NOTE: INSTALL 1/2 CDX PLYWOOD IN BACK OF ALL KITCHEN CABINETS

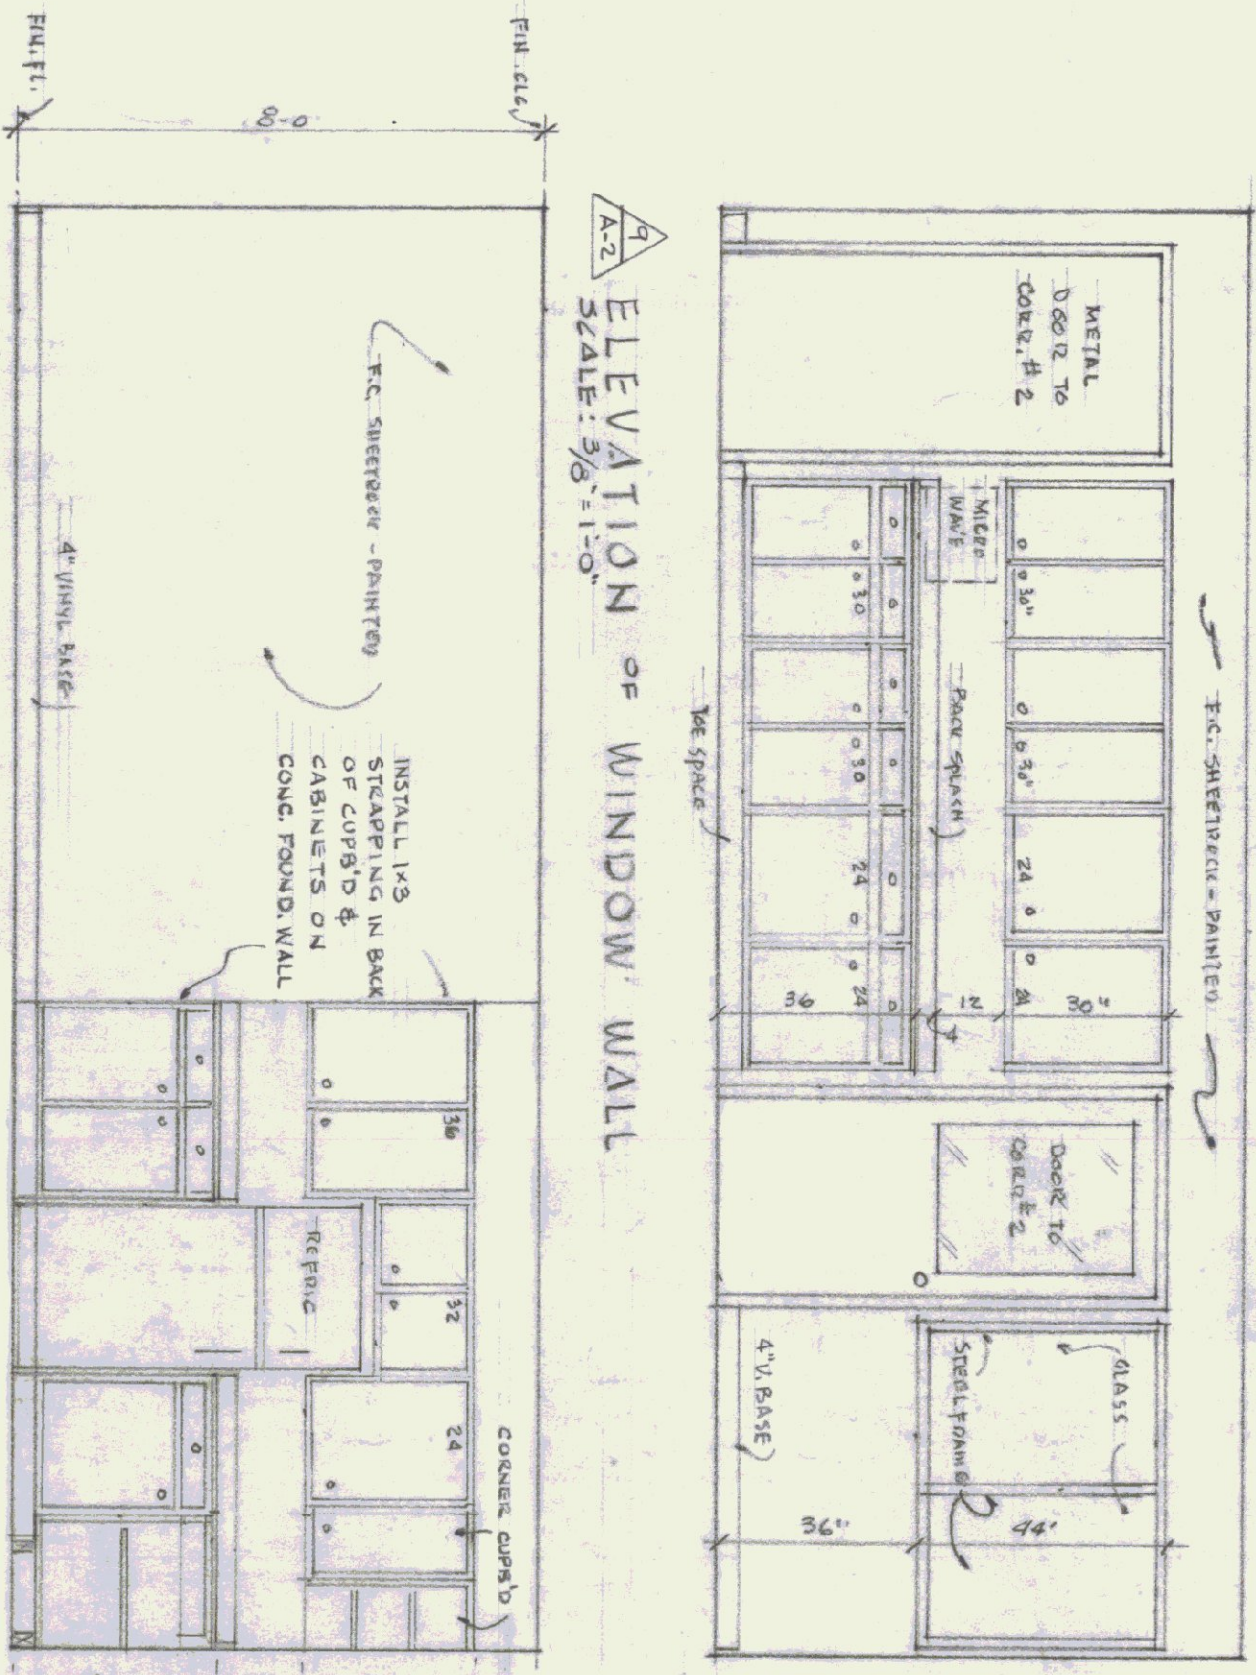


ELEVATION OF WINDOW WALL
SCALE: 3/8" = 1'-0"

ELEVATION OF REFRIGERATOR WALL
SCALE: 3/8" = 1'-0"


KITCHEN ELEVATIONS - ABOVE

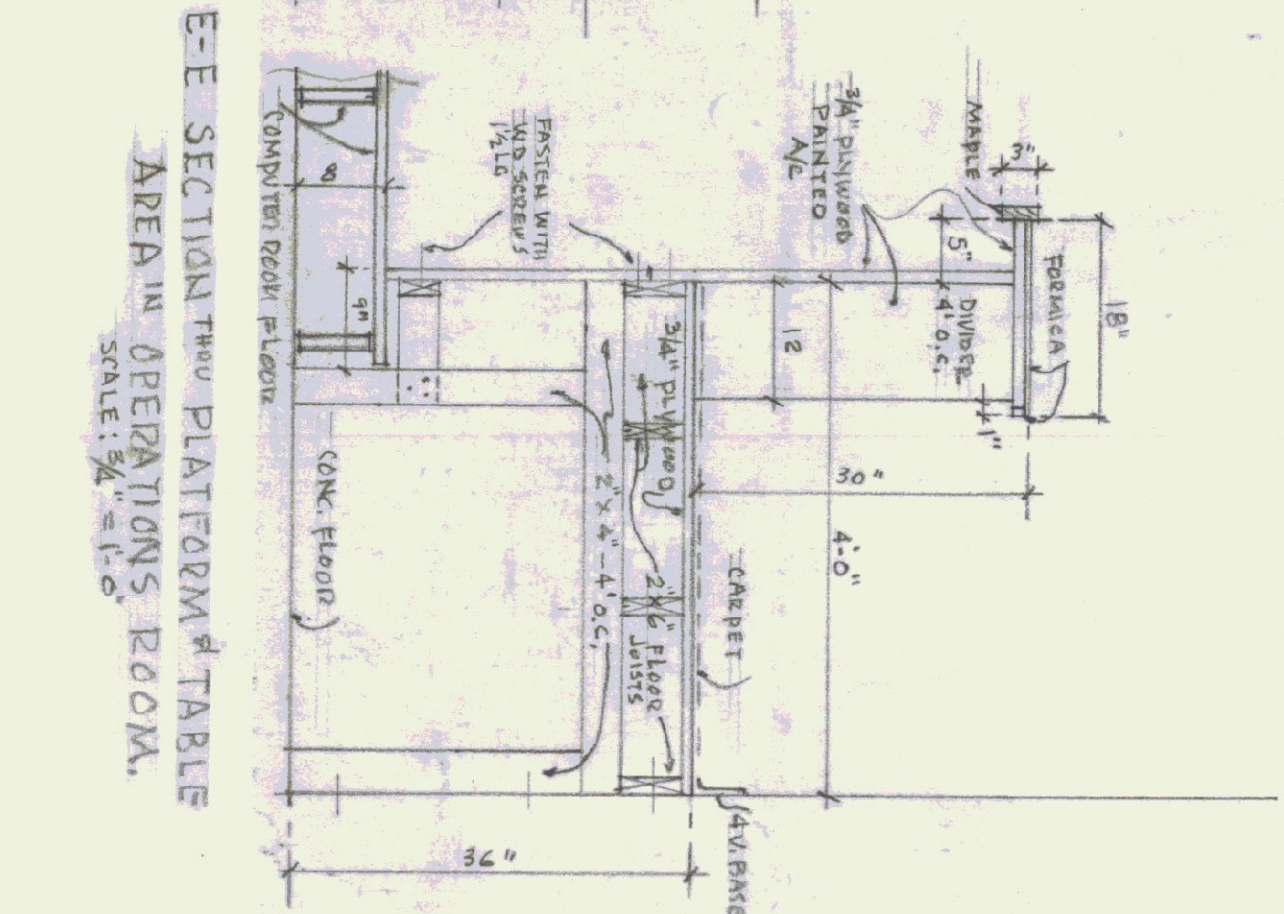

E-E SECTION THRU PLATFORM TABLE AREA IN OPERATIONS ROOM.
SCALE: 3/4" = 1'-0"

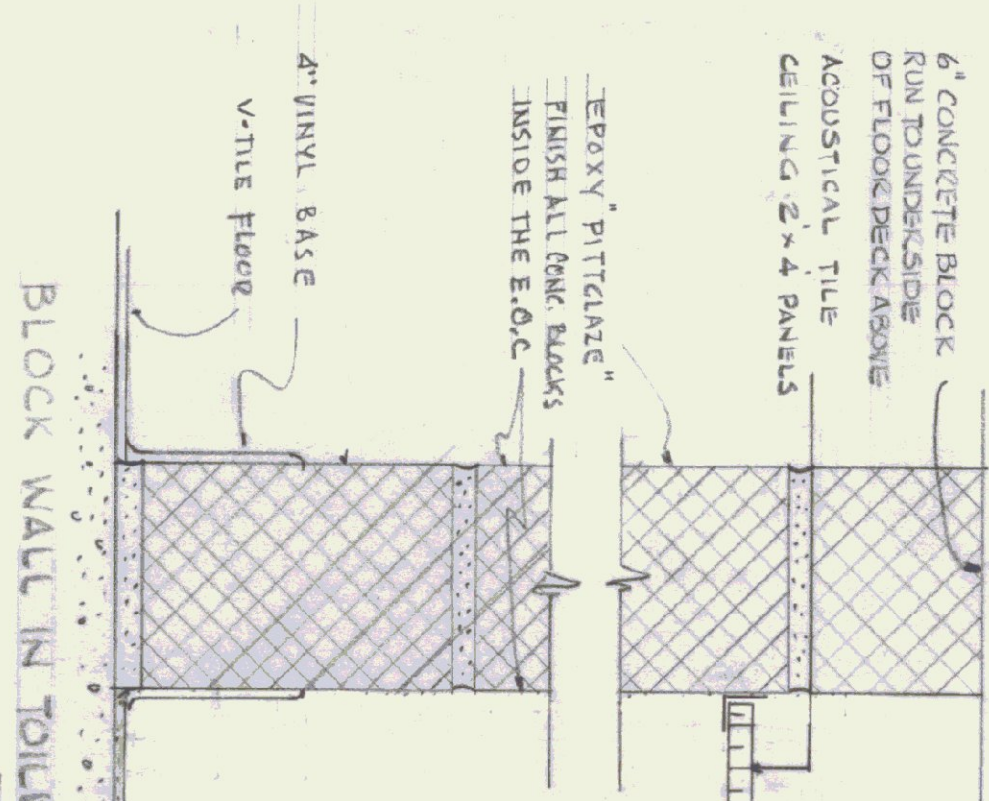


BLOCK WALL IN TOILET ROOMS
SCALE: 3/4" = 1'-0"

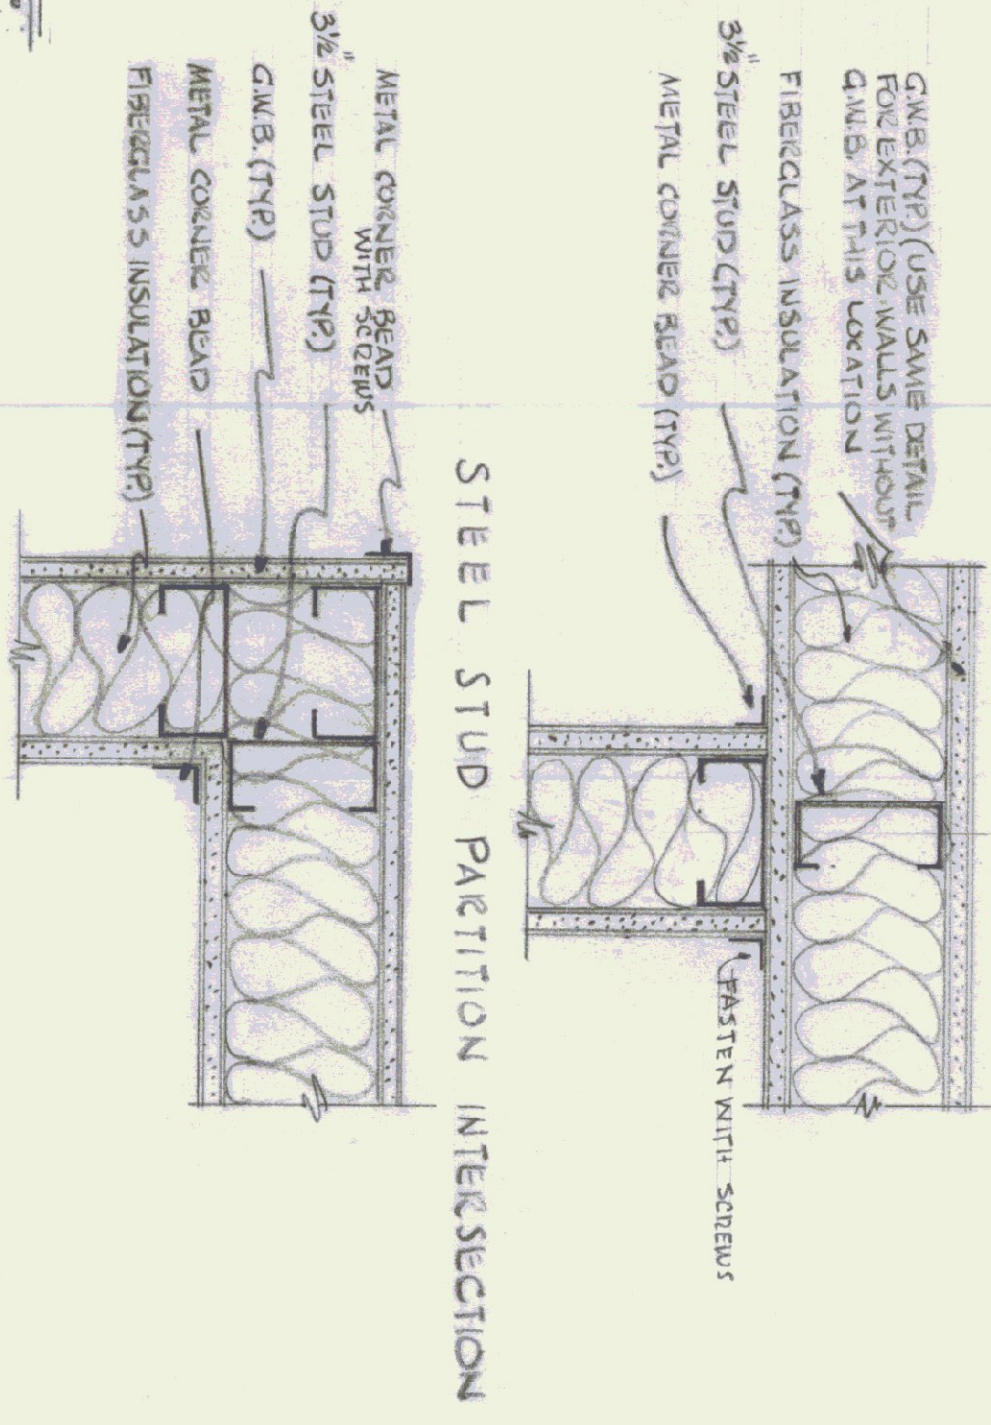


STEEL STUD PARTITIONS @ CORNER
SCALE: 3/4" = 1'-0"

STEEL STUD PARTITION INTERSECTION

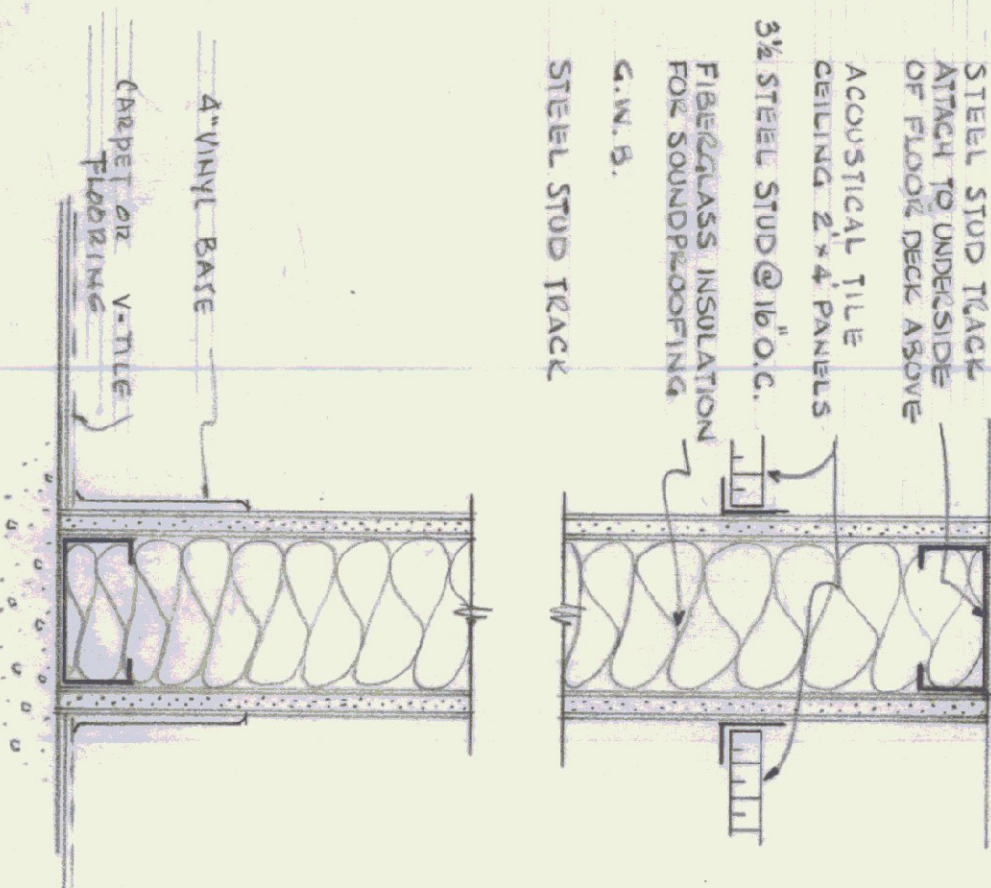

STEEL STUD TRACK

NOTES:
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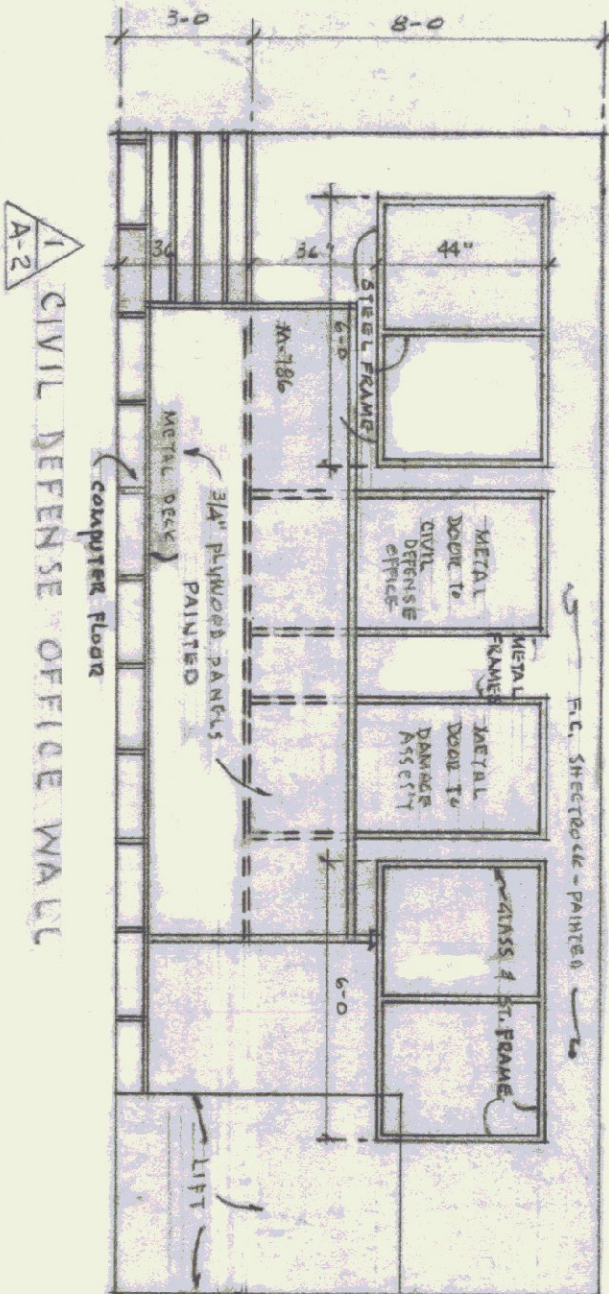


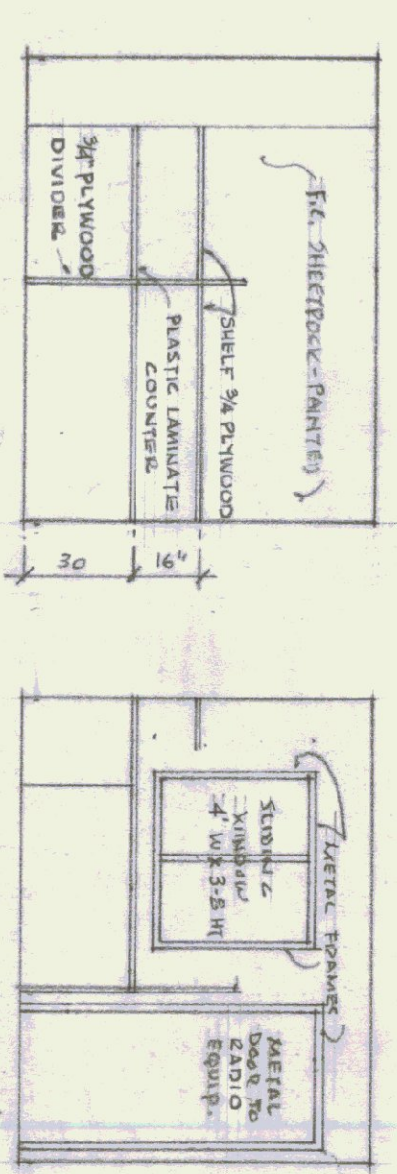STORAGE RM WALL


CORRIDOR NO. 5 WALL

COMMUNICATIONS ELEVATION - ABOVE


RADIO RM. WALL




CIVIL DEFENSE OFFICE WALL

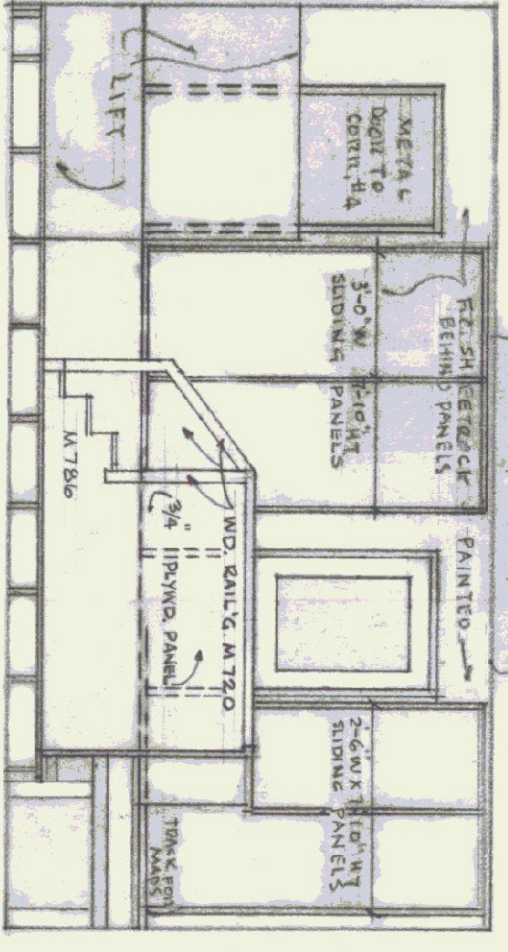

CORRIDOR NO. 4 WALL
SCALE: 3/4" = 1'-0"

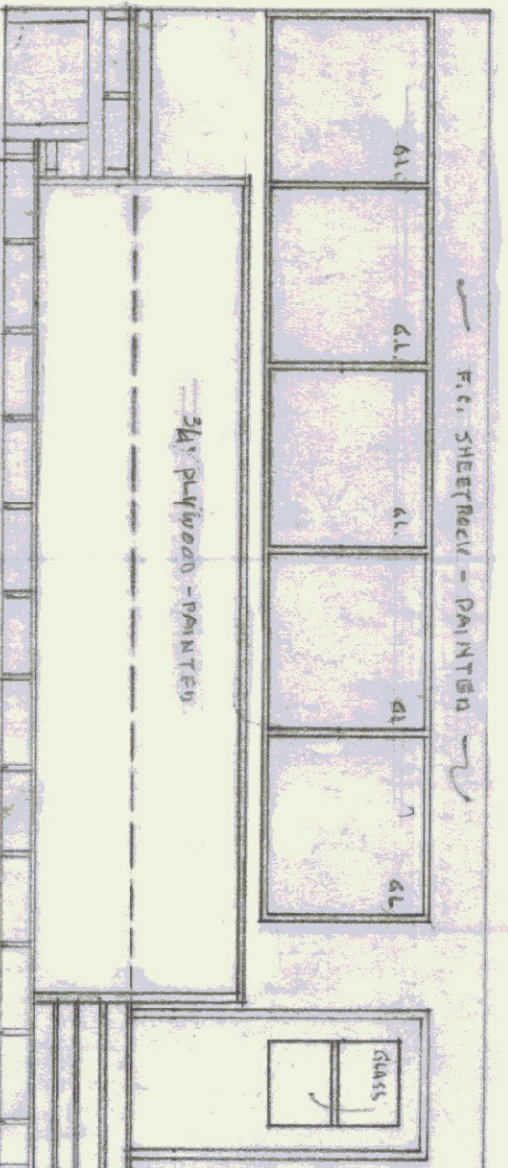

CORRIDOR NO. 3 WALL

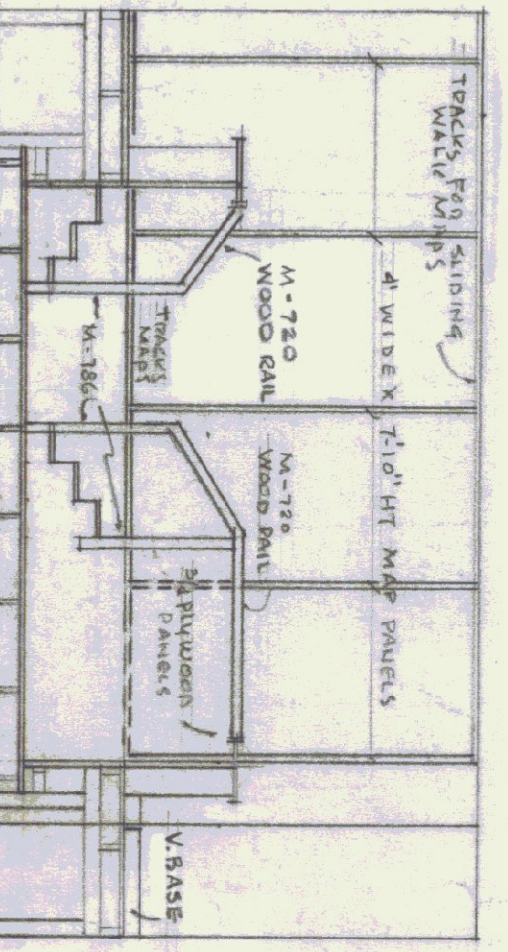


CORRIDOR NO. 2 WALL

REVISIONS	BY
1-8-45	DEWITT BIRU


WATER FOOTINGS TO REST ON UNDISTURBED SOIL

SECTION "A-A" THRU BUILDING

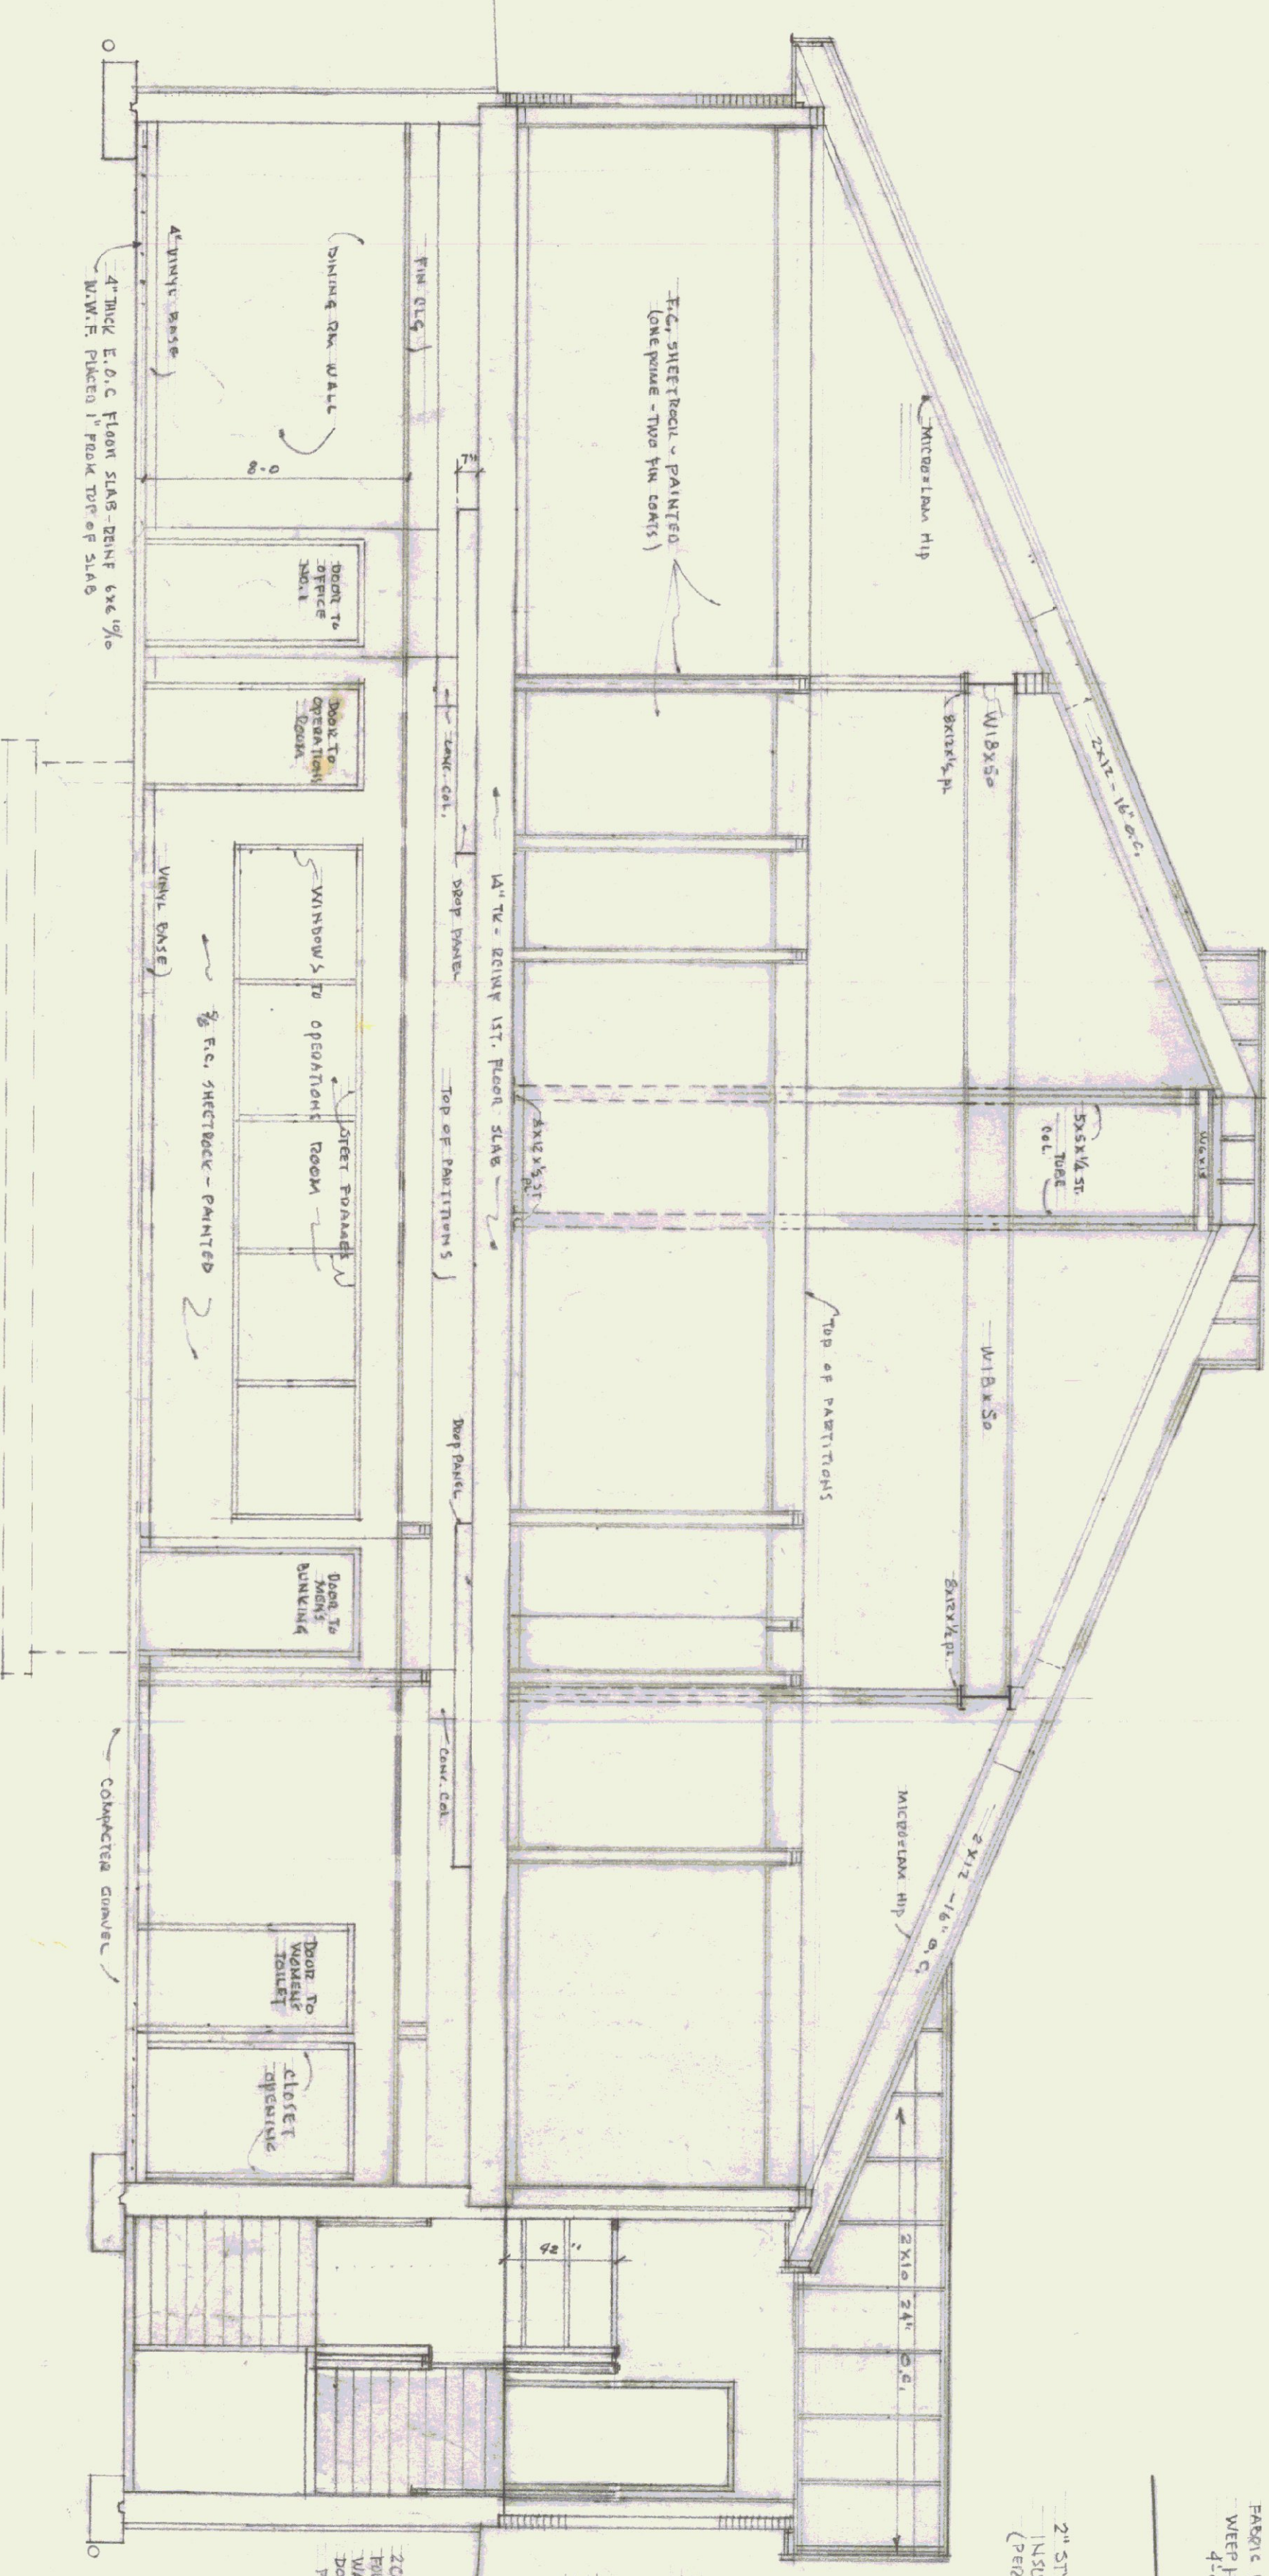

NOTE: FOR DETAILS OF FOUNDATION WALLS & FOOTINGS SEE 9A DETAIL AT RIGHT SIDE OF THIS SHEET


SECTION "B-B" THRU BUILDING

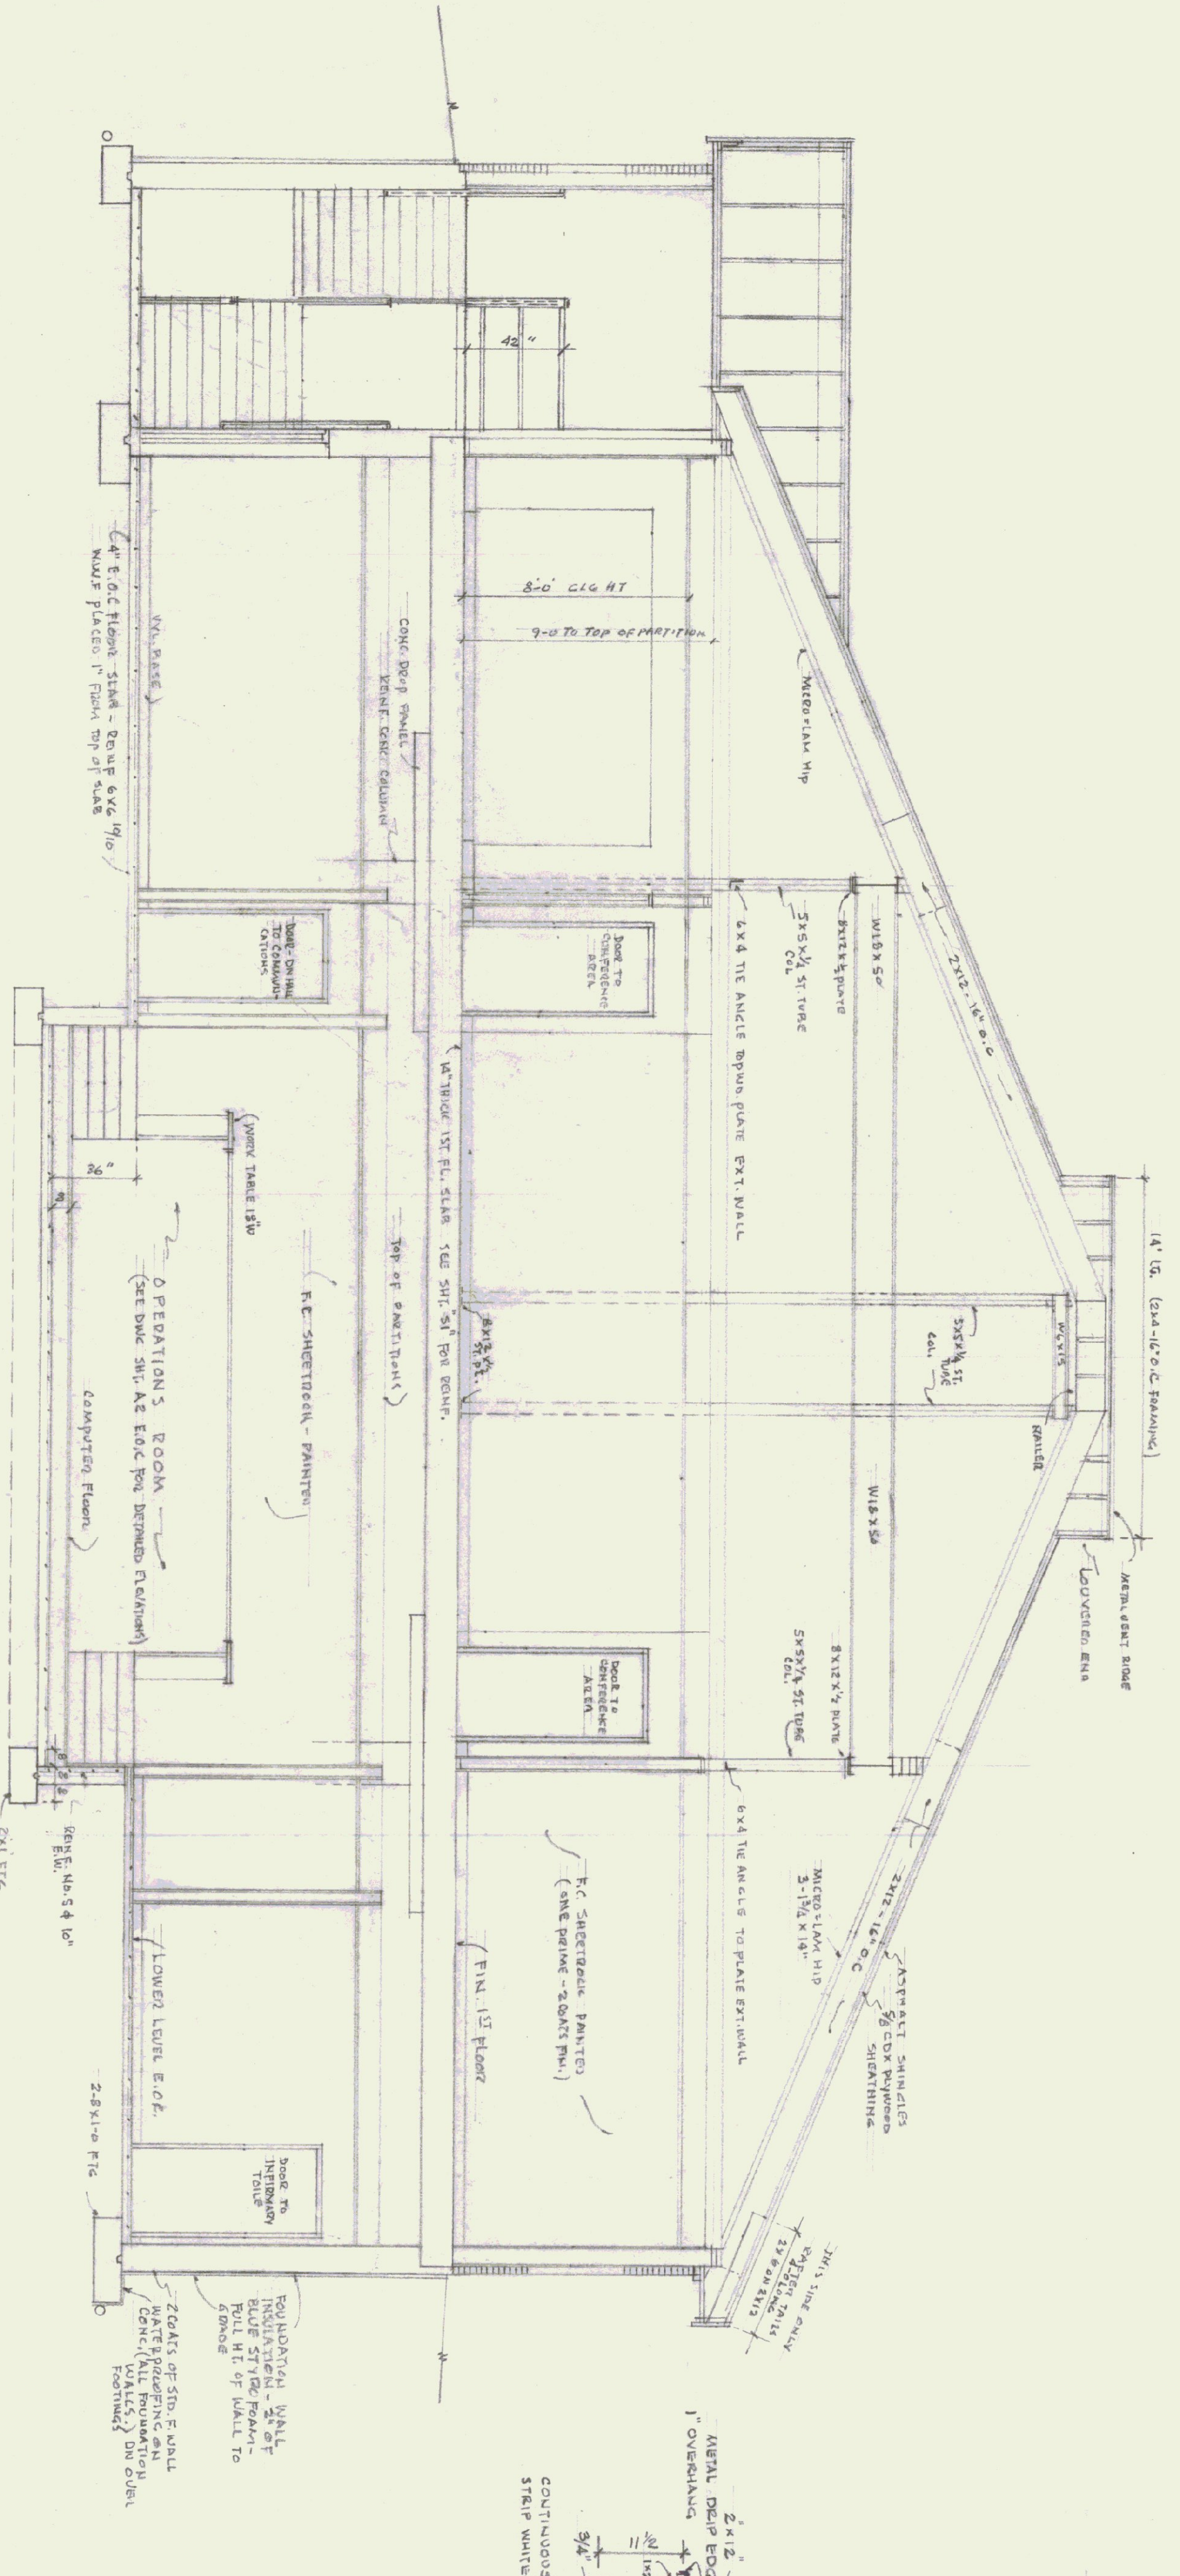

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TYPICAL WALL SECTION

SCALE: 3/4" = 1'-0"

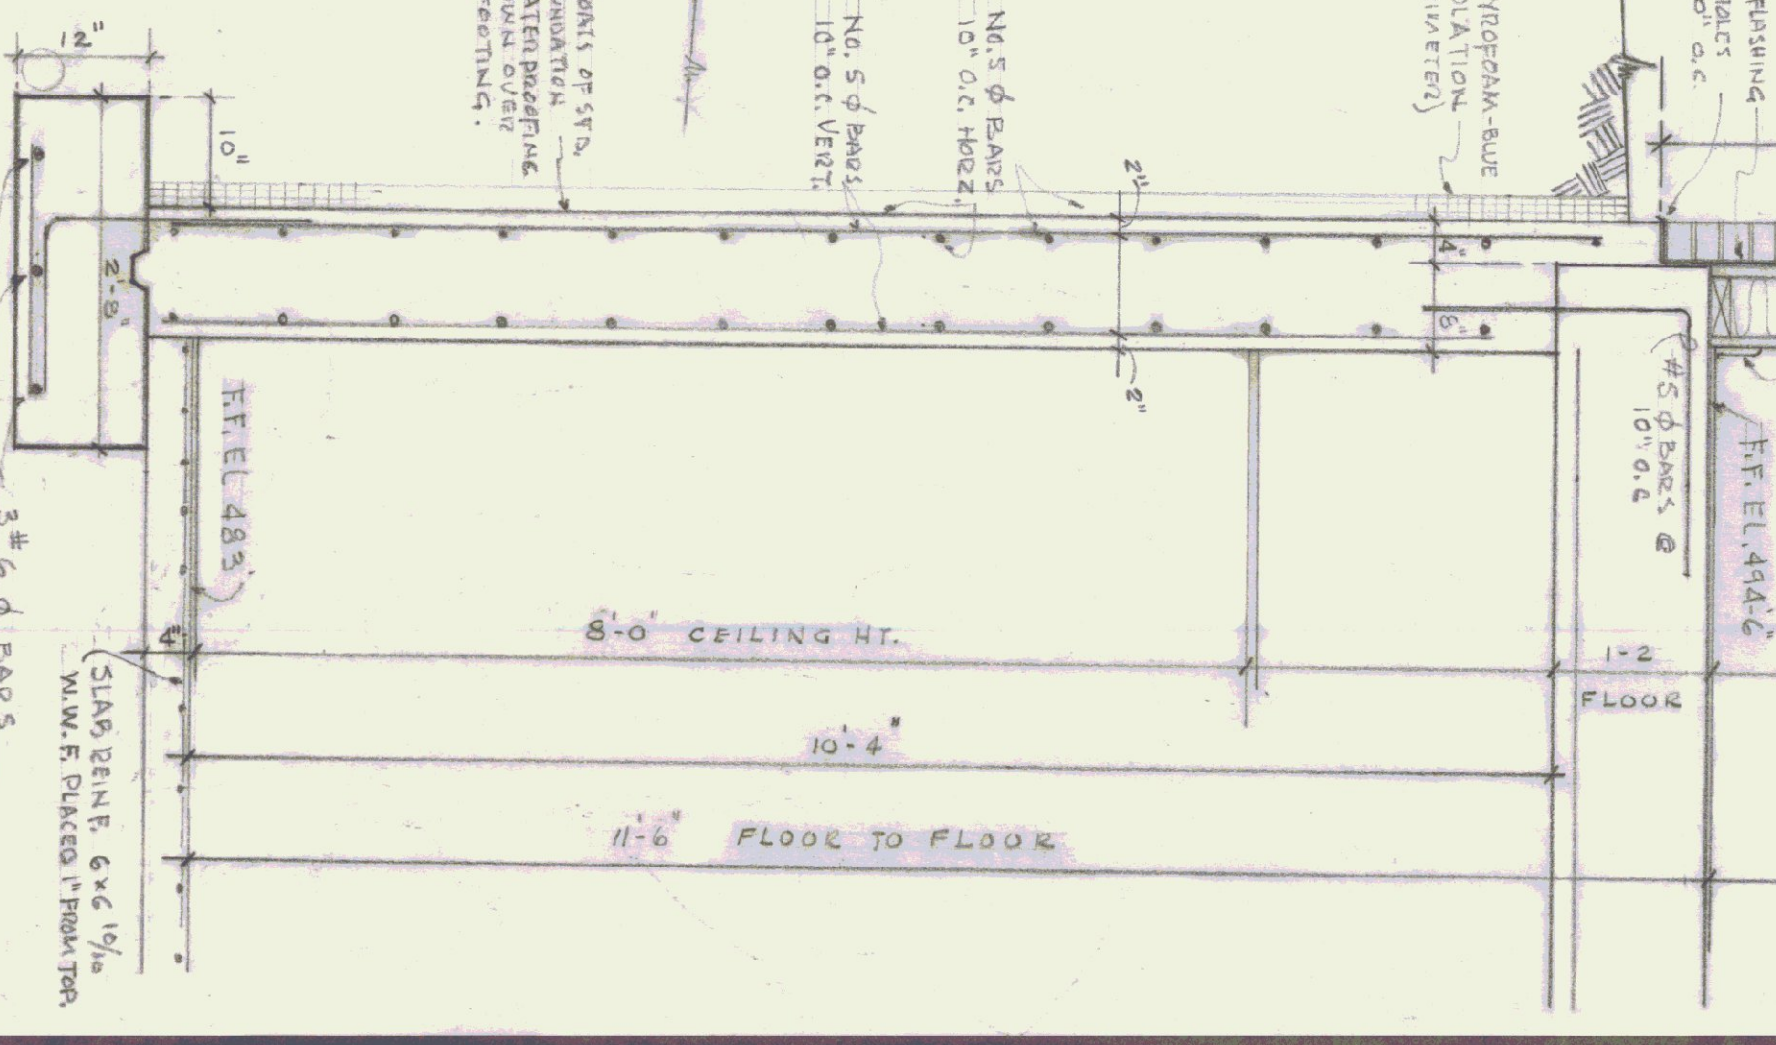


AGENCY OF TRANSPORTATION - NEW OFFICE
STATE OF VERMONT - DEPT OF STATE BUILDINGS
DUMMERSTON VERMONT
GORDON G. WOODS ASSOC. ARCHITECTS, BURLINGTON, VERMONT

DATE	MAR. 23, 1965
SCALE	A5 NOTED
JOB NO.	84208
SHEET	5
DRAWN	ESJ/ldw
CHECKED	

REVISIONS	BY
4-8-65	CONCRETE
	BW

LOWER LEVEL - EMERGENCY OPERATING CENTER - CEILING

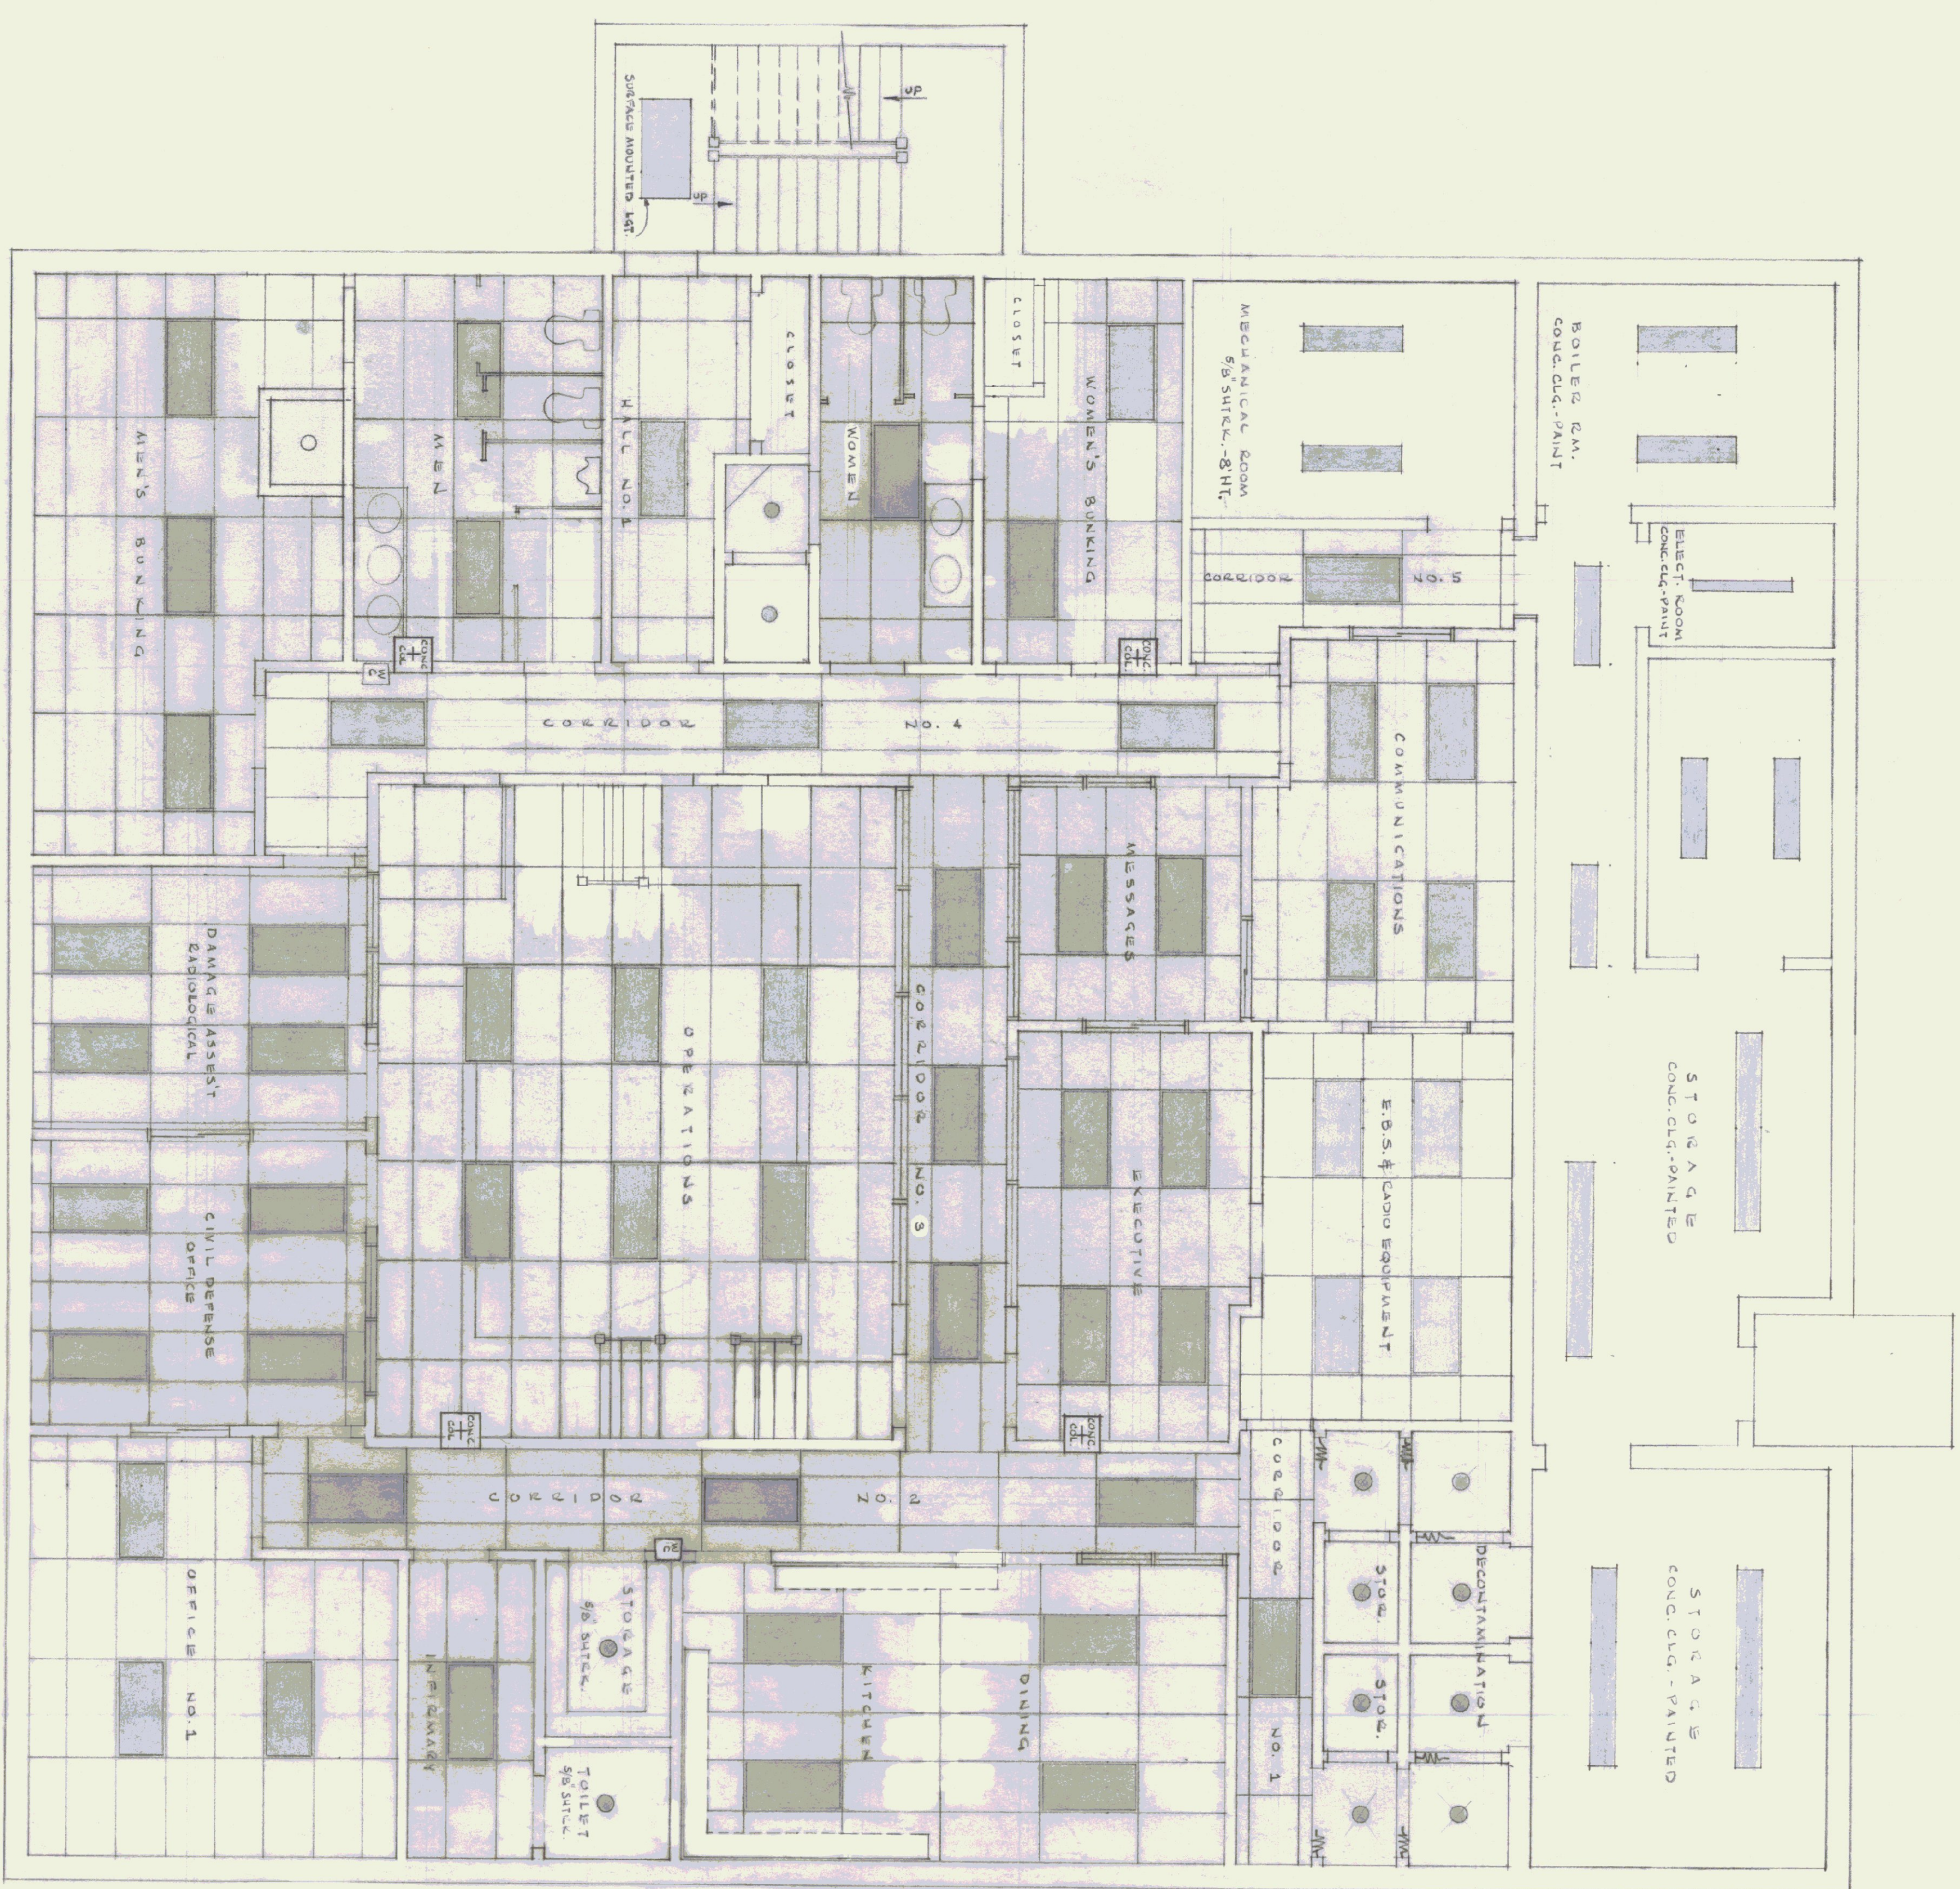

NOTES:
 ALL DIMENSIONS TO BE VERIFIED AT THE SITE BY THE CONTRACTOR. ANY ERROR OR POINTS IN QUESTION MUST BE REFERRED TO THE ARCHITECT FOR A DECISION BEFORE PROCEEDING WITH THE WORK.

CEILING CONTRACTOR SHALL CHECK WITH THE ELECTRICAL LIGHTING PLAN FOR LOCATION OF SUPPORTING MAIN TEES AND FINISH CEILING LAYOUT.

24"x48" ACOUSTICAL TILE SUSPENDED CEILING MINERAL TILES TO BE USED. CEILING HEIGHT 8'-0" IN ALL ROOMS.

CONSTRUCTED ONE HOUR FIRE RATED CEILING SYSTEMS.

ALL LIGHTING FIXTURES SHALL BE SECURELY FASTENED TO THE MAIN TEES OF THE SUSPENDED CEILING SYSTEM. LIGHTING FIXTURES 2' x 4' DECEASED.


CEILING CONTRACTOR SHALL CHECK WITH HEATING CONTRACTOR IN REGARDS TO THE LOCATION OF THE HEATING DIFFUSERS AND DUCT WORK ETC.

REGIONAL EMERGENCY OPERATING CENTER
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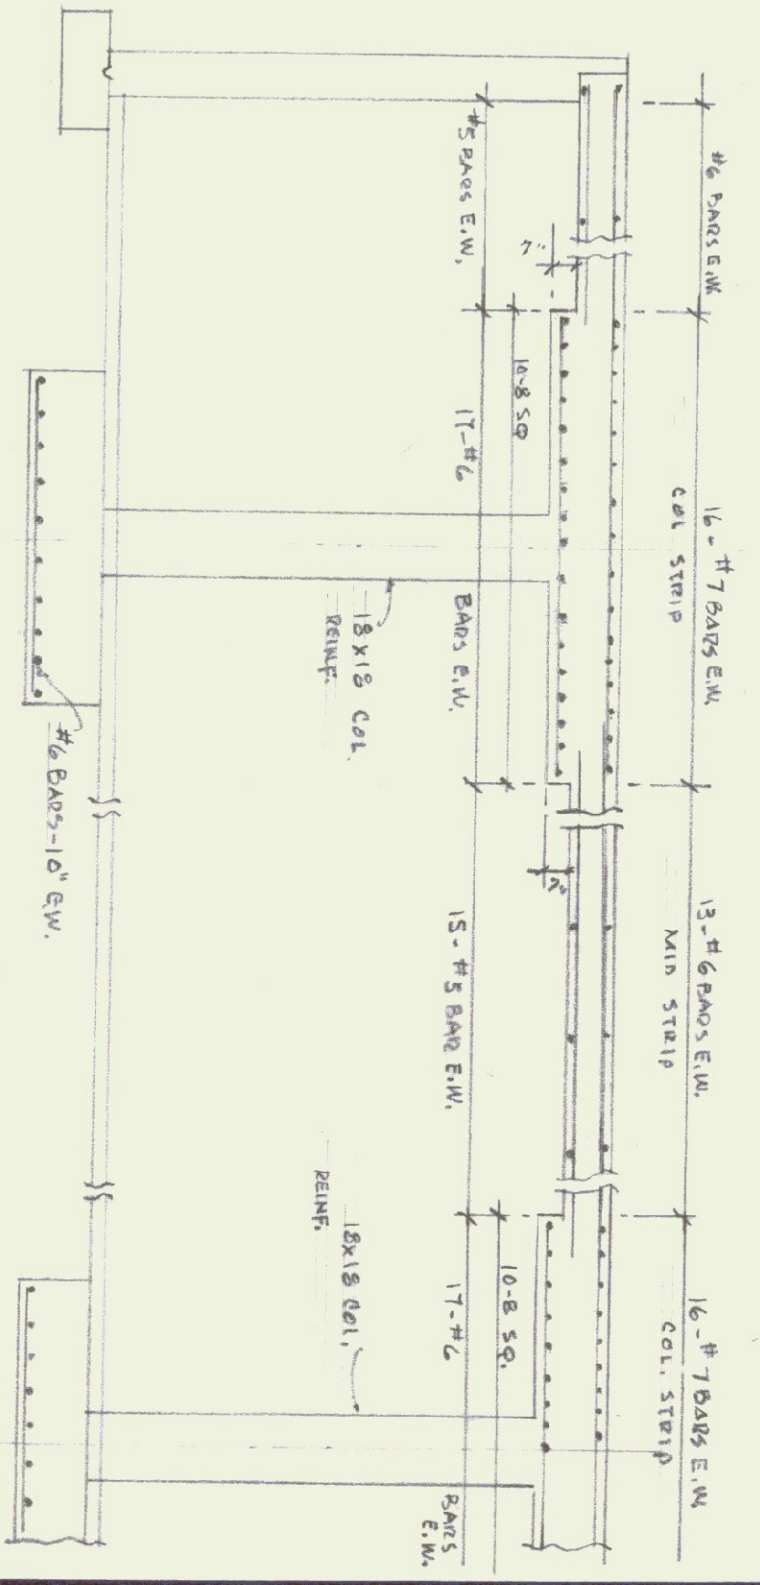
REVISIONS	BY
4-8-83	JGAW

DRAWN JW/SV
CHECKED
DATE MAY 21, 1983
SCALE 1/4" = 1'-0"
JOB NO. 5420
SHEET 6
C1 E.O.C.

FOUNDATION PLAN
SCALE: 1/4" = 1'-0"

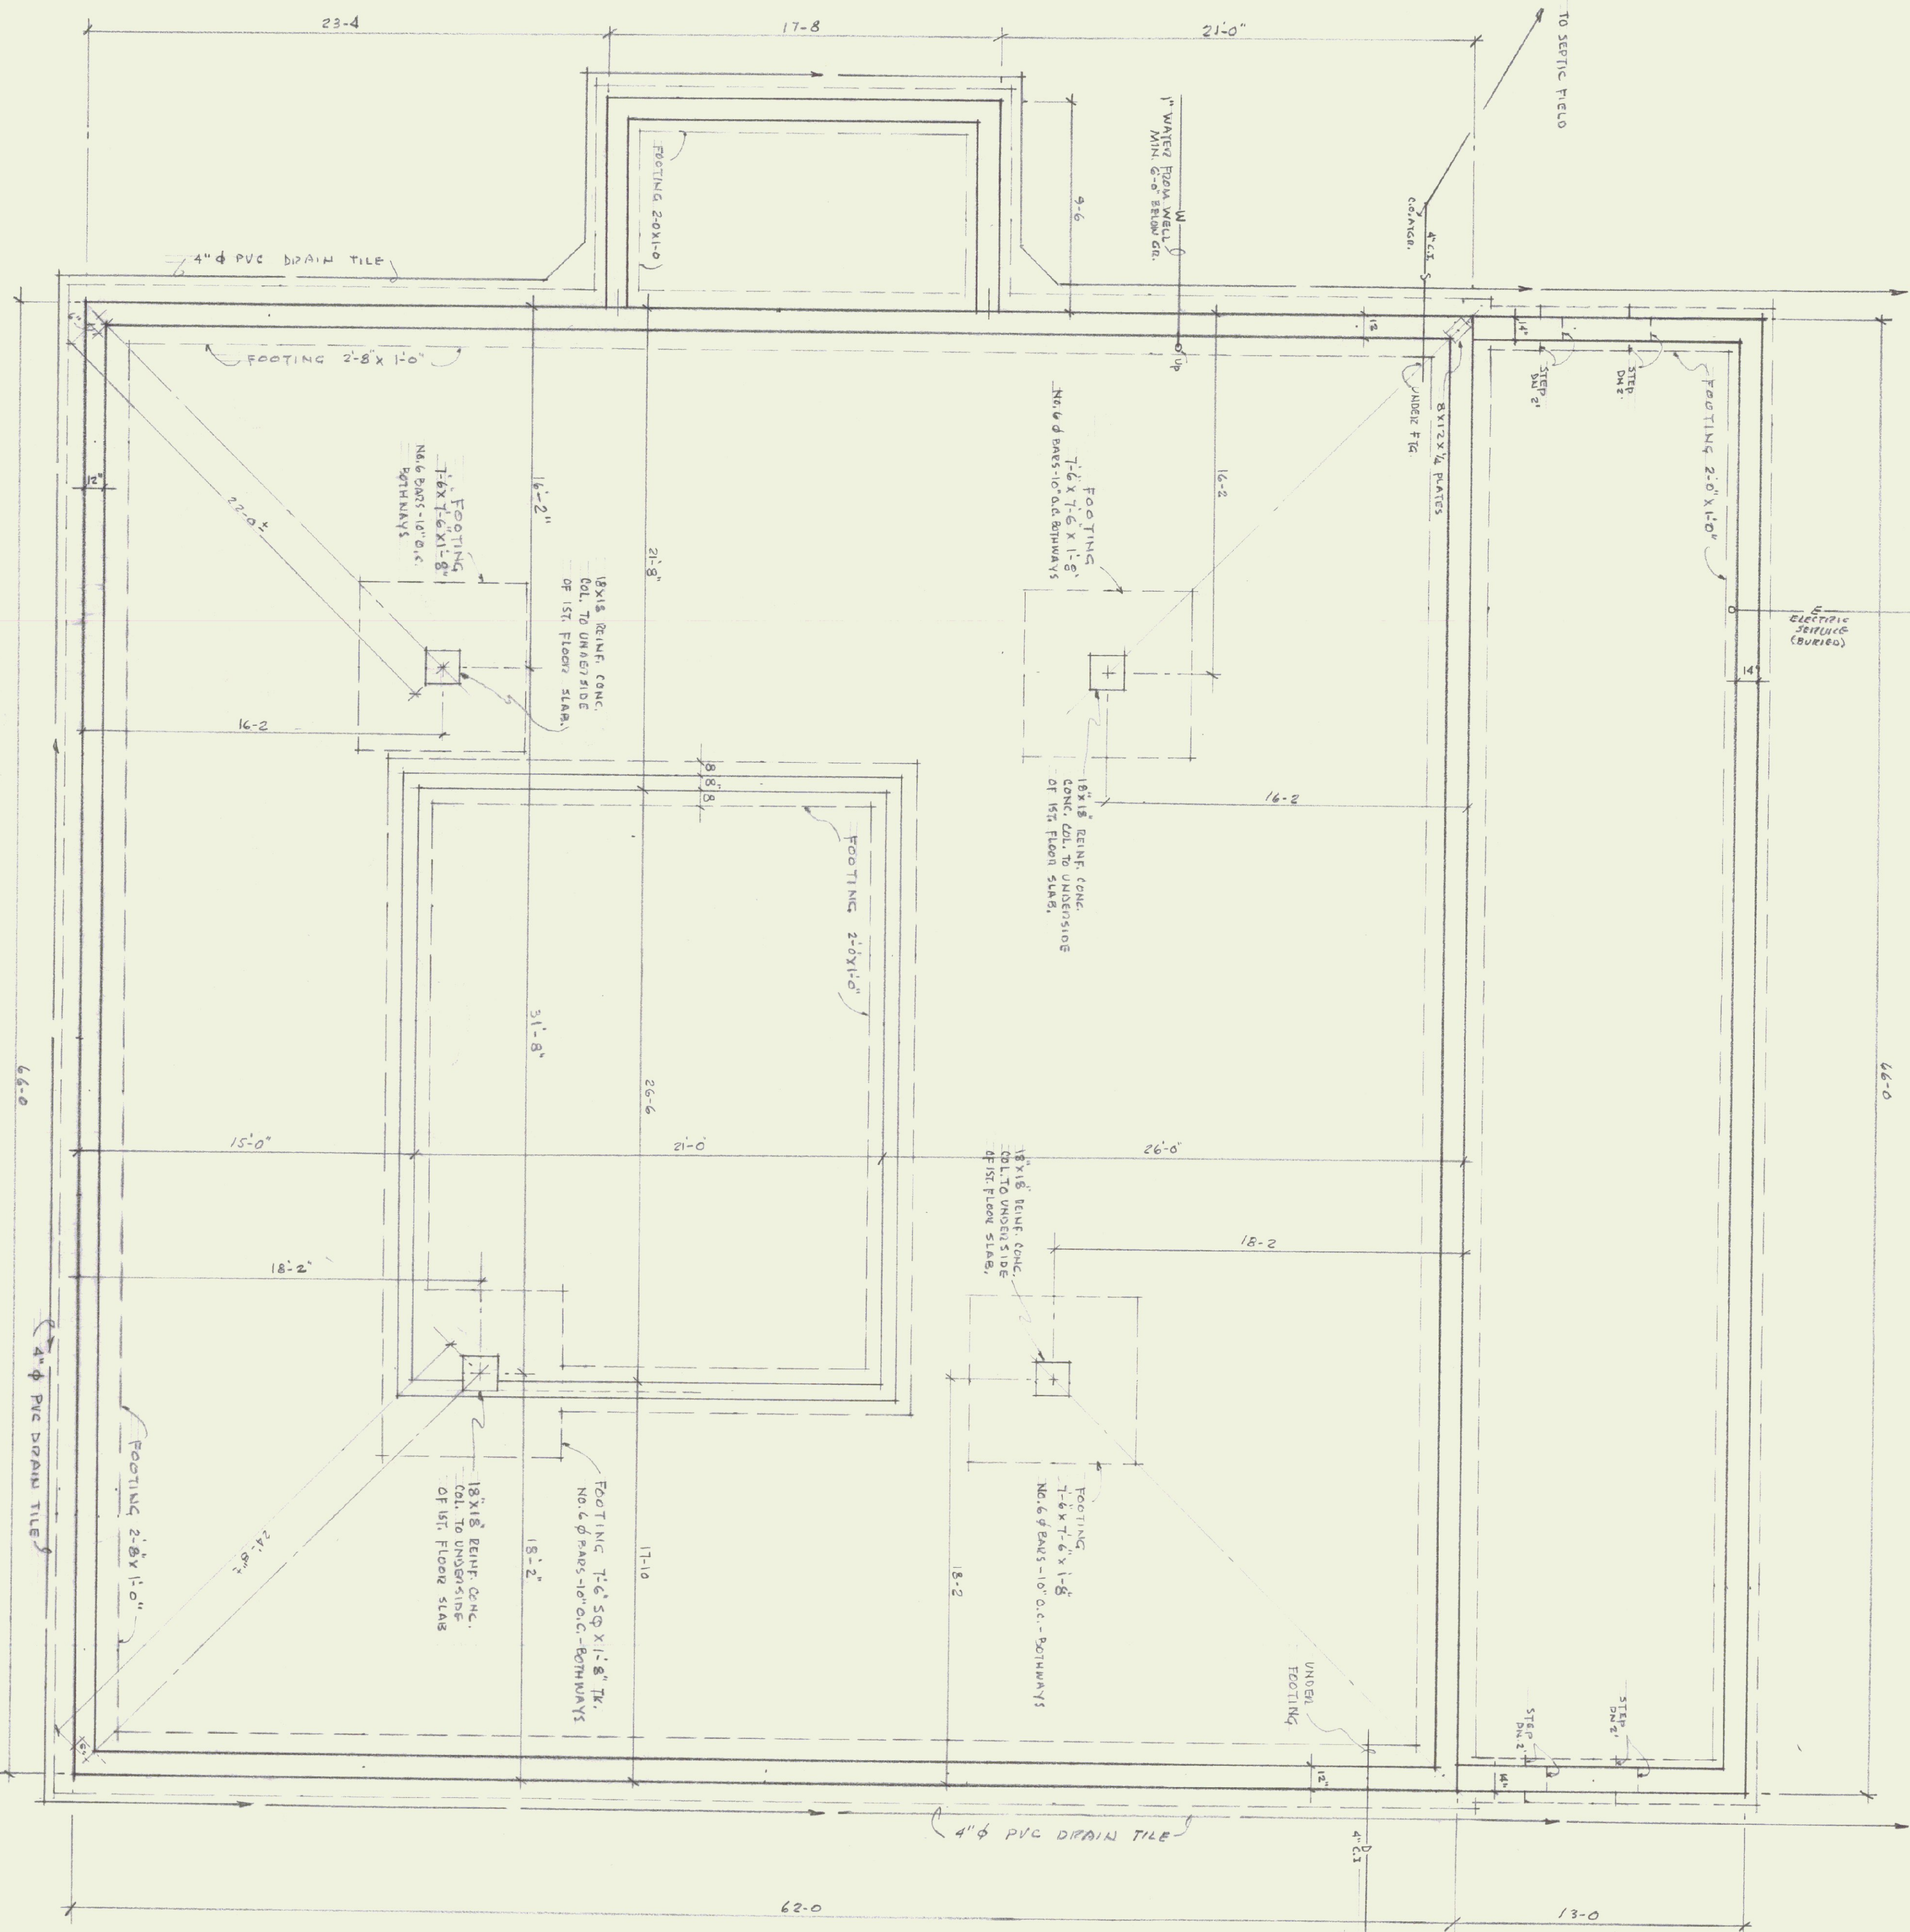

SECTION THRU CONCRETE COLUMN FOOTING AND FLAT CONCRETE SLAB WITH DROP PANEL
SCALE: 1/4" = 1'-0"



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CONCRETE:
FOUNDATION WALLS - 3000 P.S.I.
FOOTINGS - 3000 P.S.I.
LOWER LEVEL SLAB - 3000 P.S.I.
FIRST FLOOR SLAB - 3000 P.S.I.

NOT FINISHED

DATE	MAR. 29, 1985
SCALE	1/4" = 1'-0"
JOB NO.	54-20
SHEET	

AGENCY OF TRANSPORTATION - NEW OFFICE
STATE OF VERMONT-DEPT. OF STATE BUILDINGS
DUMMERSTON, VERMONT
GORDON G. WOODS ASSOC., ARCHITECTS, BURLINGTON, VERMONT

REVISIONS	BY

18A-2438-111



LOWER LEVEL - EMERGENCY OPERATING CENTER - LIGHTING
SCALE: 1/4" = 1'-0"

Add New Walls

31/1/85 Dick Revere Spaulding, B...

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10/10/84
Not finished

DATE	AUG. 15, 1984
DRAWN	BW/JW
CHECKED	
SCALE	1/4" = 1 FOOT
JOB NO.	8420
SHEET	

REGIONAL EMERGENCY OPERATING CENTER
 STATE OF VERMONT - STATE BUILDINGS DEPT.
 CIVIL DEFENSE DIV. DUMMERSTON, VERMONT
 GORDON G. WOODS ASSOC., ARCHITECTS, BURLINGTON, VERMONT

REVISIONS	BY