



SECTION 3
SCALE: 1 1/2" = 1'-0"

USE THIS DETAIL FOR PIPE PENETRATIONS AT STEEL BEAMS. PROVIDE LAYOUT OF PIPING AND DETAILS OF PENETRATIONS FOR REVIEW.

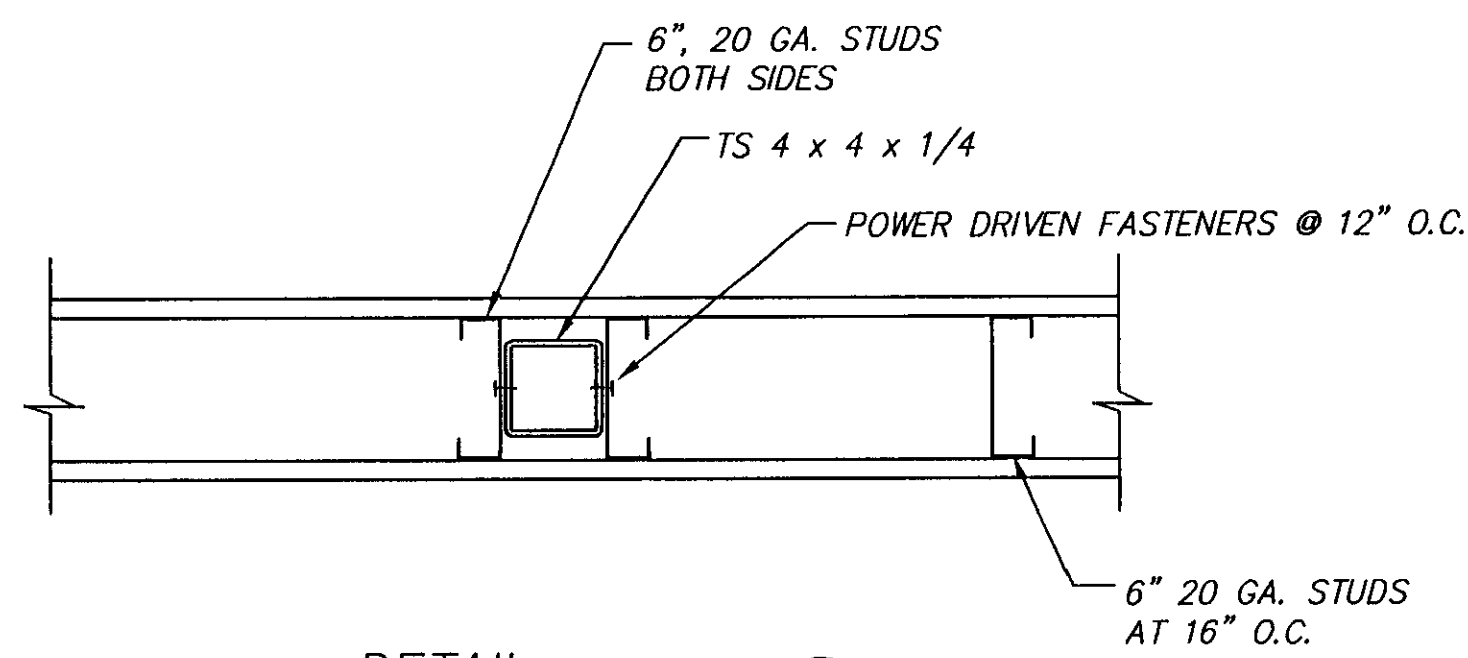


DETAIL 2
SCALE: 1 1/2" = 1'-0"

USE THIS DETAIL AT ALL COLUMNS IN STUD WALLS.

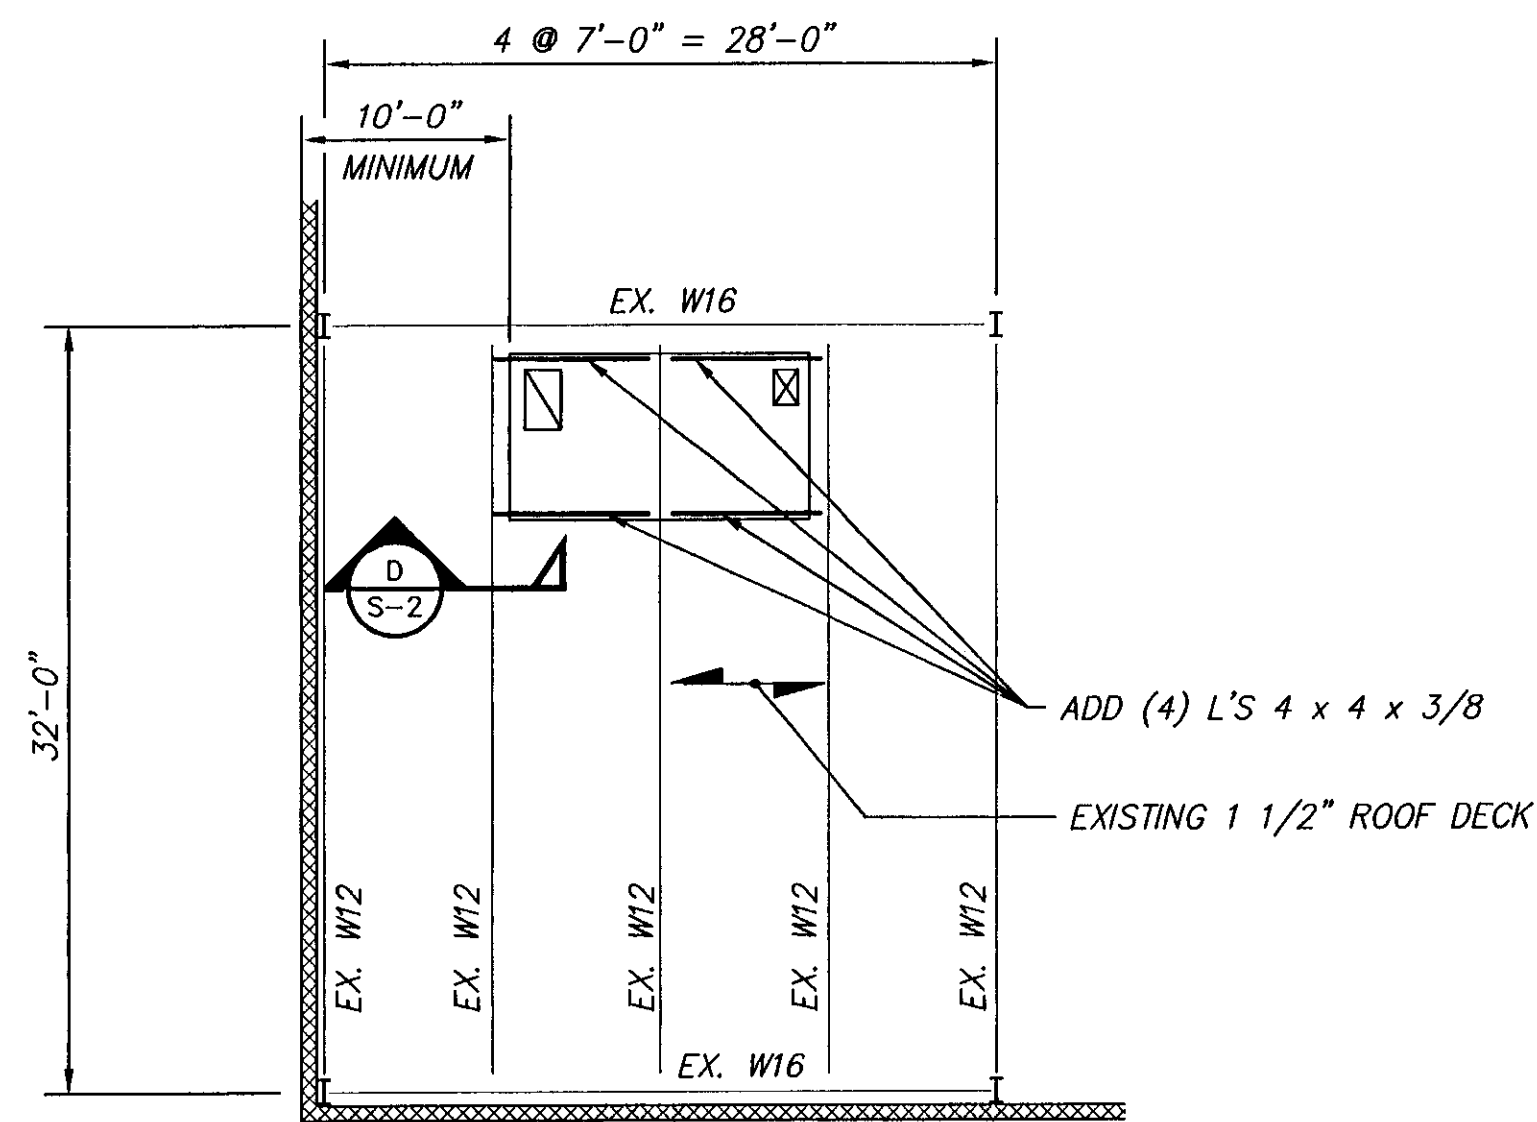


PARTIAL ROOF FRAMING PLAN
SCALE: 1/8" = 1'-0"

ADD ALTERNATE NO. 2

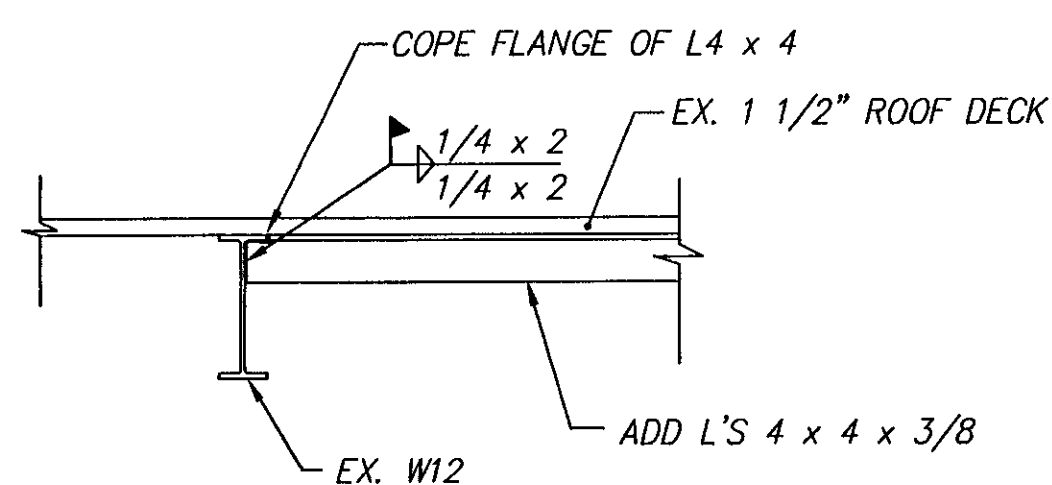


SECTION D
SCALE: 3/4" = 1'-0"

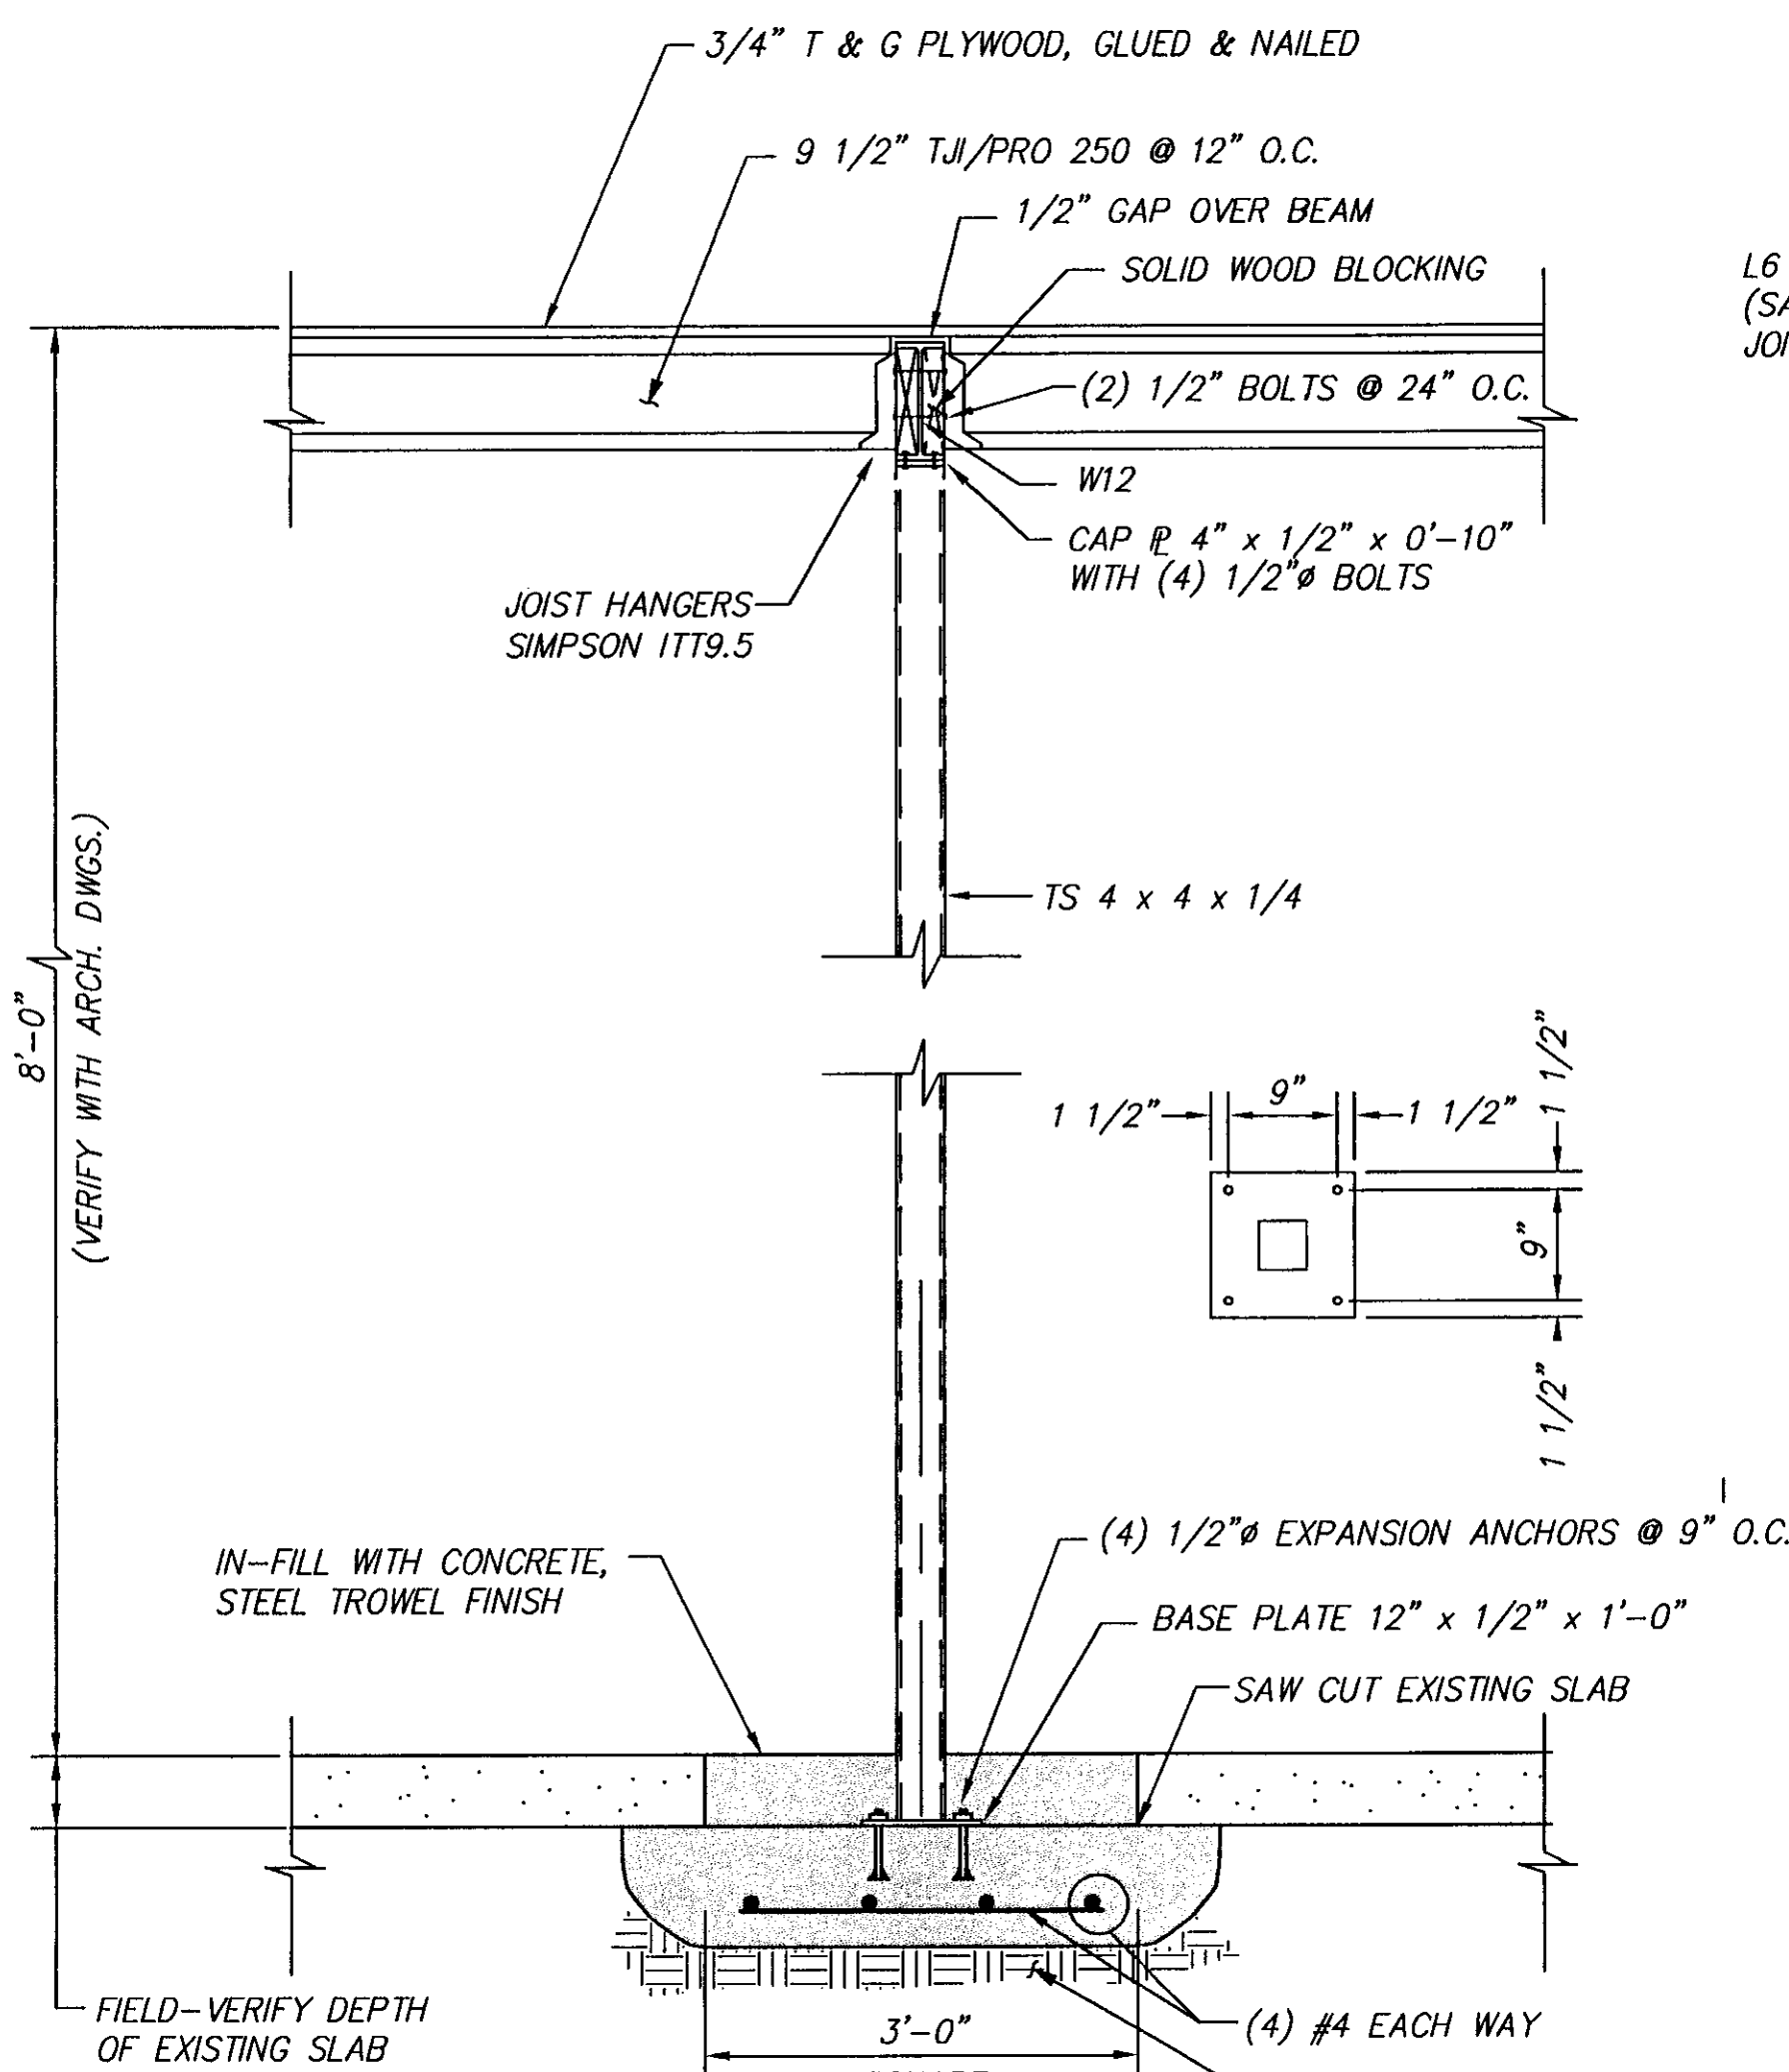


SECTION C
SCALE: 3/4" = 1'-0"

NOTE: COMPACT SUBGRADE PRIOR TO PLACING REINFORCING. TYPICAL ALL FOOTINGS.

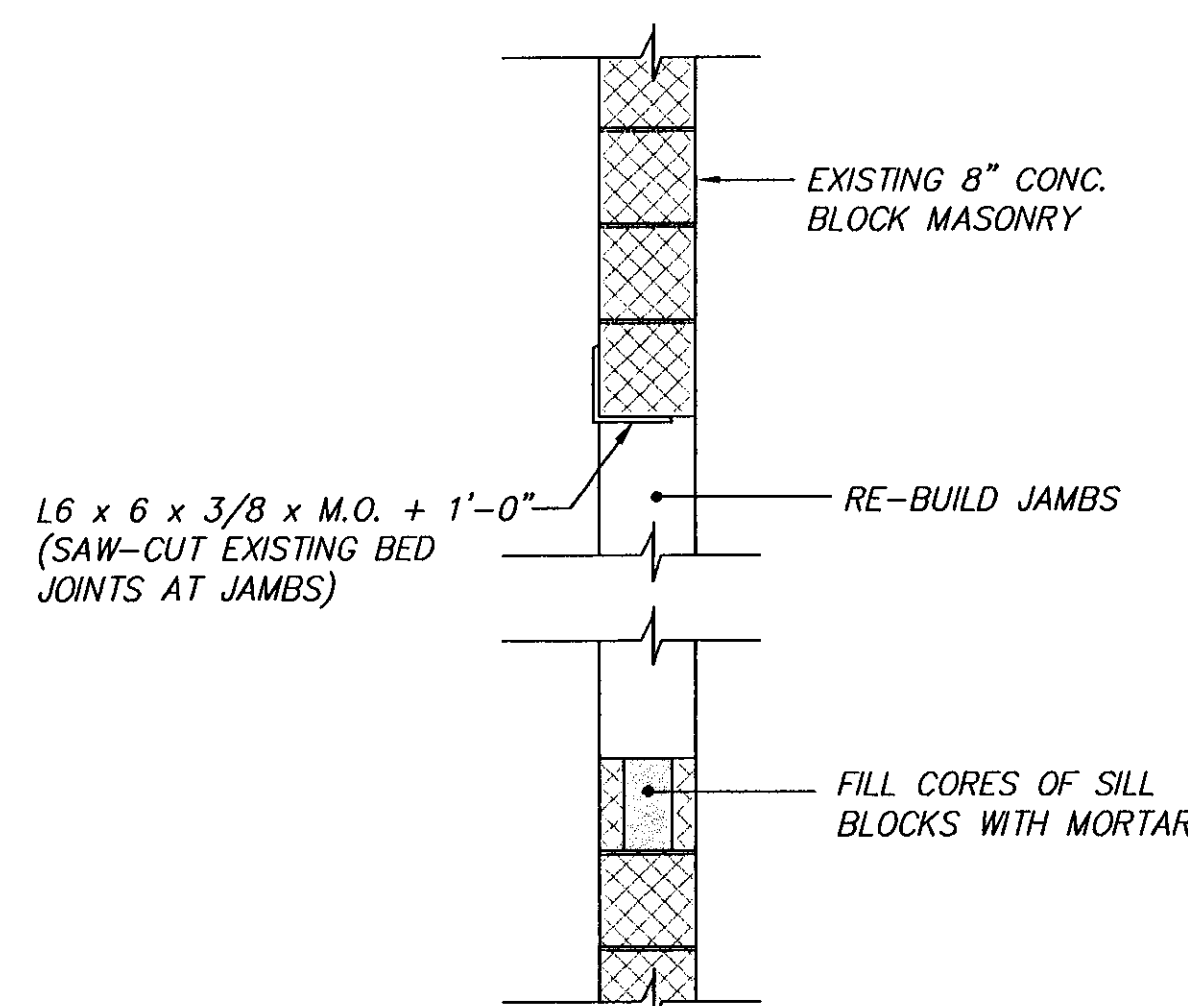


SECTION B
SCALE: 1 1/2" = 1'-0"

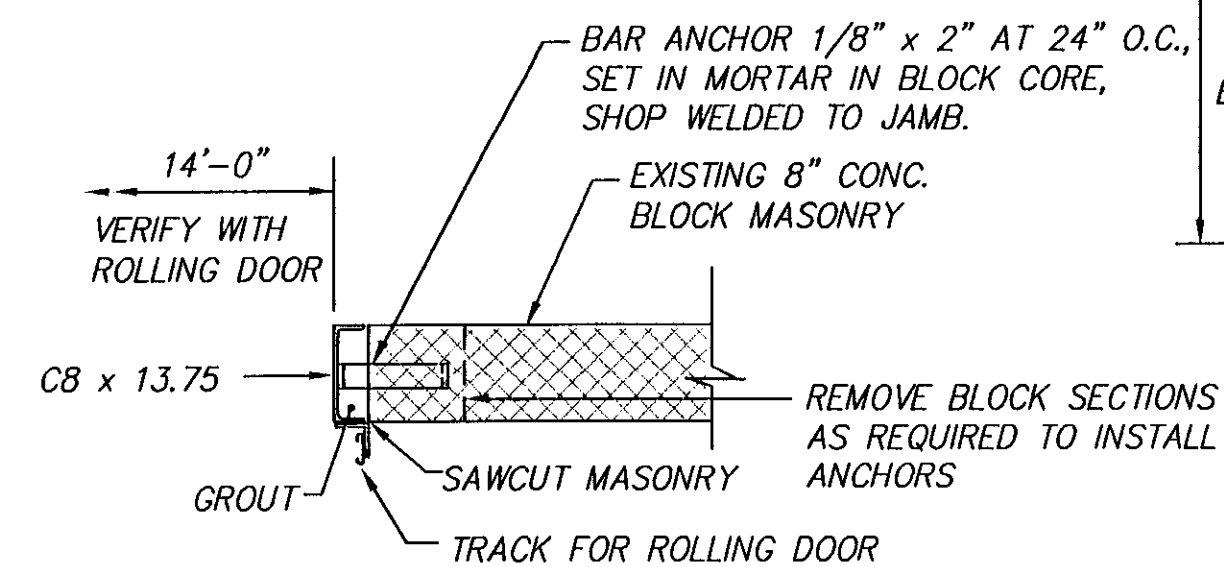


DETAIL 1
SCALE: 3/4" = 1'-0"

USE THIS DETAIL AT 4 JAMBS AT OVERHEAD DOORS

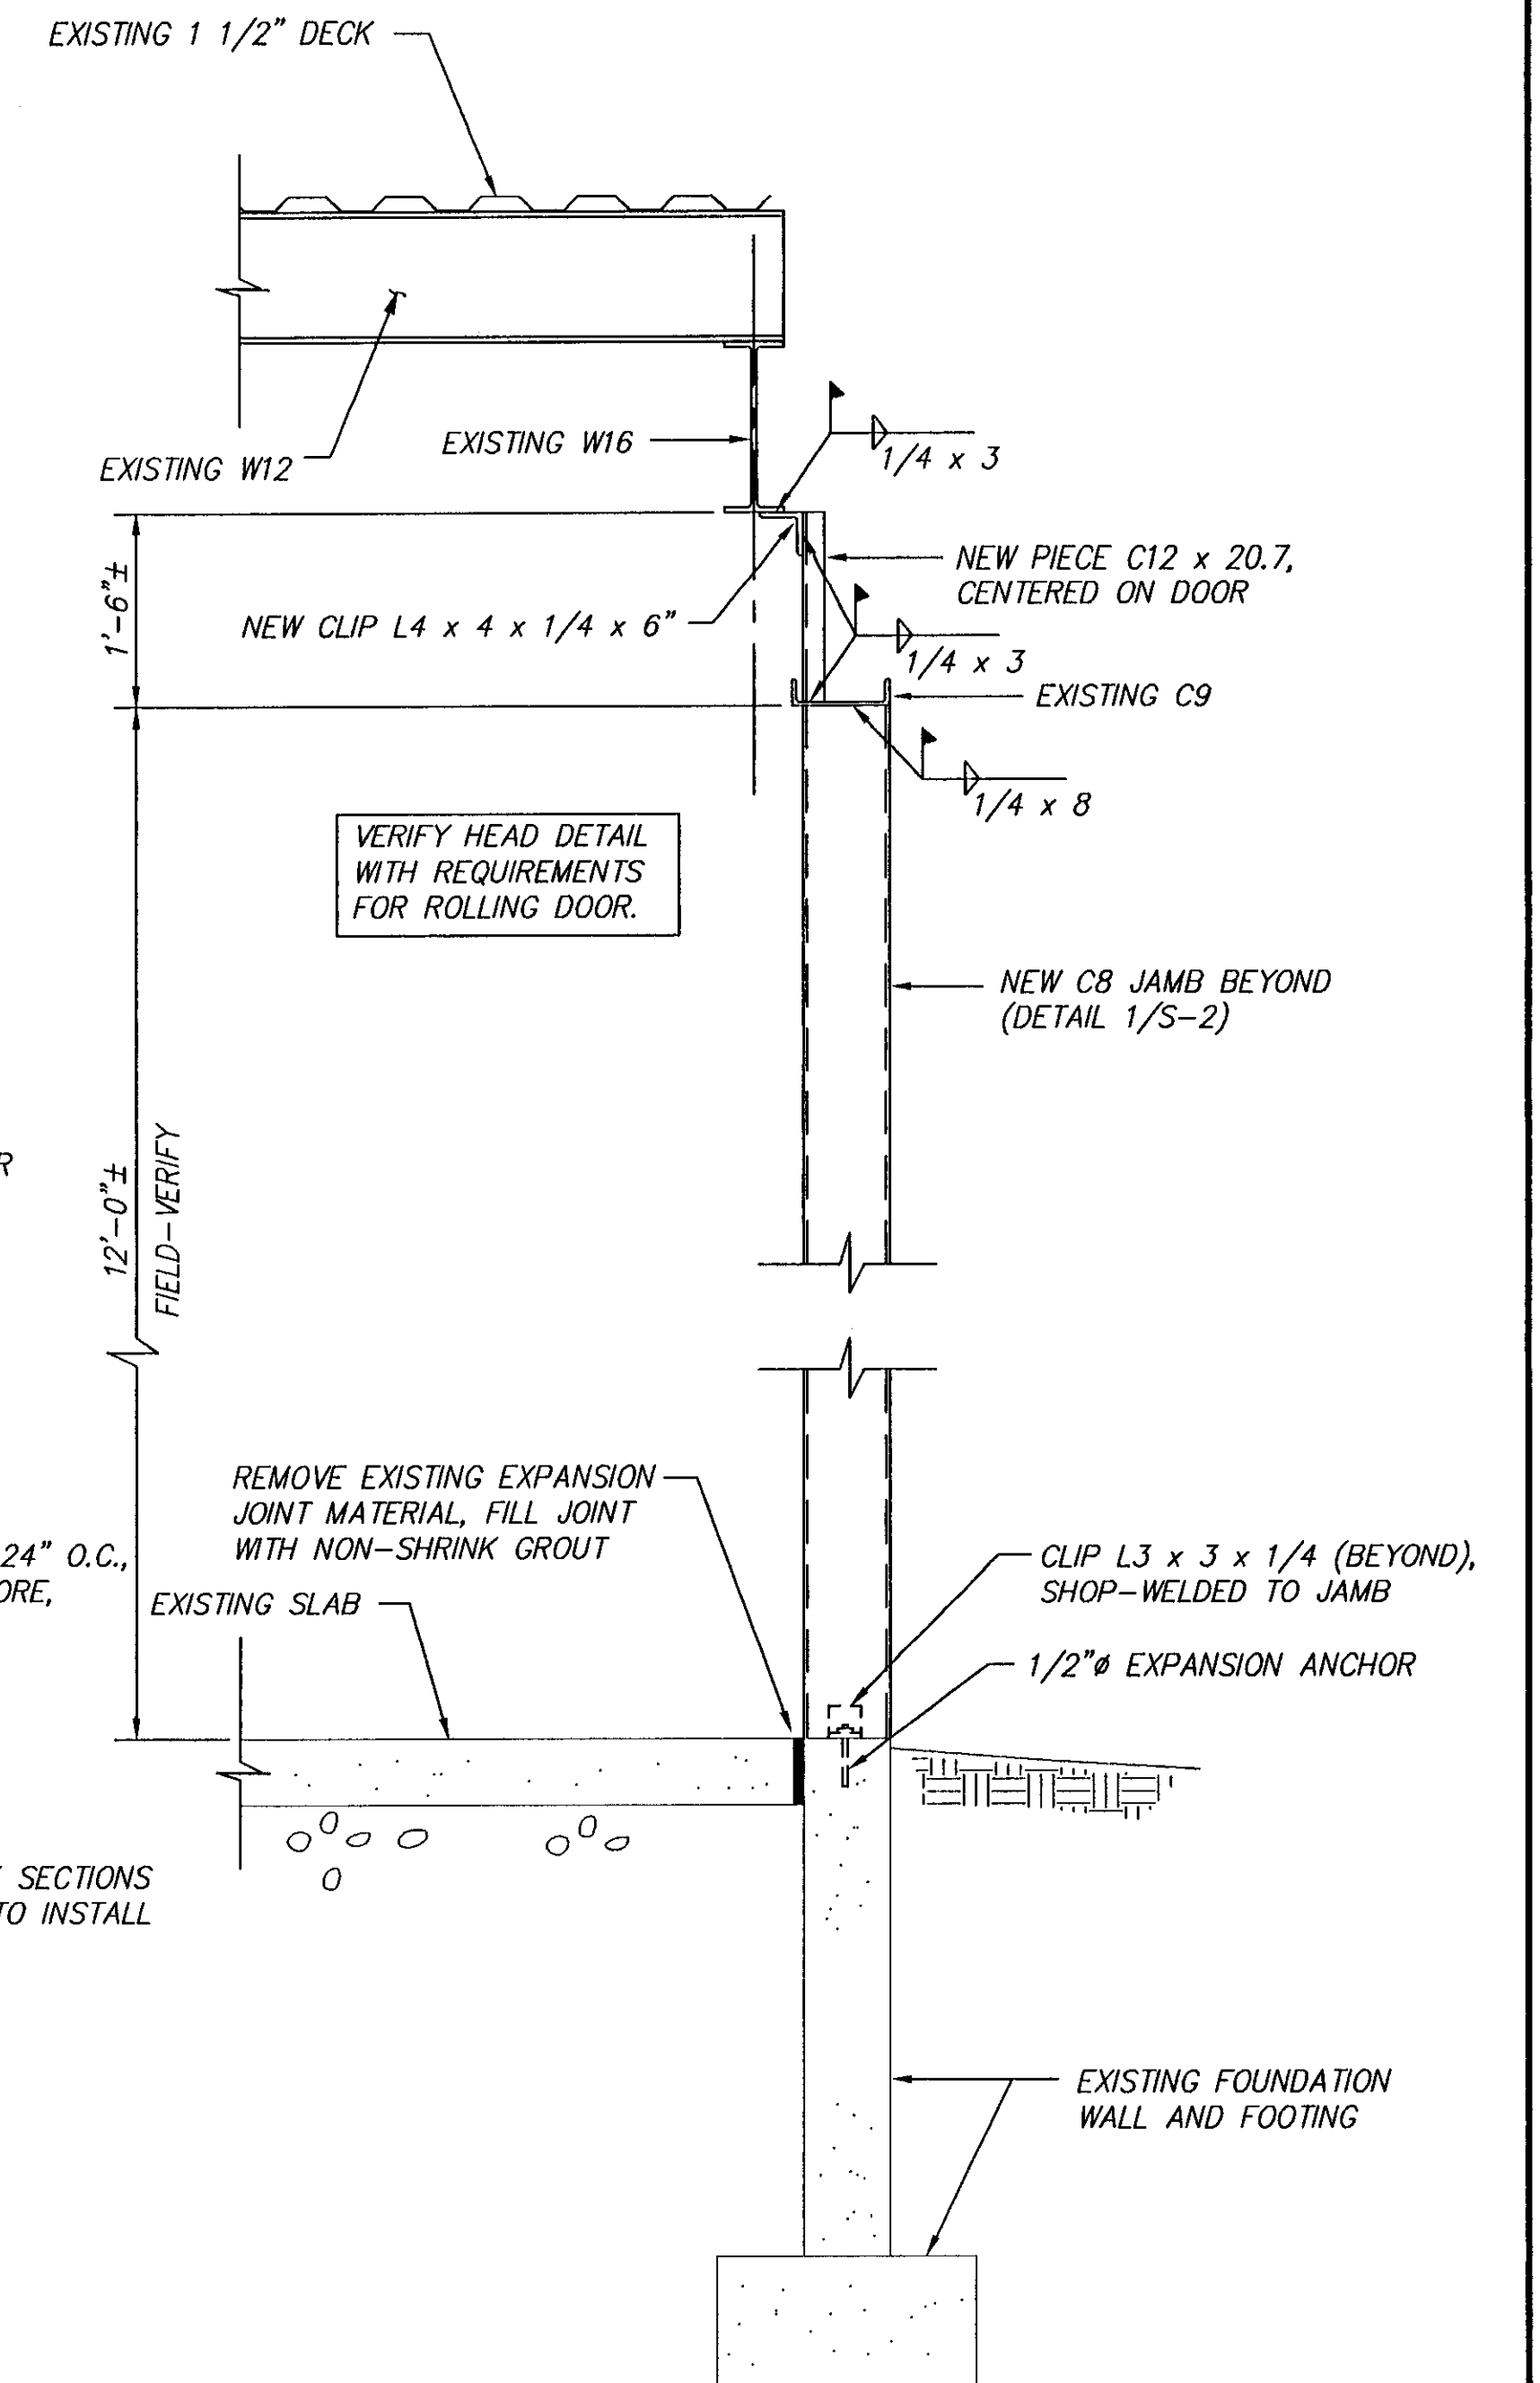

SECTION A
SCALE: 3/4" = 1'-0"

Date	Revision	Date	Revision

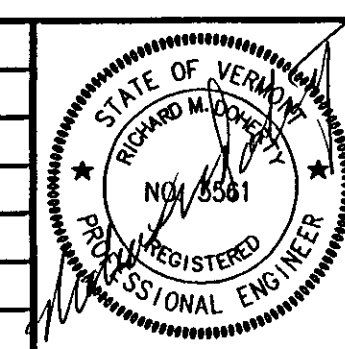

RICHARD M. DOHERTY, P.E.
STRUCTURAL ENGINEERING
117 ST. PAUL ST. • BURLINGTON, VT • 05401
802 • 680 • 8212

Date: 11/9/2004
Scale: AS NOTED
Drawn By: LRB
Checked By: RMD
Project No.: 2377

STRUCTURAL SECTIONS AND DETAILS
BENNINGTON AOT
BENNINGTON, VERMONT

Sheet Number
S-2