


HEATING PLAN
(5 BAY)

SCALE: 1/2" = 1'-0"

DETAIL OF END OF MAIN (GARAGE OFFICE)

SCALE: 1" = 1'-0"

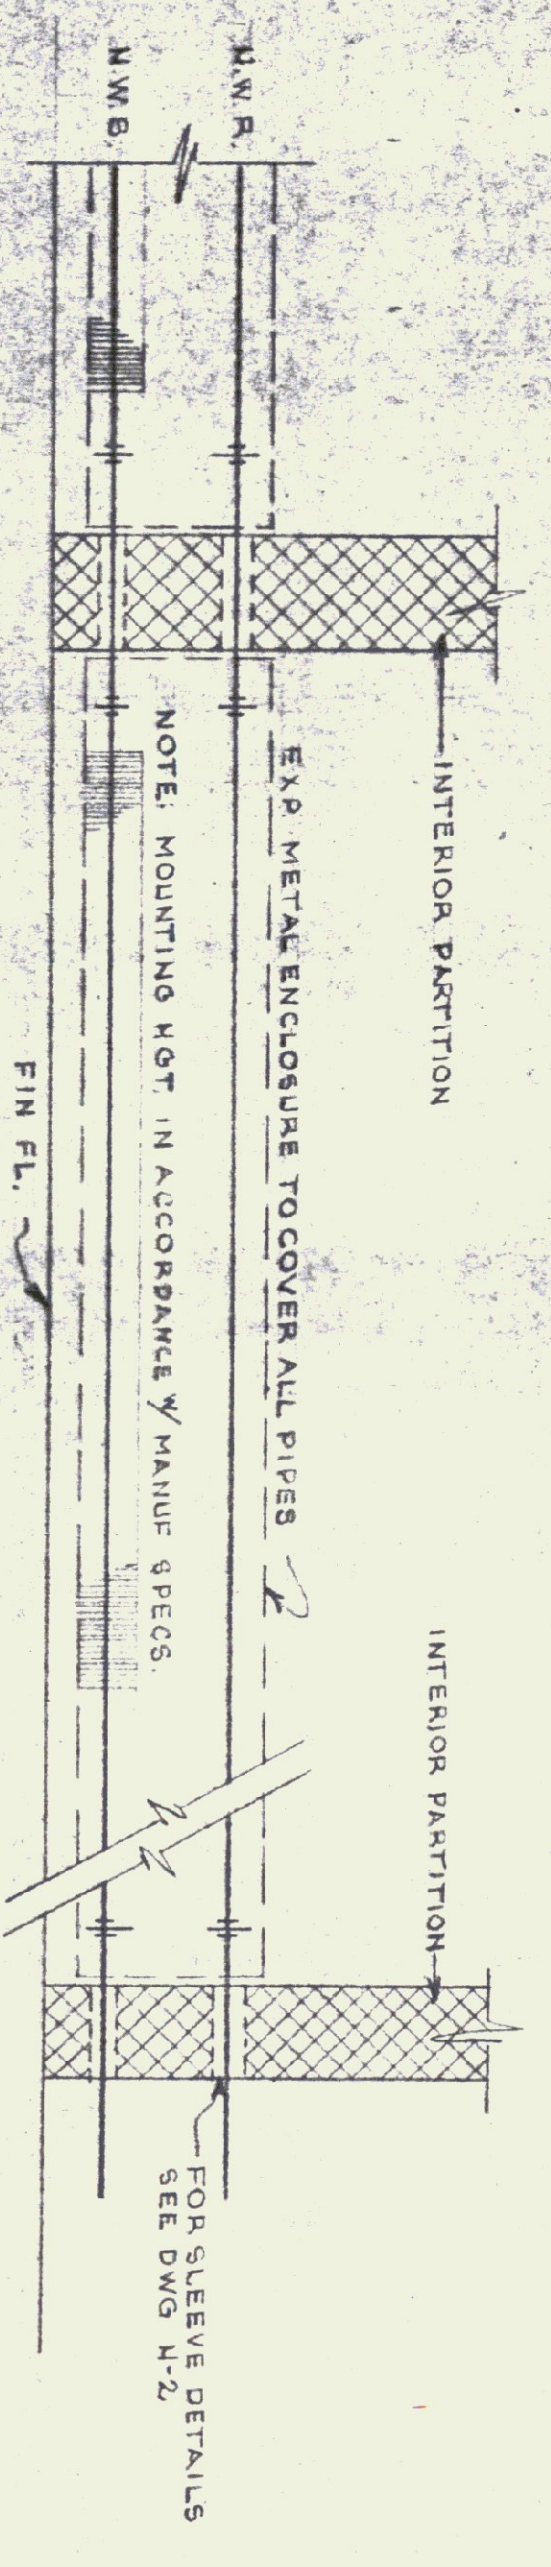


TYPICAL BASEBOARD RADIATION PIPING

SCALE: 1" = 1'-0"


TYPICAL SECTION

SCALE: 1 1/2" = 1'-0"

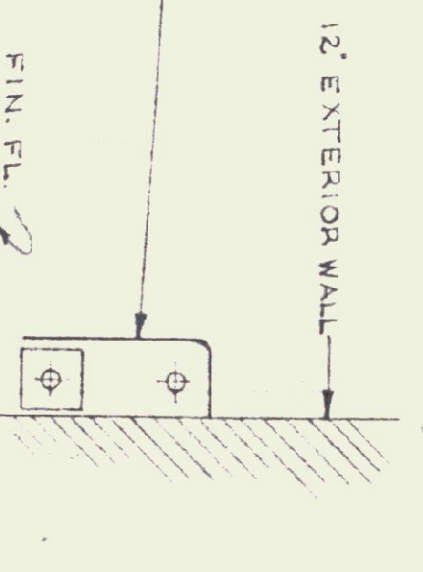


PLUMBING ISOMETRIC DIAGRAM

SCALE: AS SHOWN

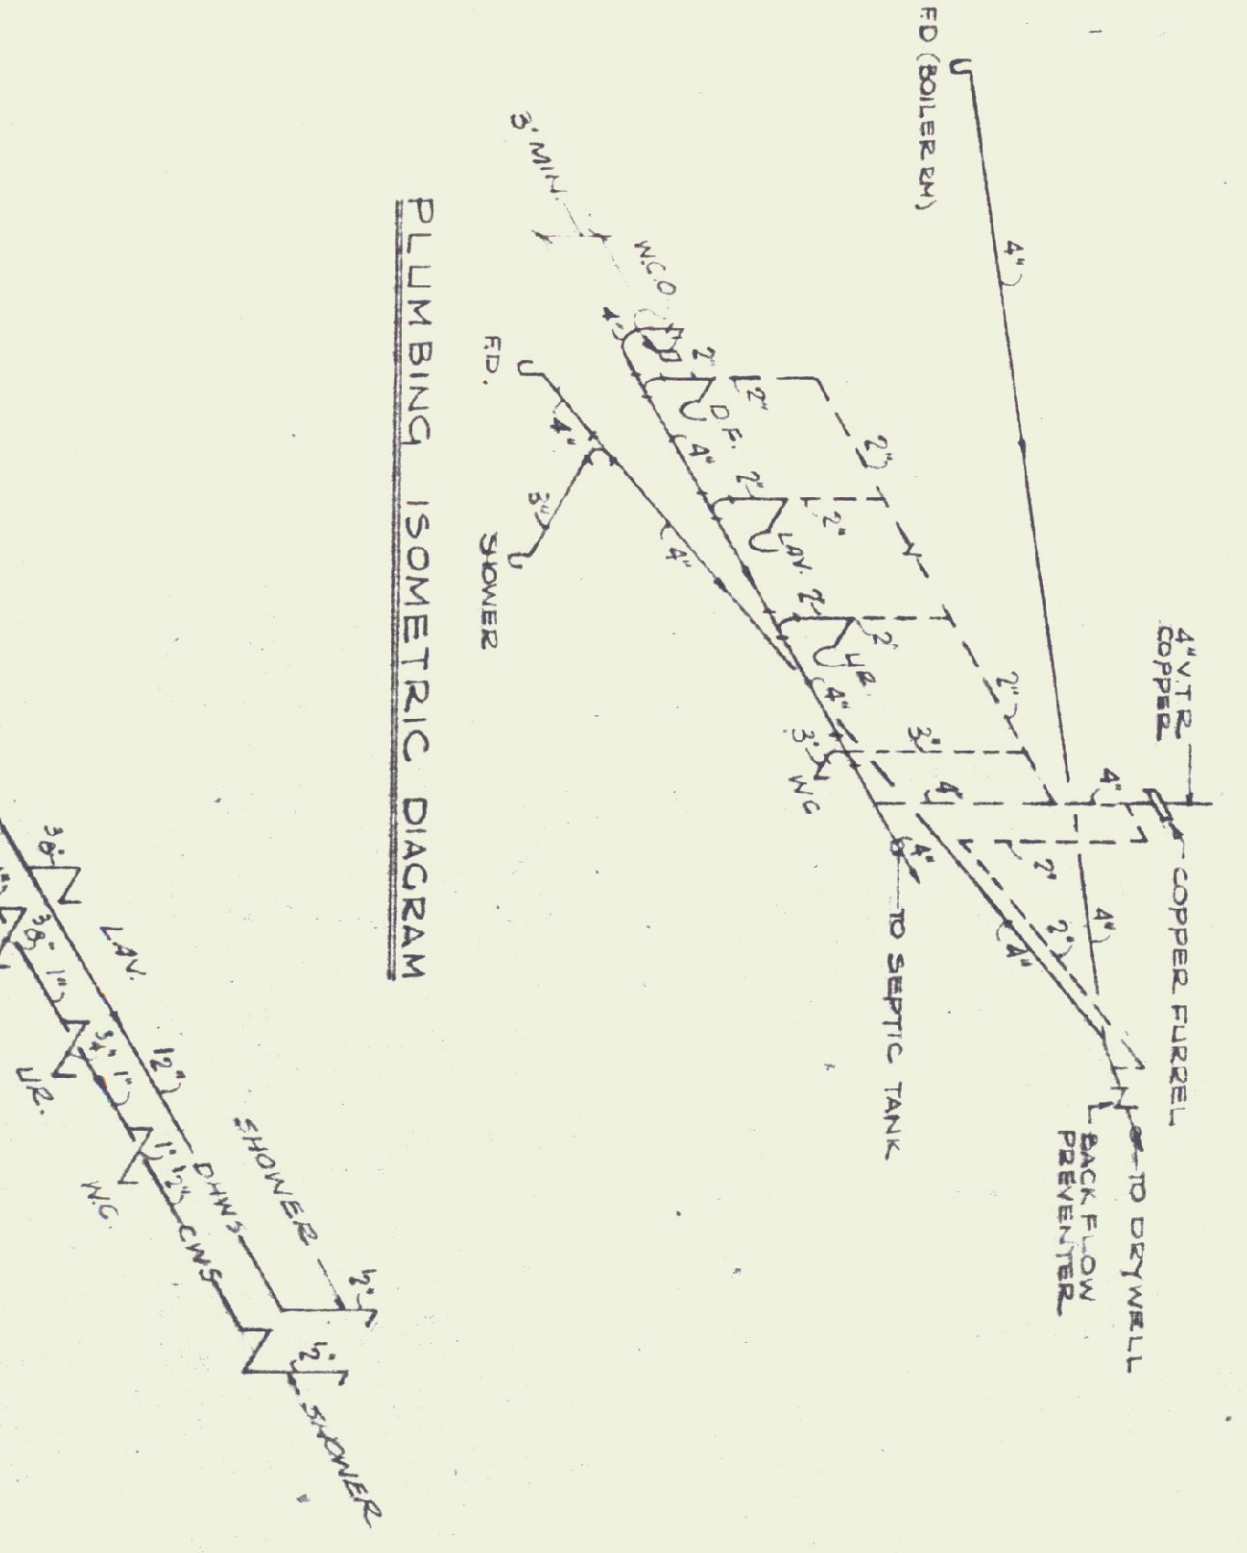

PLUMBING PLAN

SCALE: 1/4" = 1'-0"

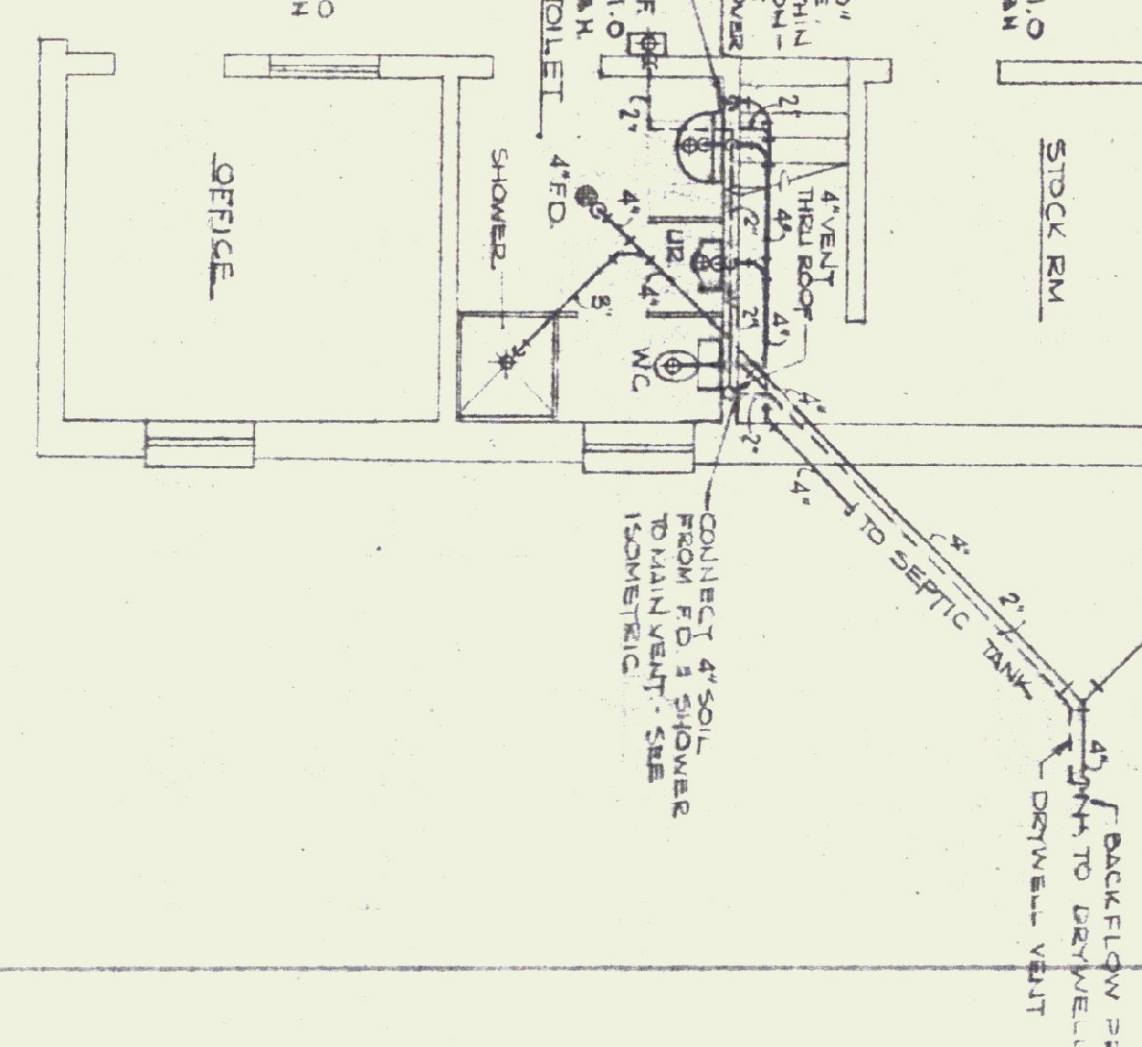

SEE DRAWING H-2 FOR SCHEDULE & GENERAL NOTES

LEGEND

- H.W.S. ———
- H.W.R. ———
- ⊕ — BURNER SAFETY SWITCH (TO GAS VALVE RIG)
- ⊕ — T. STAT.
- — — — — PIPE SUPPLY TO BOTTOM & RETURN TO TOP
- ⊕ — GATE VALVE
- ⊕ — CHECK VALVE
- ⊕ — BALANCING COCK
- ⊕ — FLOW CONTROL VALVE
- ⊕ — UNISU
- ⊕ — FULFILLER LEVER MATIC VALVE
- ⊕ — STAIRCASE
- ⊕ — PRV - ALL BRONZE

DATE:	DESIGNED BY:	DWG. NO.
10-18-74	C.J.S. MASTRO	H-1
DRAWN BY:	APPROVED BY:	1 OF 2
STUDIO EREN M.K.	[Signature]	

STATE OF VERMONT
DIVISION OF STATE BUILDINGS
AGENCY OF ADMINISTRATION
MONTPELIER, VERMONT

Standard Five Bay Highway Garage Bldg.
HEATING PLAN
SCALE: AS SHOWN