


ONVIA HANGAR (EM STN 100)
EXISTING PUMP STATION (SEE W-1-0153-1)

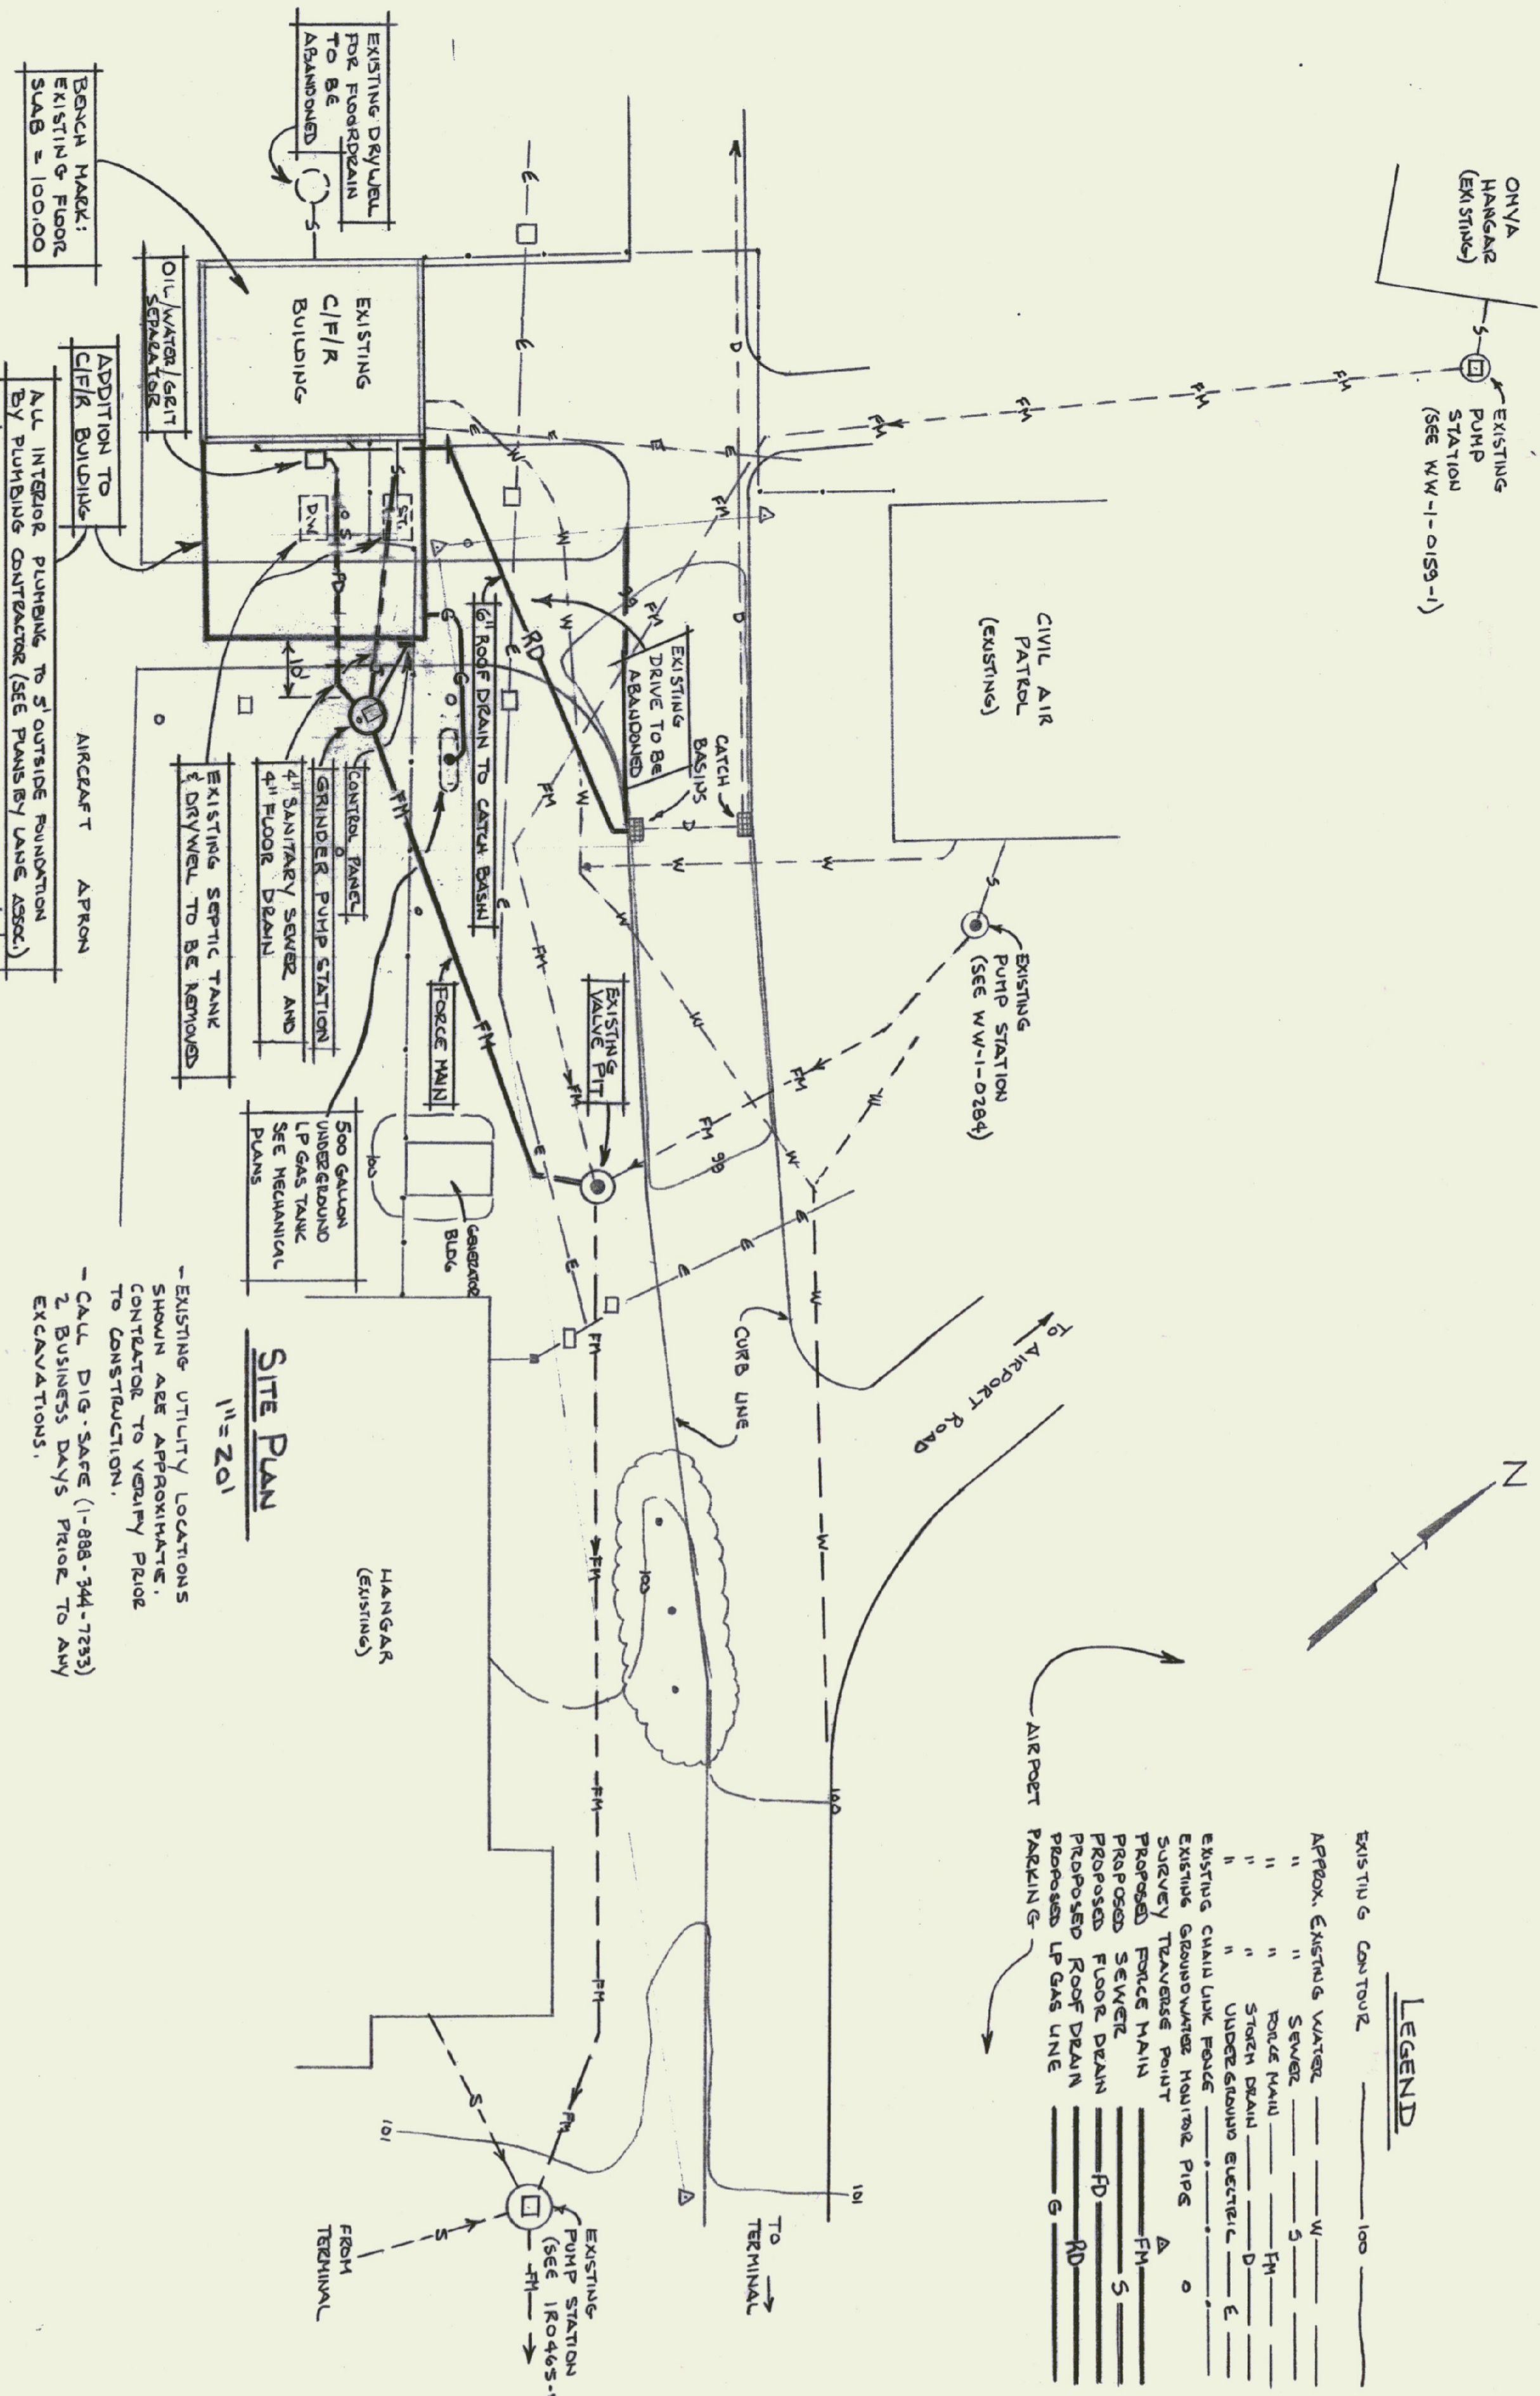





SITE PLAN
1" = 20'

EXISTING UTILITY LOCATIONS SHOWN ARE APPROXIMATE. CONTRACTOR TO VERIFY PRIOR TO CONSTRUCTION.

CALL DIG-SAFE (1-888-344-7293) 2 BUSINESS DAYS PRIOR TO ANY EXCAVATIONS.

LEGEND

EXISTING CONTOUR	---
APPROX. EXISTING WATER	---
" " " " " " " "	---
" " " " " " " "	---
" " " " " " " "	---
EXISTING CUIVILINK POWER	---
EXISTING TRANSMISSION HOUSING PIPES	---
PROPOSED TRANSMISSION HOUSING PIPES	---
PROPOSED SEWER MAIN	---
PROPOSED FORCE MAIN	---
PROPOSED FLOOR DRAIN	---
PROPOSED ROOF DRAIN	---
PROPOSED LP GAS LINE	---
PROPOSED PACKING	---

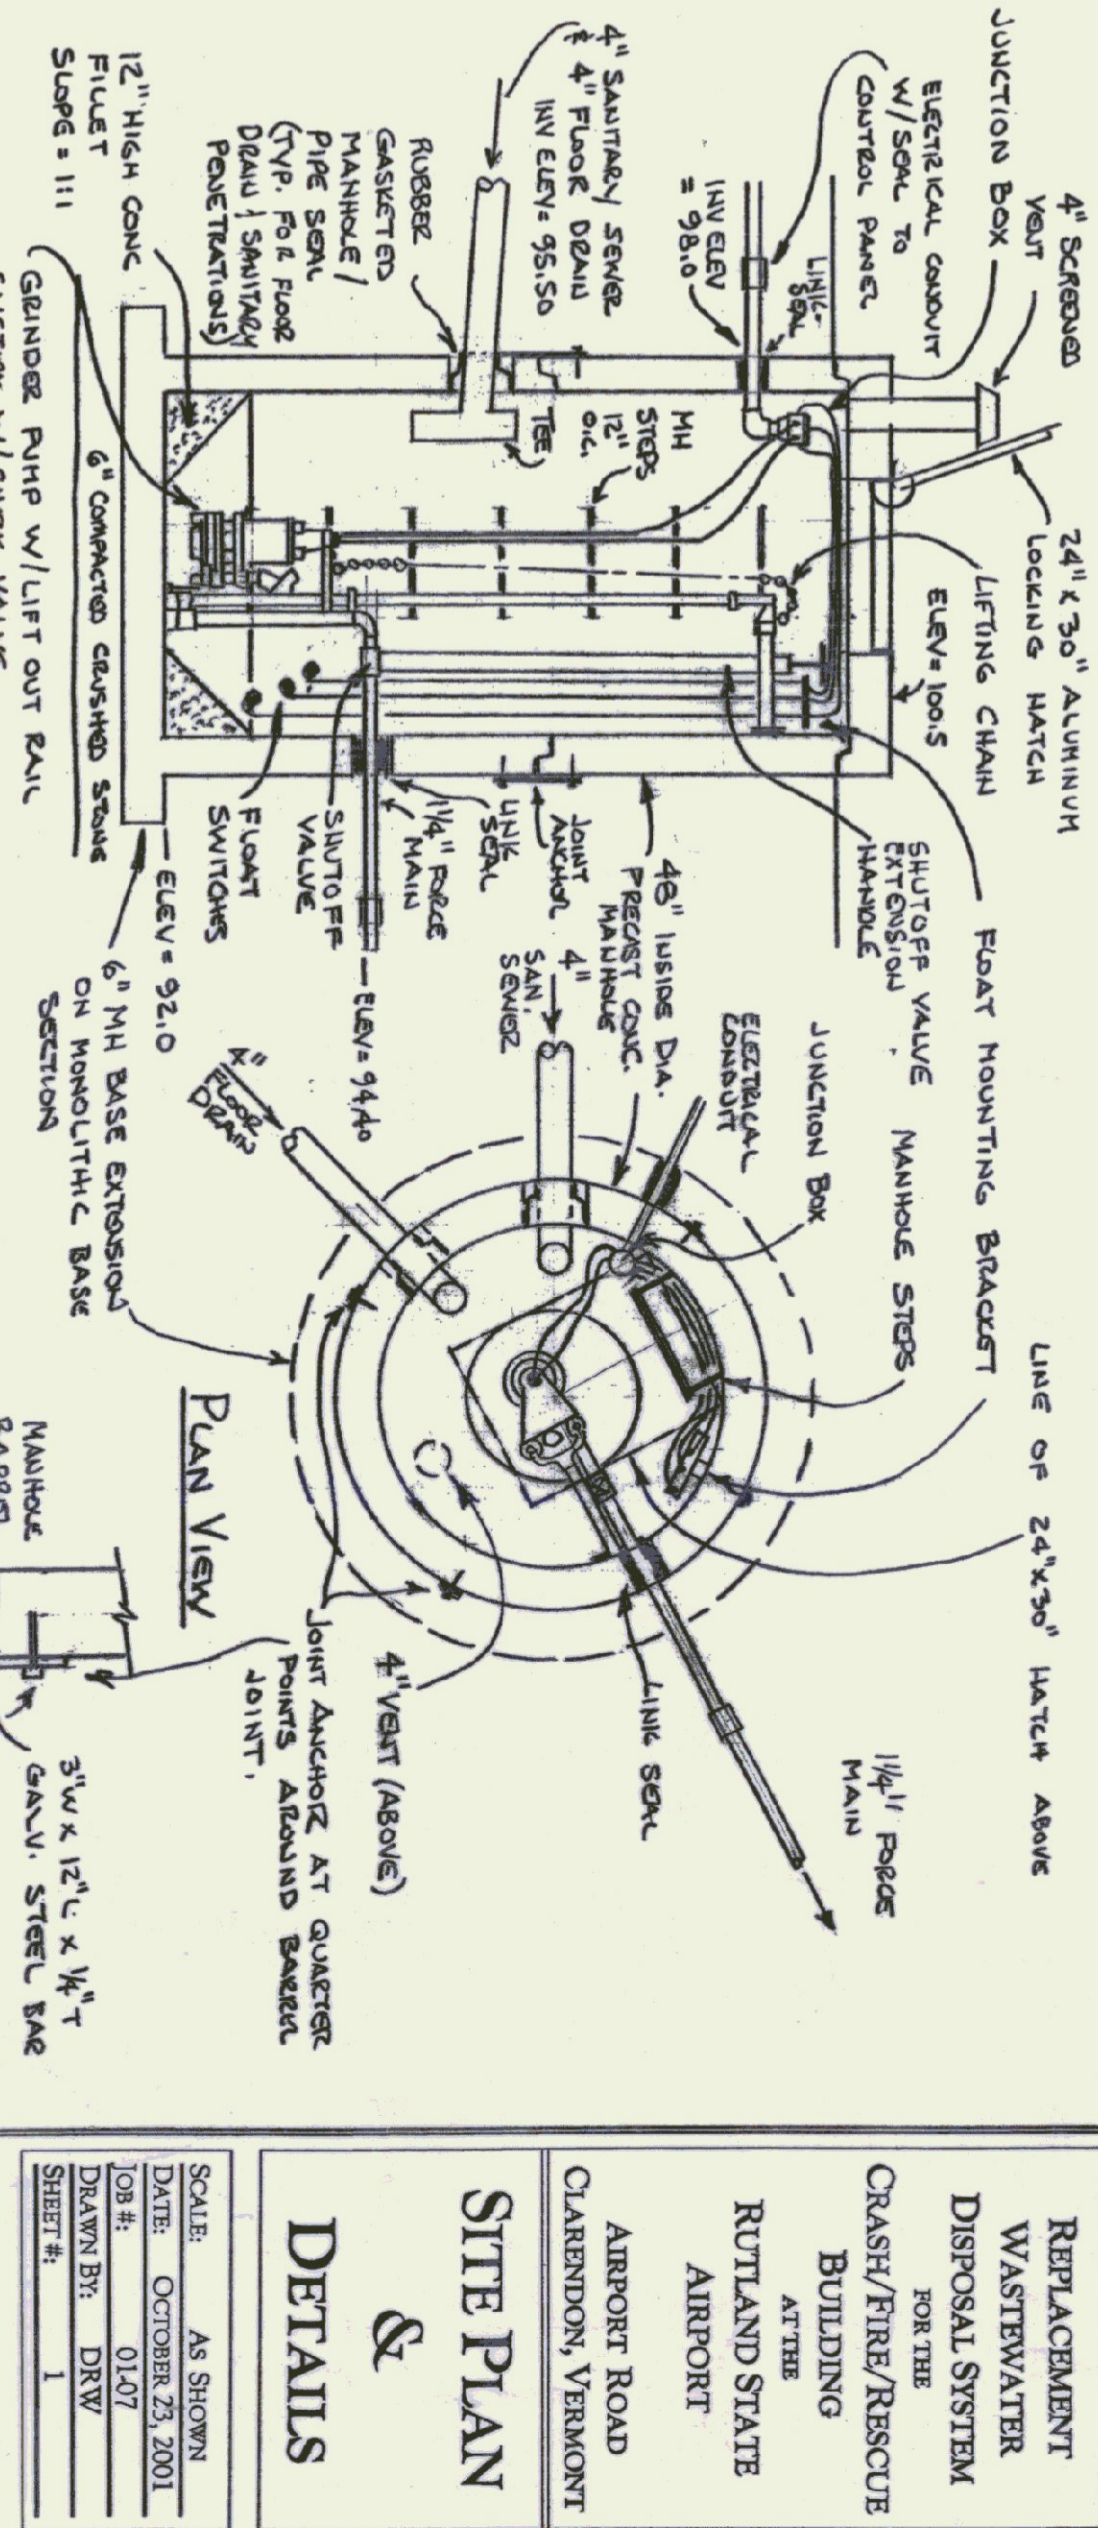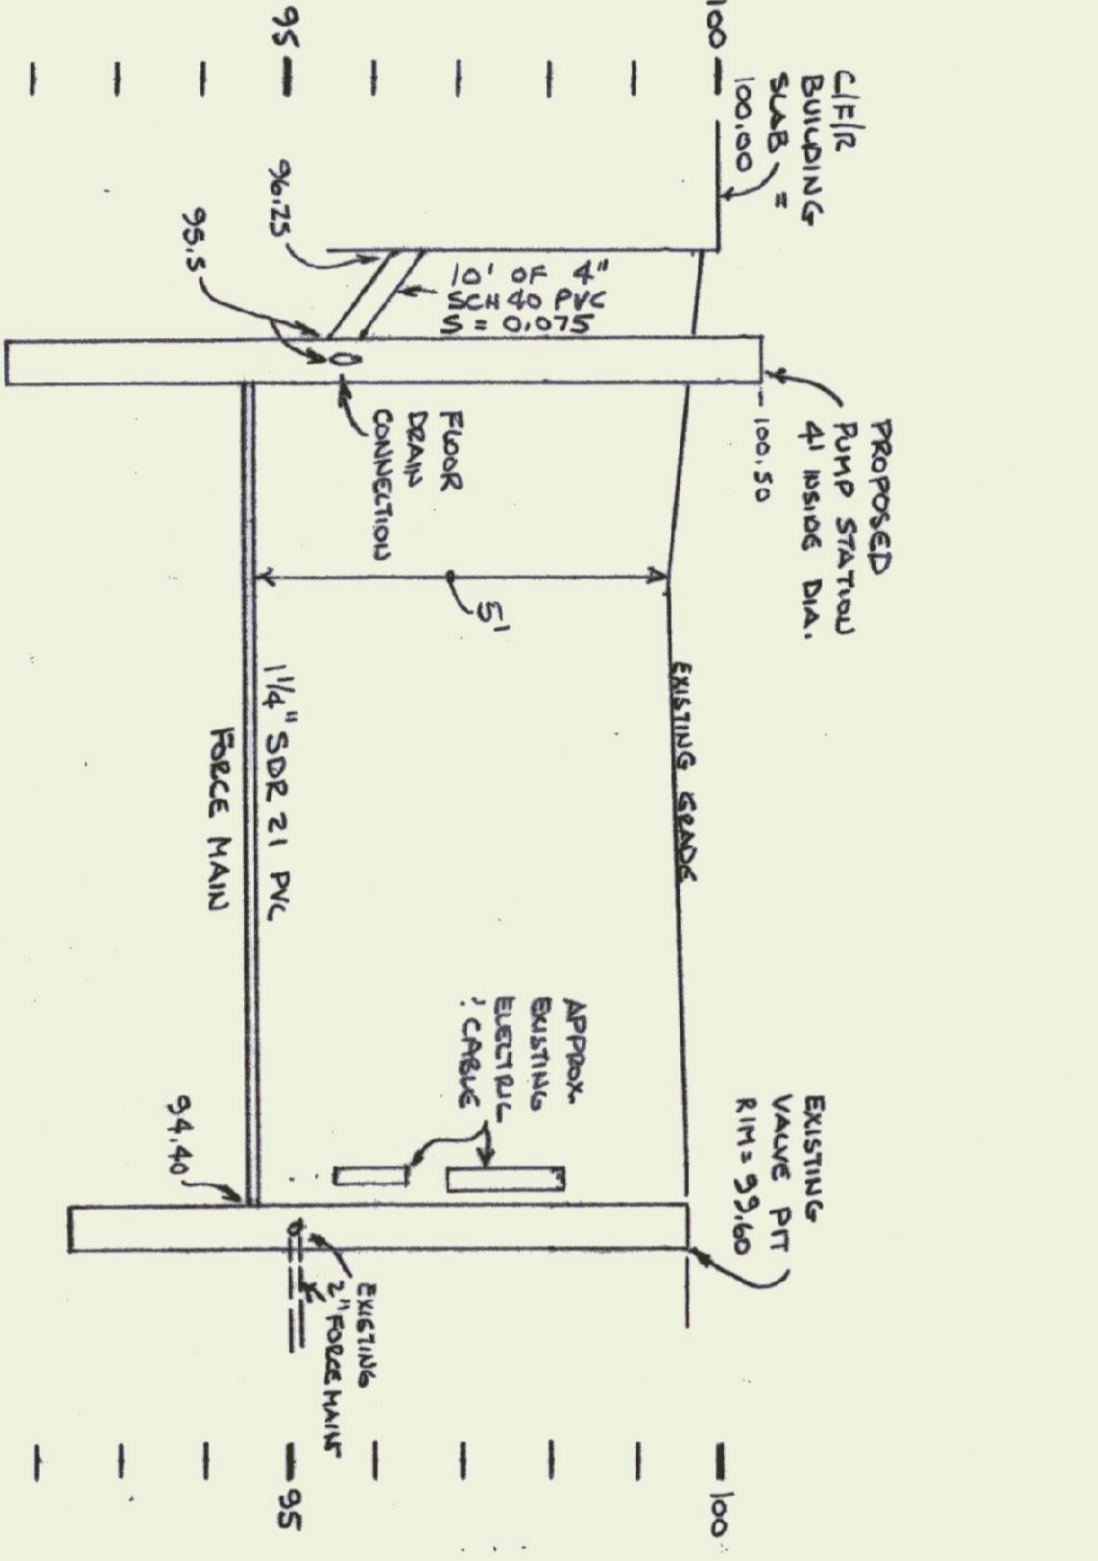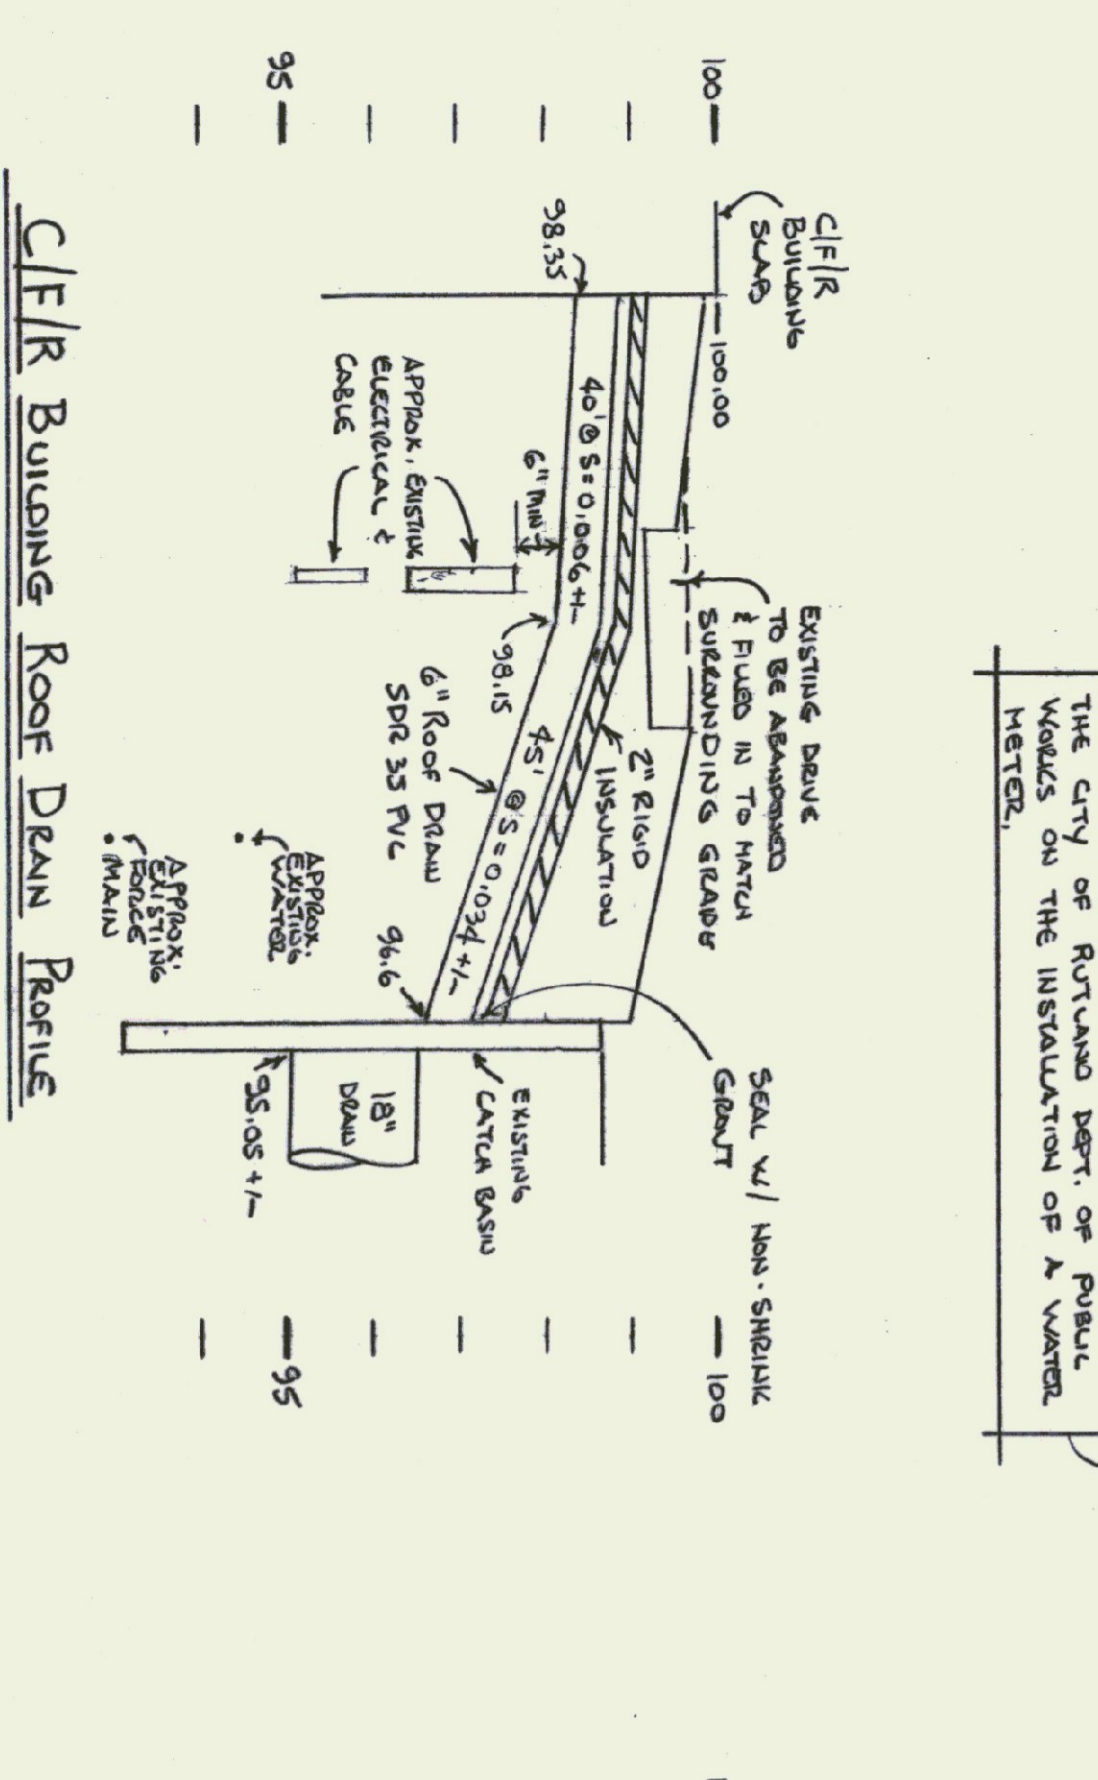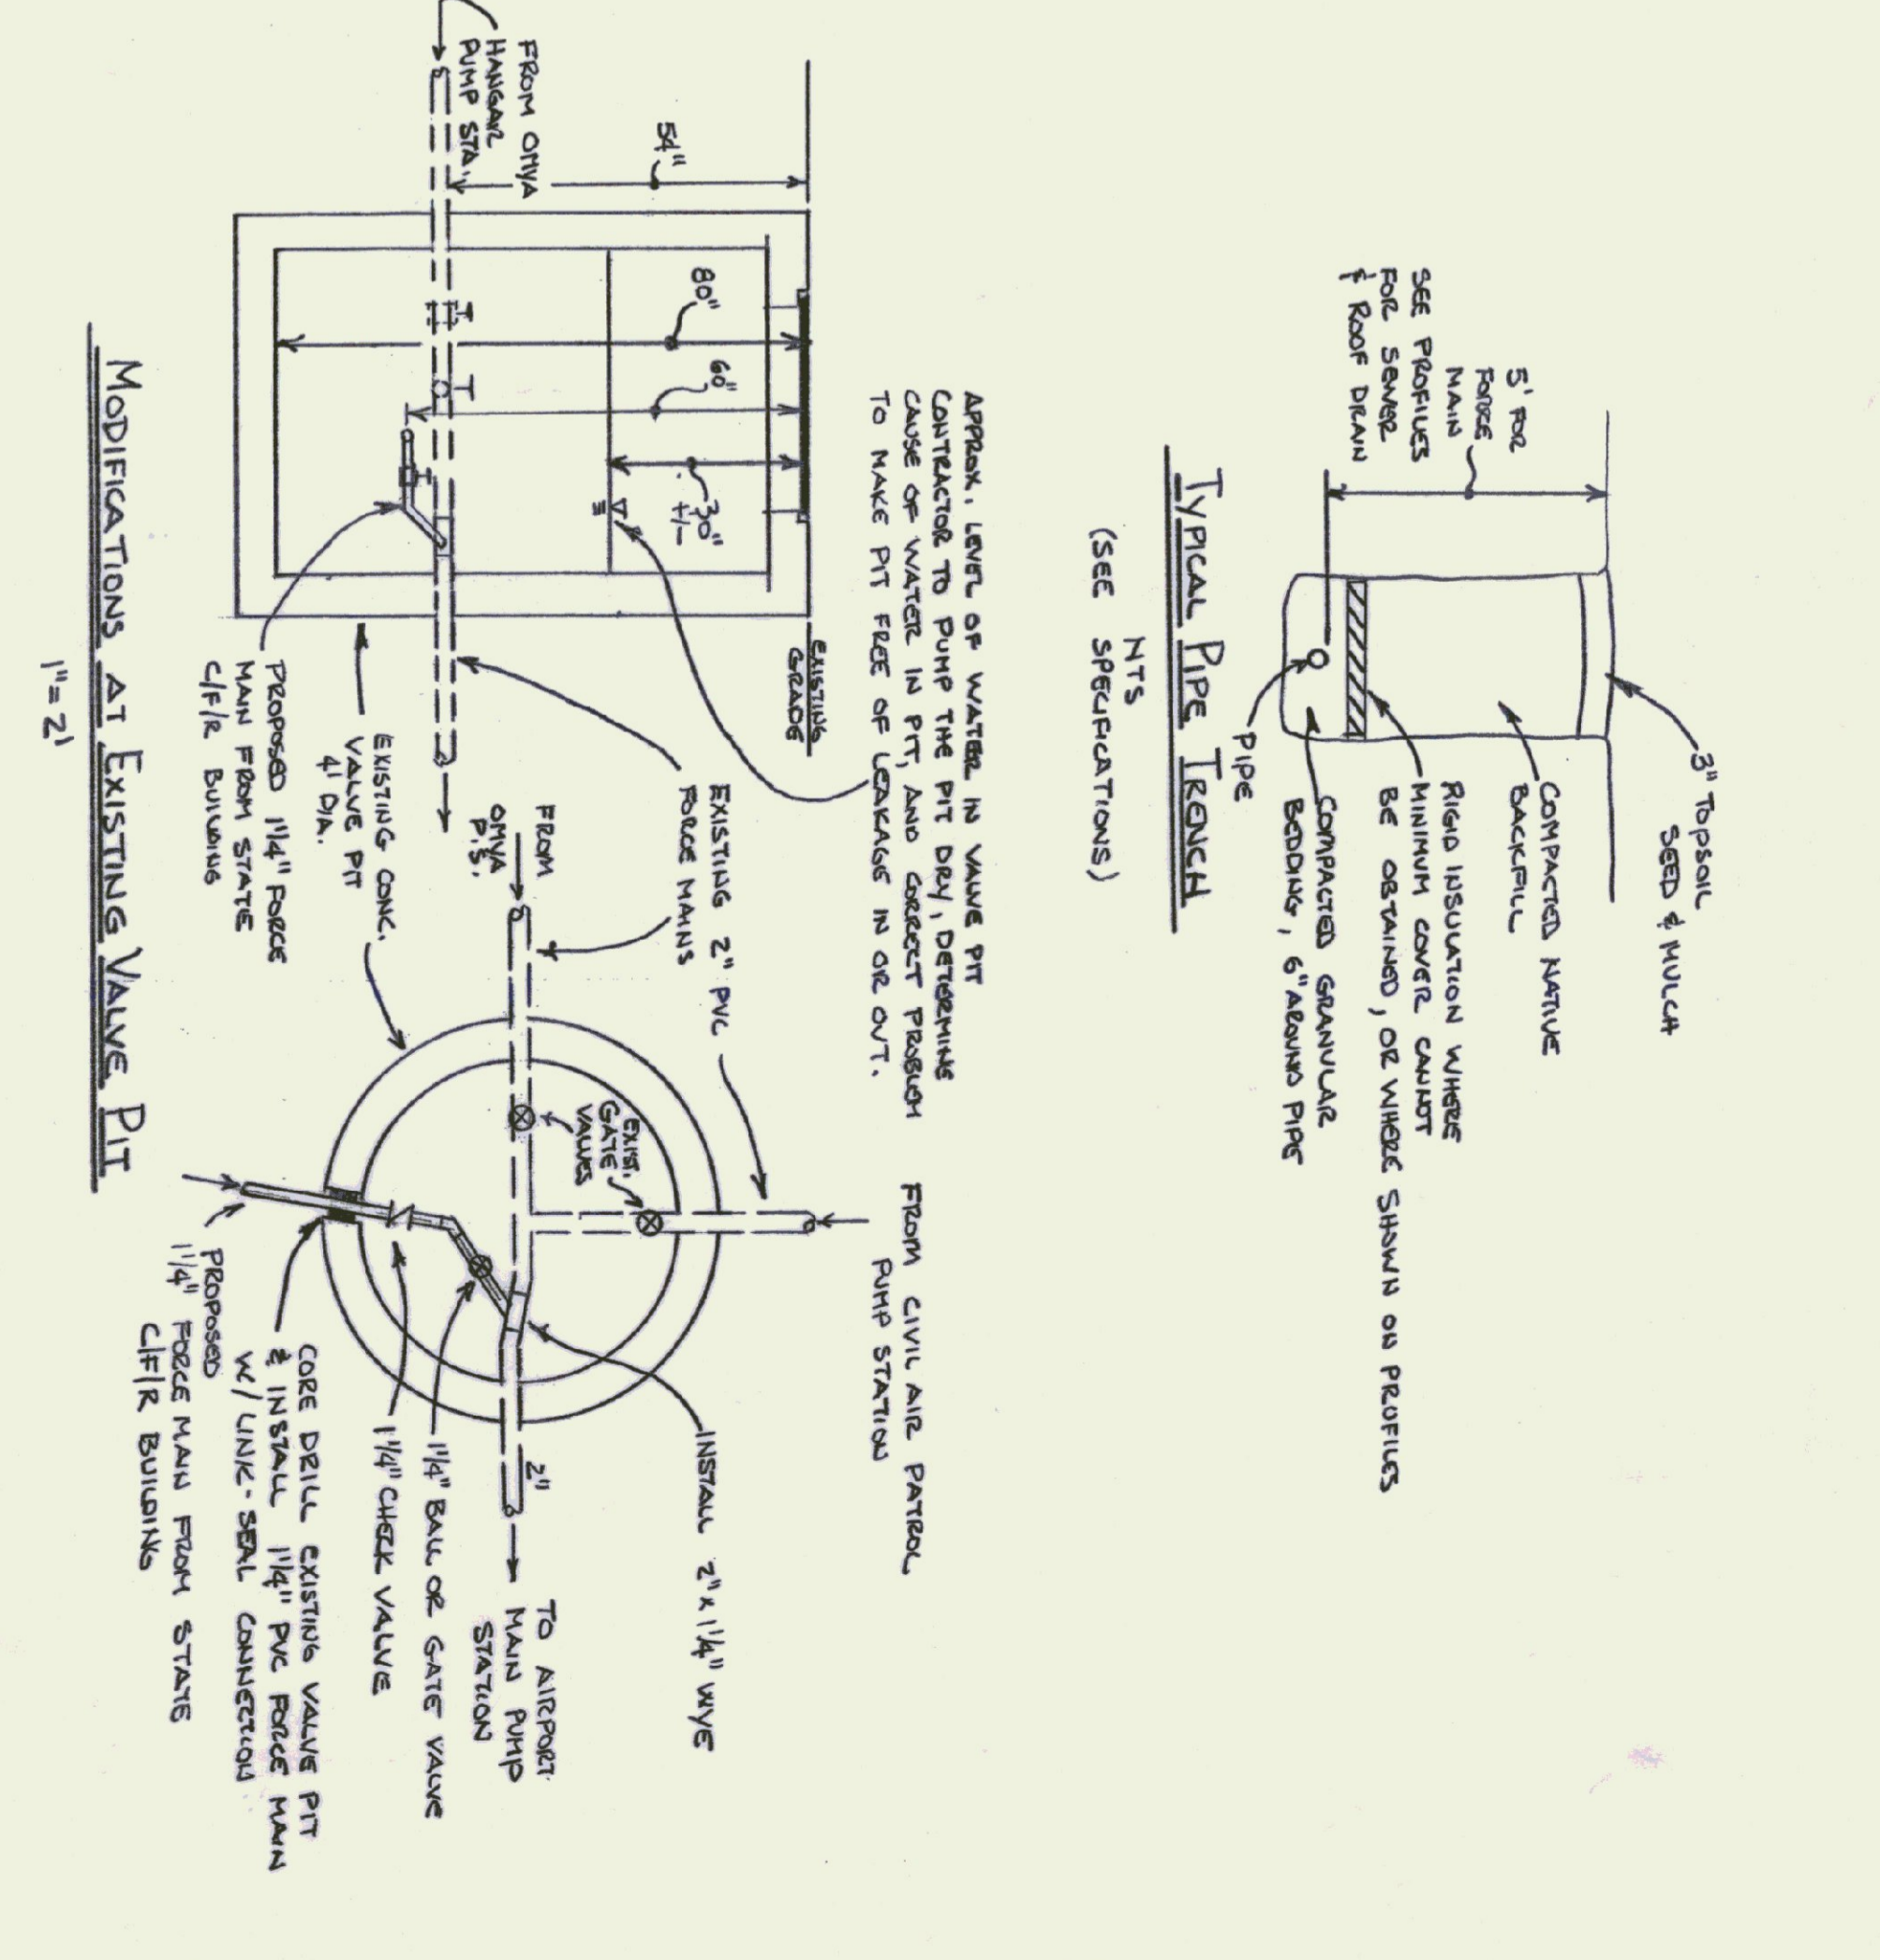

C/F/R Building Roof Drain Profile
SCALE: H: 1" = 2'
V: 1" = 2'

EXISTING ELECTRICAL, CABLE, WATER, & FORCE MAIN LOCATIONS & DEPTHS ARE APPROXIMATE. CONTRACTOR TO VERIFY PRIOR TO INSTALLATION OF DRAIN.

C/F/R Building Force Main Profile
SCALE: H: 1" = 2'
V: 1" = 2'

CONTRACTOR TO VERIFY LOCATION & DEPTH OF EXISTING UTILITIES PRIOR TO INSTALLATION OF PUMP STATION & FORCE MAIN.

SECTION
1" = 2'

GRINDER PUMP STATION
1" = 2'

NOTE: THERE IS A SEPARATE DOCUMENT FOR THE SPECIFICATIONS AND DESIGN CRITERIA FOR THIS PROJECT, AND SHOULD BE ATTACHED TO THIS SITE PLAN. IT CONTAINS IMPORTANT INFORMATION FOR THE CONSTRUCTION OF THE PROJECT, AND IT IS IMPORTANT TO REVIEW AND REFERENCE THE SPECIFICATIONS, PRIOR TO AND DURING THE ACTUAL CONSTRUCTION OF THE PROJECT. IF THIS DOCUMENT IS NOT ATTACHED TO THE SITE PLAN, CONTACT THE PROJECT OWNER OR THE DESIGN ENGINEER TO OBTAIN A COPY.

REVISIONS:

NO.	DATE	DESCRIPTION
1	10/23/2001	AS SHOWN
2	01/07	DRW

SCALE: AS SHOWN
DATE: OCTOBER 23, 2001
JOB #: 0107
DRAWN BY: DRW
SHEET #: 1

WOODS & CO.
CIVIL ENGINEERING
4175 CHEROKEE ROAD
NORTH CALANDRON, VT 05759
802/730-0333

REPLACEMENT WASTEWATER DISPOSAL SYSTEM FOR THE CRASH/FIRE/RESCUE BUILDING AT THE RUTLAND STATE AIRPORT

AIRPORT ROAD CLARENDON, VERMONT

SITE PLAN & DETAILS

C1