

**SPECIAL PROVISION
(METAL HAND RAILING)**
STA. 2+23 TO STA. 2+49 LT.

REMOVE AND REPLACE EXISTING RAIL
(SEE SHEET 35)
REMOVE & REPLACE CONCRETE CAP
(SEE SHEET 31)

REMOVAL OF EXISTING RAIL
STA. 2+23 TO STA. 2+49 LT.

REMOVE AND REPLACE
CONCRETE SIDEWALK
(TYP. FOUR CORNERS)

**REMOVE EXISTING SIDEWALK PER
PAY ITEM SOLID ROCK EXCAVATION**
STA. 2+23 TO 2+49 LT & RT.
STA. 3+79 TO 4+05 LT & RT.

REMOVAL OF EXISTING CURB
STA. 2+23 TO 2+49 LT & RT.
STA. 3+79 TO 4+05 LT & RT.

**CAST-IN-PLACE
CONCRETE CURB, TYPE B**
STA. 2+23 TO 2+49 LT & RT.
STA. 3+79 TO 4+05 LT & RT.

PORTLAND CEMENT CONC. SIDEWALK, 5 INCH
STA. 2+23 TO 2+49 LT & RT.
STA. 3+79 TO 4+05 LT & RT.

**SPECIAL PROVISION
(BOX BEAM GUARD RAIL, TRUSS)**
(SEE SHEET 34)
STA. 2+30 TO STA. 2+56 LT. & RT.
STA. 3+72 TO STA. 3+88 LT. & RT.


**REMOVE EXISTING CONCRETE CAP
PER PAY ITEM REMOVAL OF CONCRETE
OR MASONRY**
STA. 2+23 TO STA. 2+49 LT.

**TEMPORARY TRAFFIC BARRIER
(CONCRETE MEDIAN BARRIER)**
STA. 2+45 LT. & RT. ±
STA. 3+85 LT. & RT. ±

SITE PLAN

SCALE 1" = 10'-0"
10 0 10

- NOTES:**
- EXISTING BRIDGE DECK AND SIDEWALK TO BE REPLACED.
 - HAND EXCAVATE TO LOCATE WATER LINE. PROVIDE 1'-0" MIN. CLEARANCE WITH GUARD RAIL POSTS.
 - REFER TO SHEETS 16 AND 18 FOR ADDITIONAL ROADWAY CONSTRUCTION ITEMS.

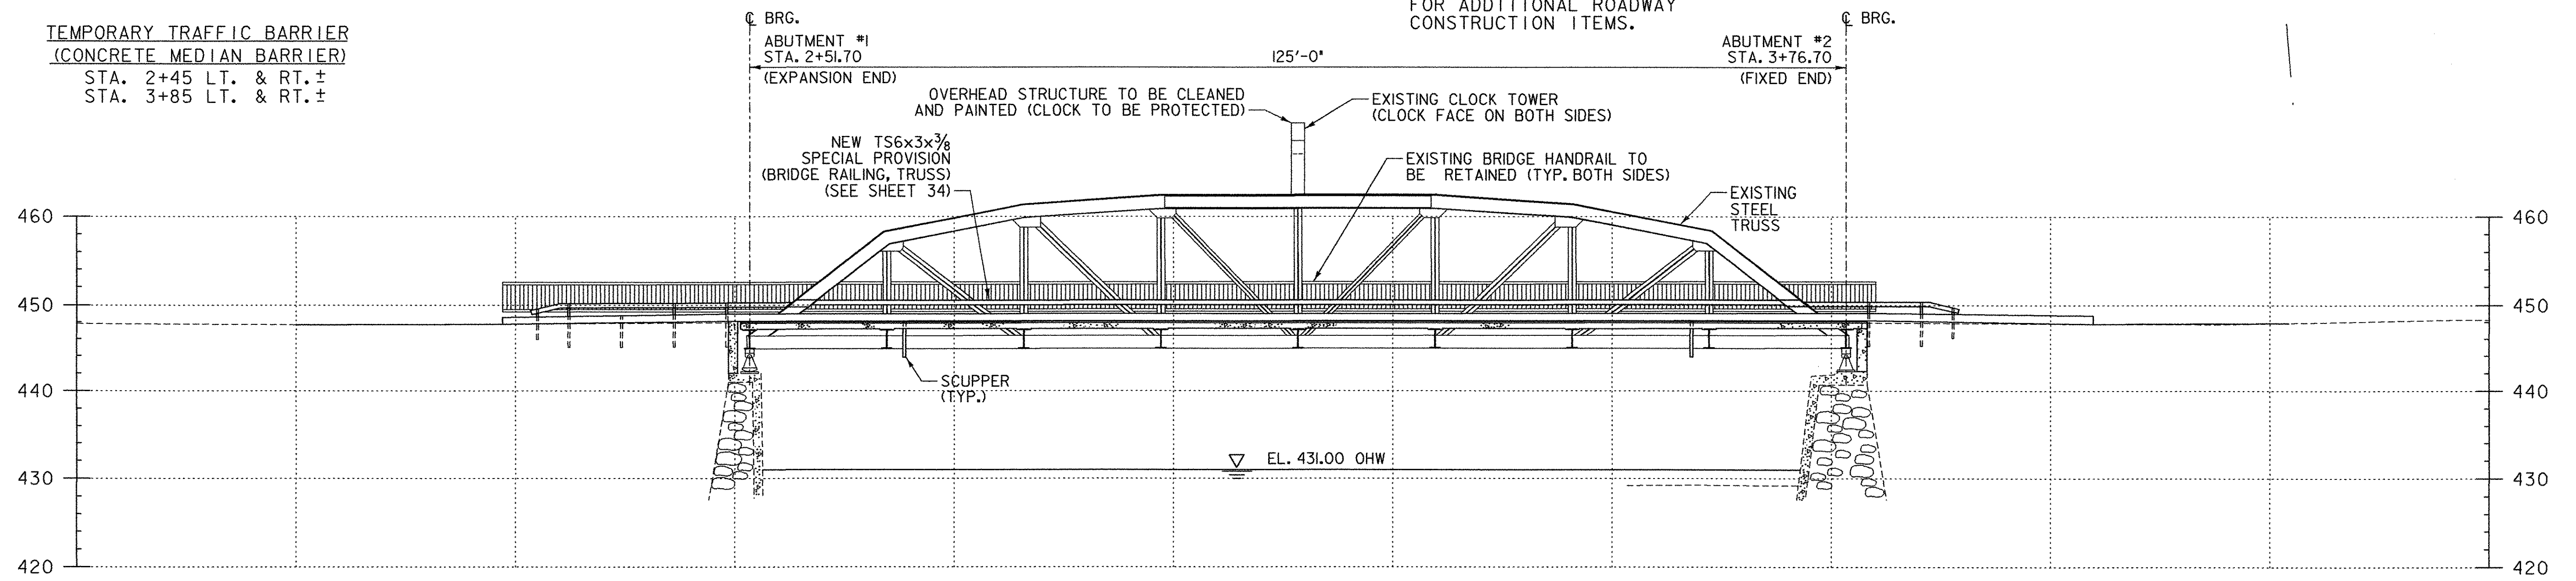

ELEVATION

SCALE 1" = 10'-0"
10 0 10



PROJECT NAME: RICHFORD	PLOT DATE: 12/18/2007
PROJECT NUMBER: BHF 0302 (3) S	DRAWN BY: AET
FILE NAME: ...Design\Rich-plan.dgn	CHECKED BY: MJC
PROJECT LEADER: MJC	DESIGNED BY: SEB
SITE PLAN AND ELEVATION	
SHEET 8 OF 41	