



FRAMING PLAN
SCALE 1" = 10'-0"

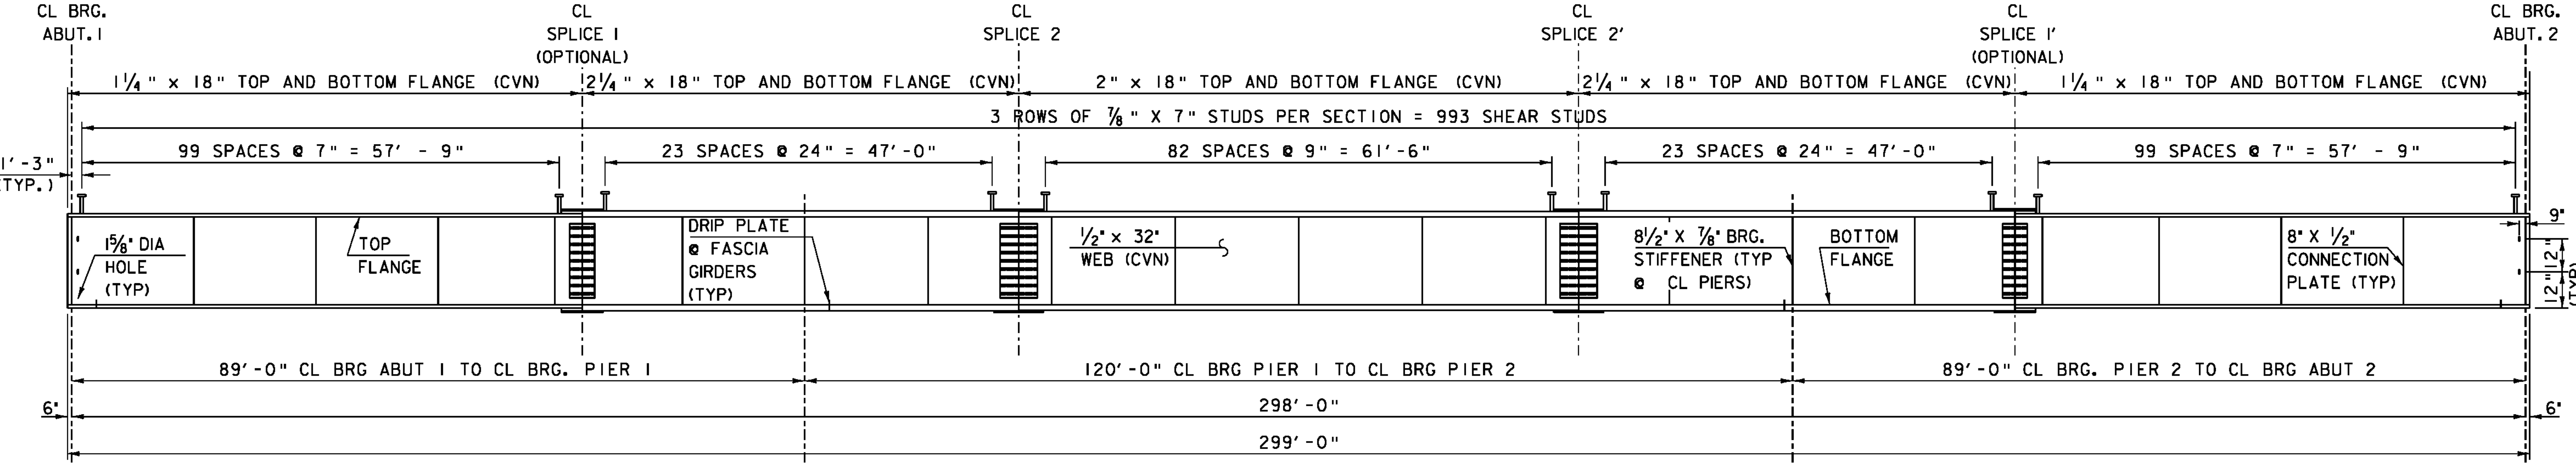

GIRDER ELEVATION
HORIZONTAL SCALE 1" = 10'-0"
VERTICAL SCALE 1/4" = 1'-0"

NOTE:
1. FOR ALL SPLICE DETAILS, BEARING STIFFENERS, AND INTERMEDIATE DIAPHRAGMS SEE GIRDER DETAILS SHEET 34
2. ALL STRUCTURAL STEEL SHALL BE PAINTED BLACK(CHIP COLOR #27038)

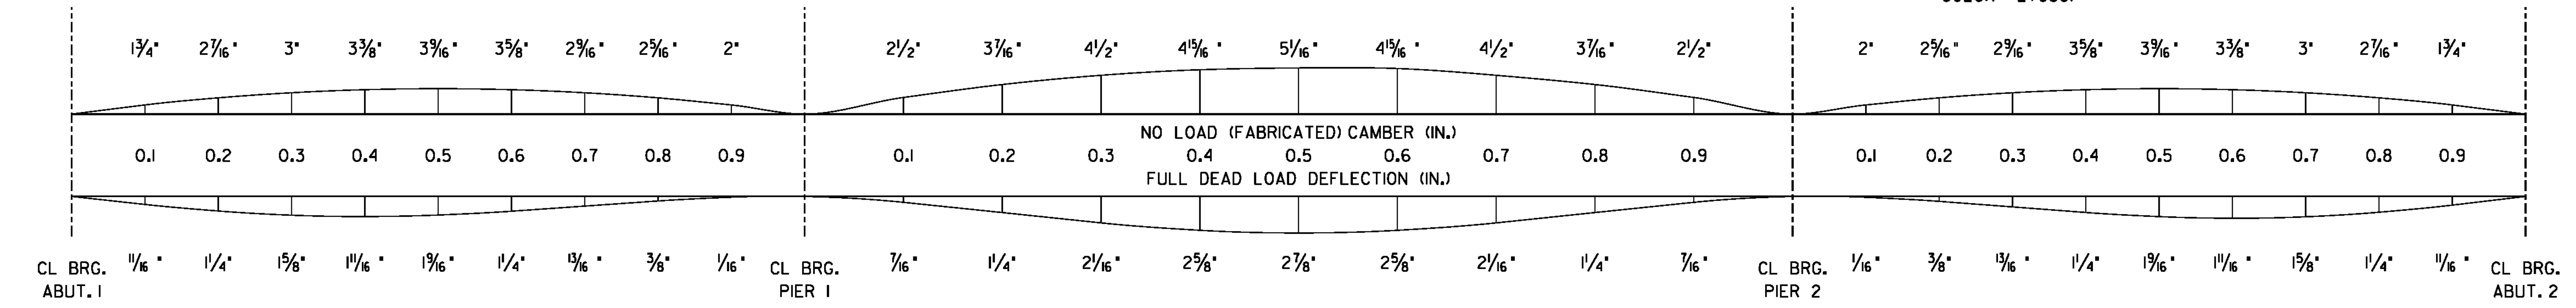

NOTES:
CAMBER AND DEFLECTION MEASUREMENTS ARE GIVEN AT TENTH POINTS

DEAD LOAD DEFLECTION IS DUE TO GIRDER, DIAPHRAGMS, DECK, CURB, SIDEWALK, AND RAILING.

CAMBER AND DEAD LOAD DEFLECTION
HORIZONTAL SCALE 1" = 10'-0"
VERTICAL SCALE 1/2" = 1'-0"

PROJECT NAME: NEWPORT CITY
PROJECT NUMBER: BRO 1449(25)

FILE NAME: str/96j314sup.dgn PLOT DATE: 22-NOV-2011
PROJECT LEADER: C. CARLSON DRAWN BY: C. MOONEY
DESIGNED BY: D. PETERSON CHECKED BY: D. PETERSON
FRAMING PLAN SHEET 33 OF 75