


75B URBAN LAND-COLTON-CROGHAN  
WITH 0% TO 8% SLOPES  
"K FACTOR" = 0.17

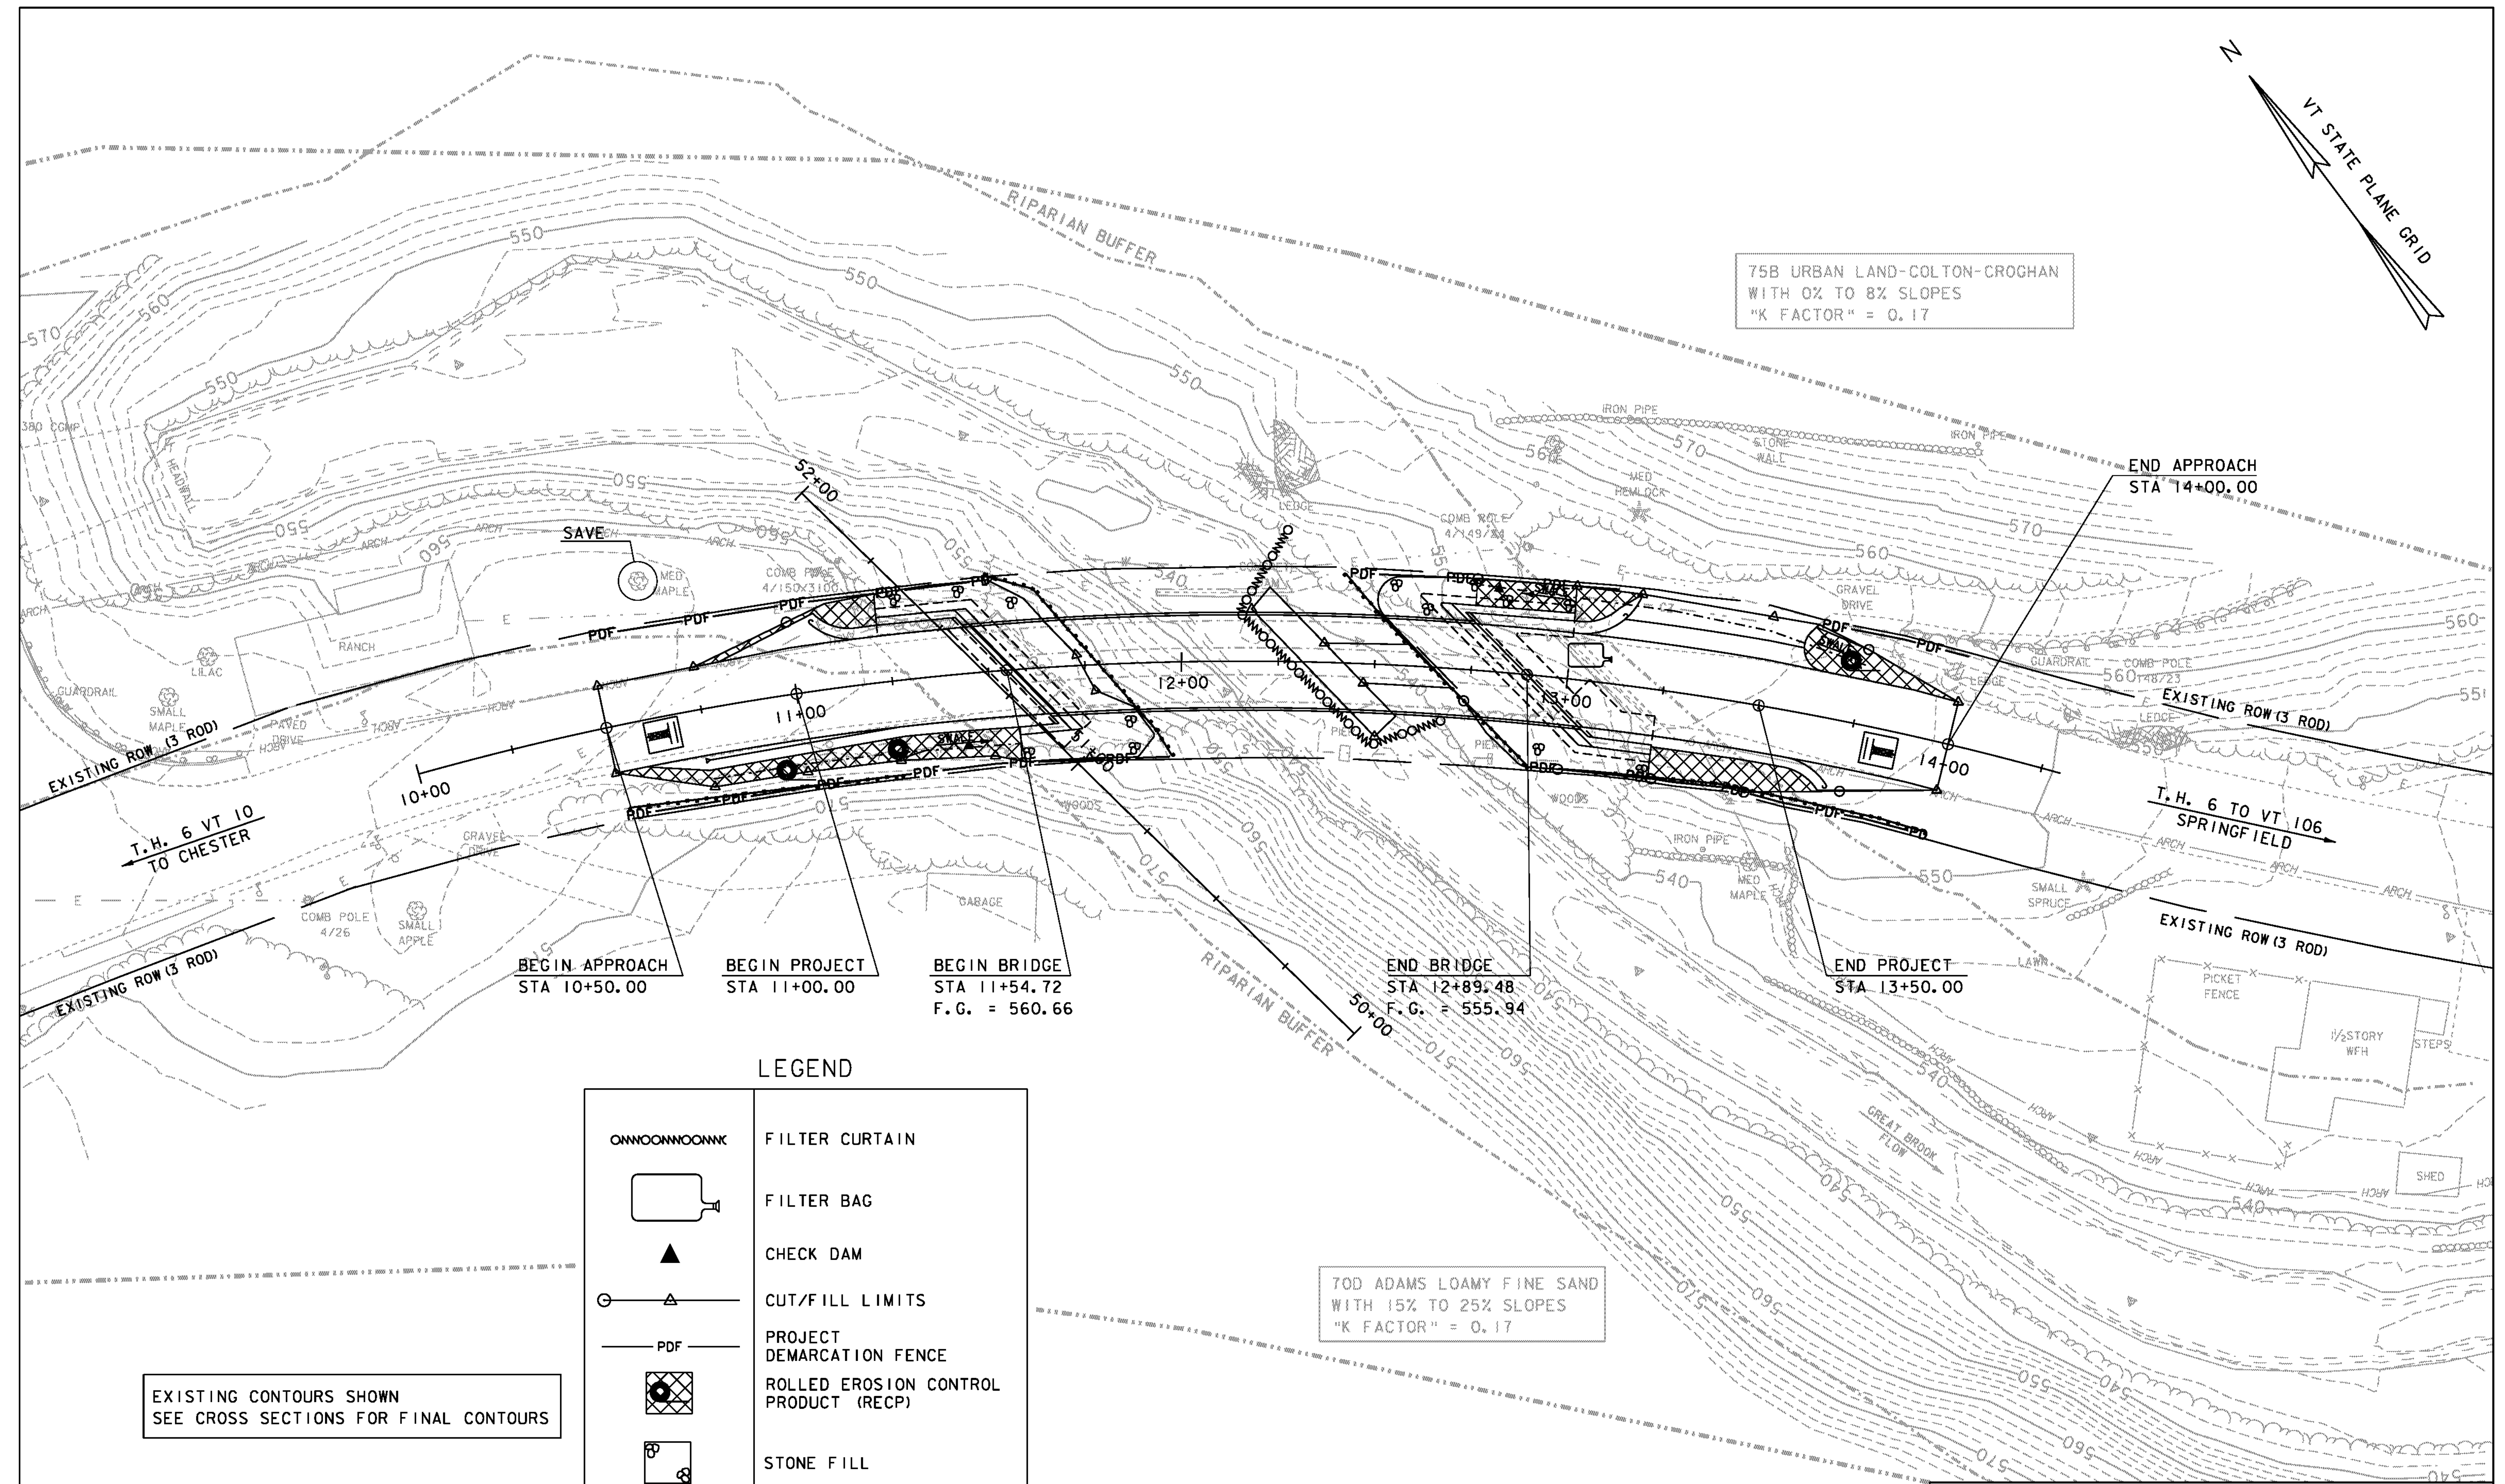

BEGIN APPROACH STA 10+50.00  
 BEGIN PROJECT STA 11+00.00  
 BEGIN BRIDGE STA 11+54.72 F.G. = 560.66  
 END BRIDGE STA 12+89.48 F.G. = 555.94  
 END PROJECT STA 13+50.00  
 END APPROACH STA 14+00.00

LEGEND

	FILTER CURTAIN
	FILTER BAG
	CHECK DAM
	CUT/FILL LIMITS
	PROJECT DEMARCATION FENCE
	ROLLED EROSION CONTROL PRODUCT (RECP)
	STONE FILL
	SILT FENCE WOVEN WIRE
	STABILIZED CONSTRUCTION ENTRANCE

EXISTING CONTOURS SHOWN  
SEE CROSS SECTIONS FOR FINAL CONTOURS

70D ADAMS LOAMY FINE SAND  
WITH 15% TO 25% SLOPES  
"K FACTOR" = 0.17

EPSC DURING CONSTRUCTION

SCALE 1" = 20'-0"  
20 0 20

75B URBAN LAND-COLTON-CROGHAN  
WITH 0% TO 8% SLOPES  
"K FACTOR" = 0.17

PROJECT NAME: SPRINGFIELD  
 PROJECT NUMBER: BRO 1442(26)  
 FILE NAME: s95j282EPSC\_BDR.dgn  
 PROJECT LEADER: K. HIGGINS  
 DESIGNED BY: J. LACROIX  
 EPSC DURING CONSTRUCTION  
 PLOT DATE: 30-AUG-2011  
 DRAWN BY: R. PELLETT  
 CHECKED BY: J. SALVATORI  
 SHEET 39 OF 52