




DECK FRAMING PLAN
(SCALE 1:50)

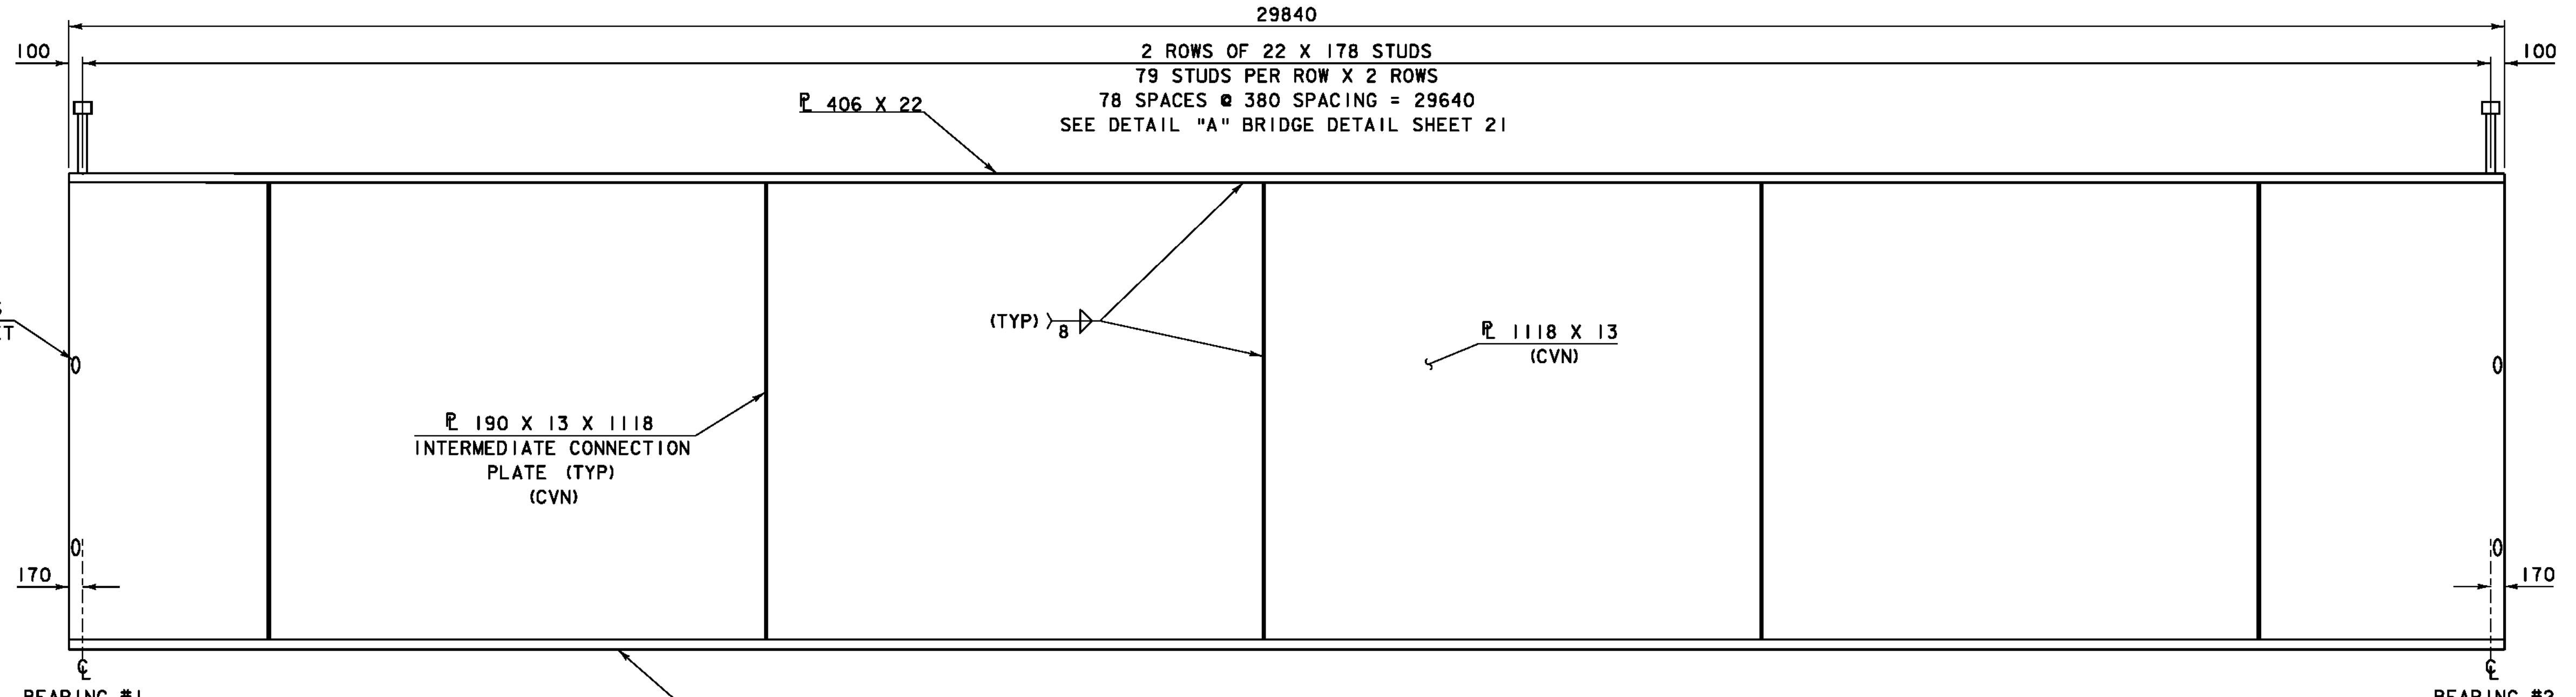


GIRDER ELEVATION
(SCALE: HORZ = 1:50
VERT = 1:10)
NOTE: ALL STEEL MARKED "CVN" SHALL
BE CHARPY V-NOTCH TESTED

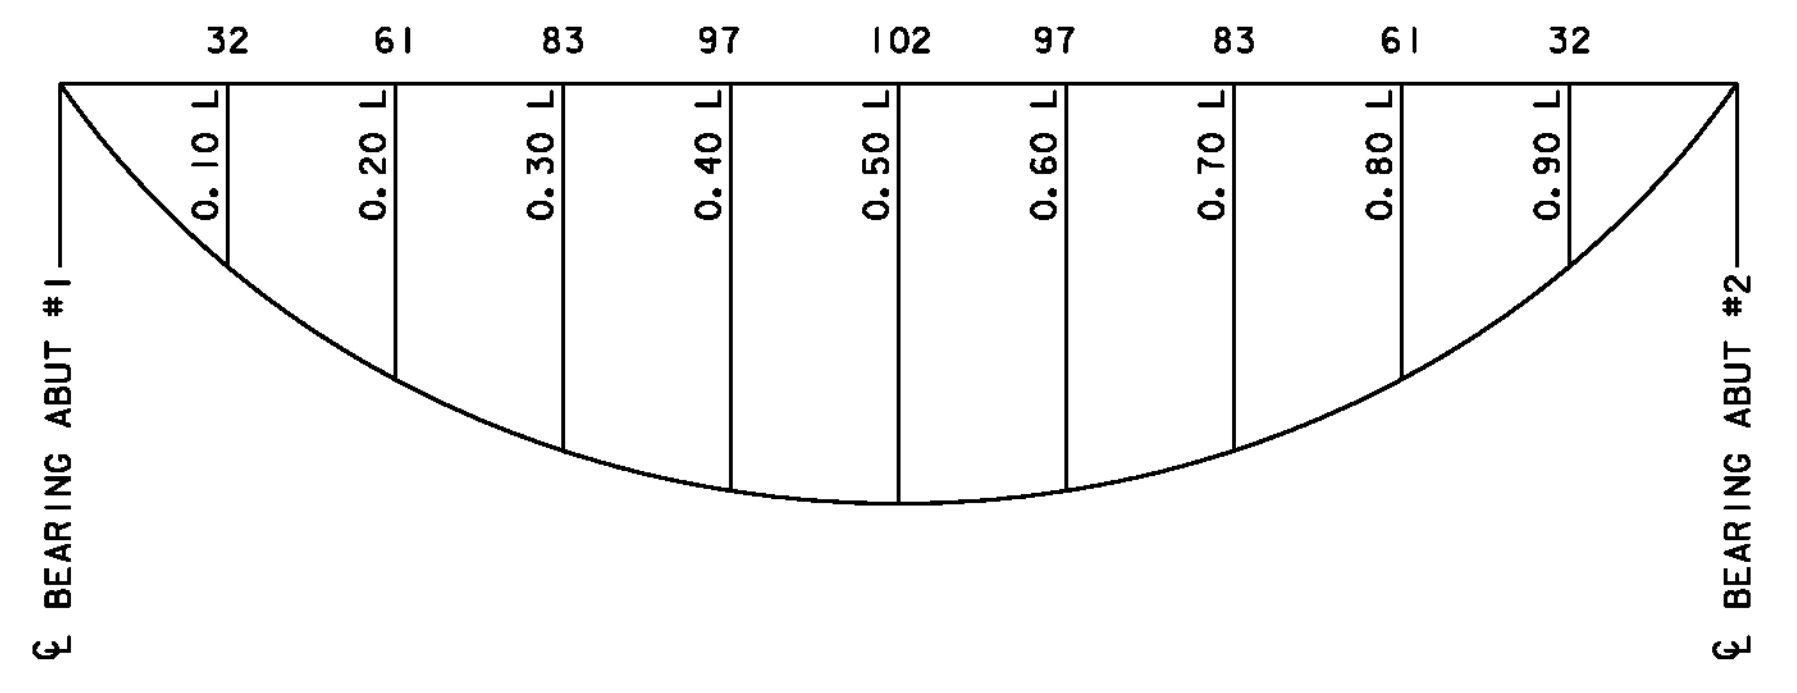

TOTAL DEAD LOAD DEFLECTION DIAGRAM
(NOT TO SCALE)
INCLUDES 17 MM DEFLECTION DUE TO BEAM DEAD LOAD

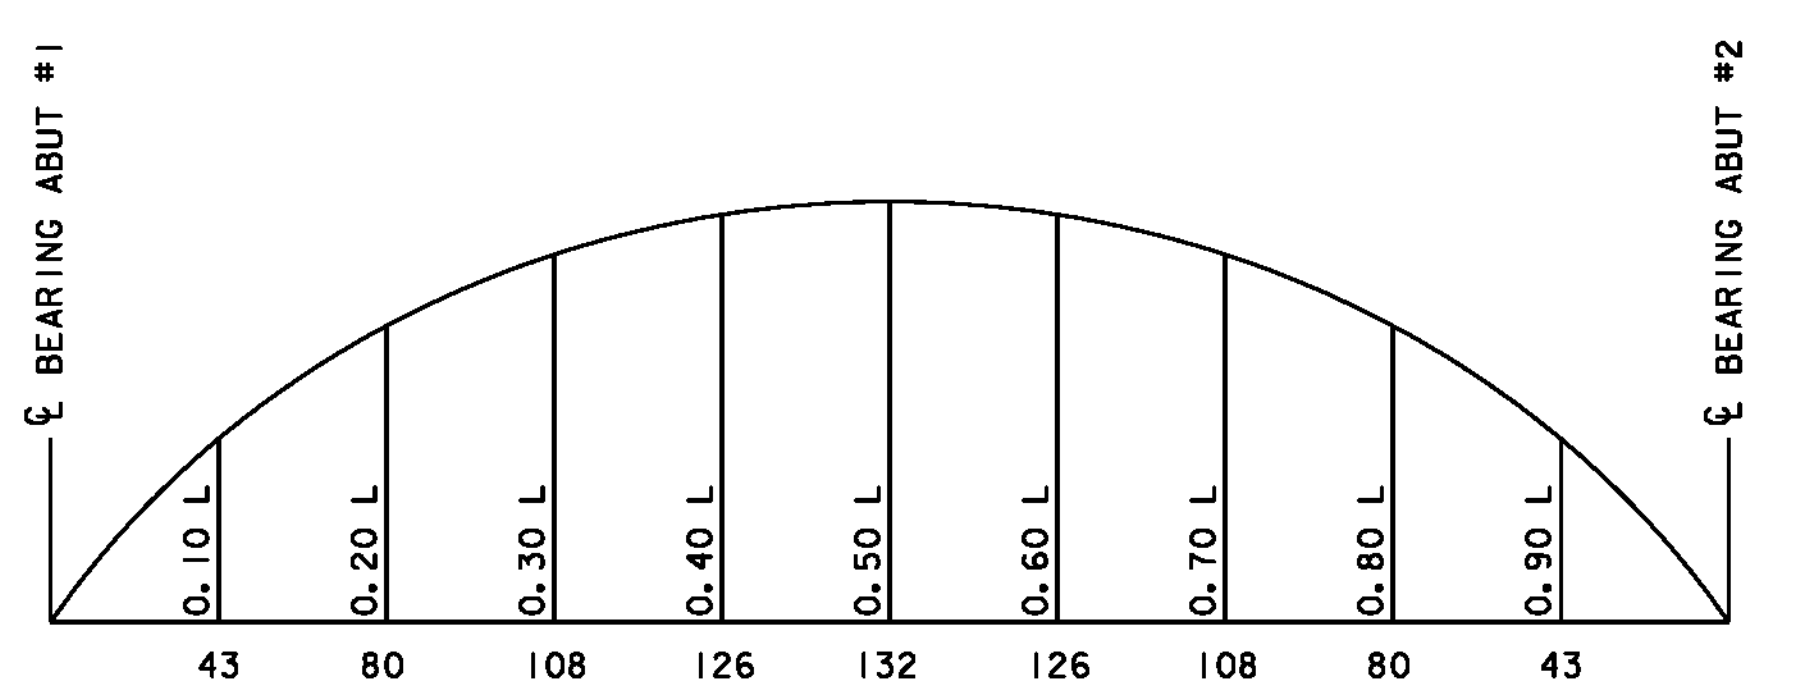

TOTAL CAMBER DIAGRAM
(NOT TO SCALE)
CALCULATED CAMBER AT MID SPAN WHEN BEAM IS SUPPORTED AT BEARINGS = 115 MM

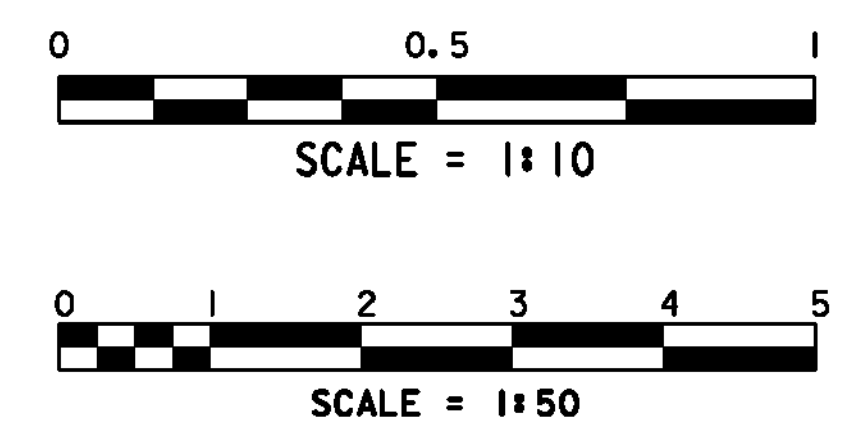

PROJECT: READSBORO	PROJECT NO.: BRO 1441 (25)
DESIGN FILE NAME: 94J070\structures\sj070sup.dgn	PLOT DATE: 05-JAN-2010
IPARM FILE NAME: 94J070frame.i	DESIGNED BY: H. I. SALLS
DESIGNED BY: H. I. SALLS	DRAWN BY: D. D. BEARD
SQUAD LEADER: C. P. WILLIAMS	CHECKED BY: R. S. YOUNG
DECK FRAMING AND GIRDER ELEVATION SHEET: 20 OF 60	