



ABUTMENT 2 REMOVAL LIMITS
 (ABUTMENT 2 SHOWN, ABUTMENT 1 SIMILAR)
 SCALE: 1/2" = 1'-0"

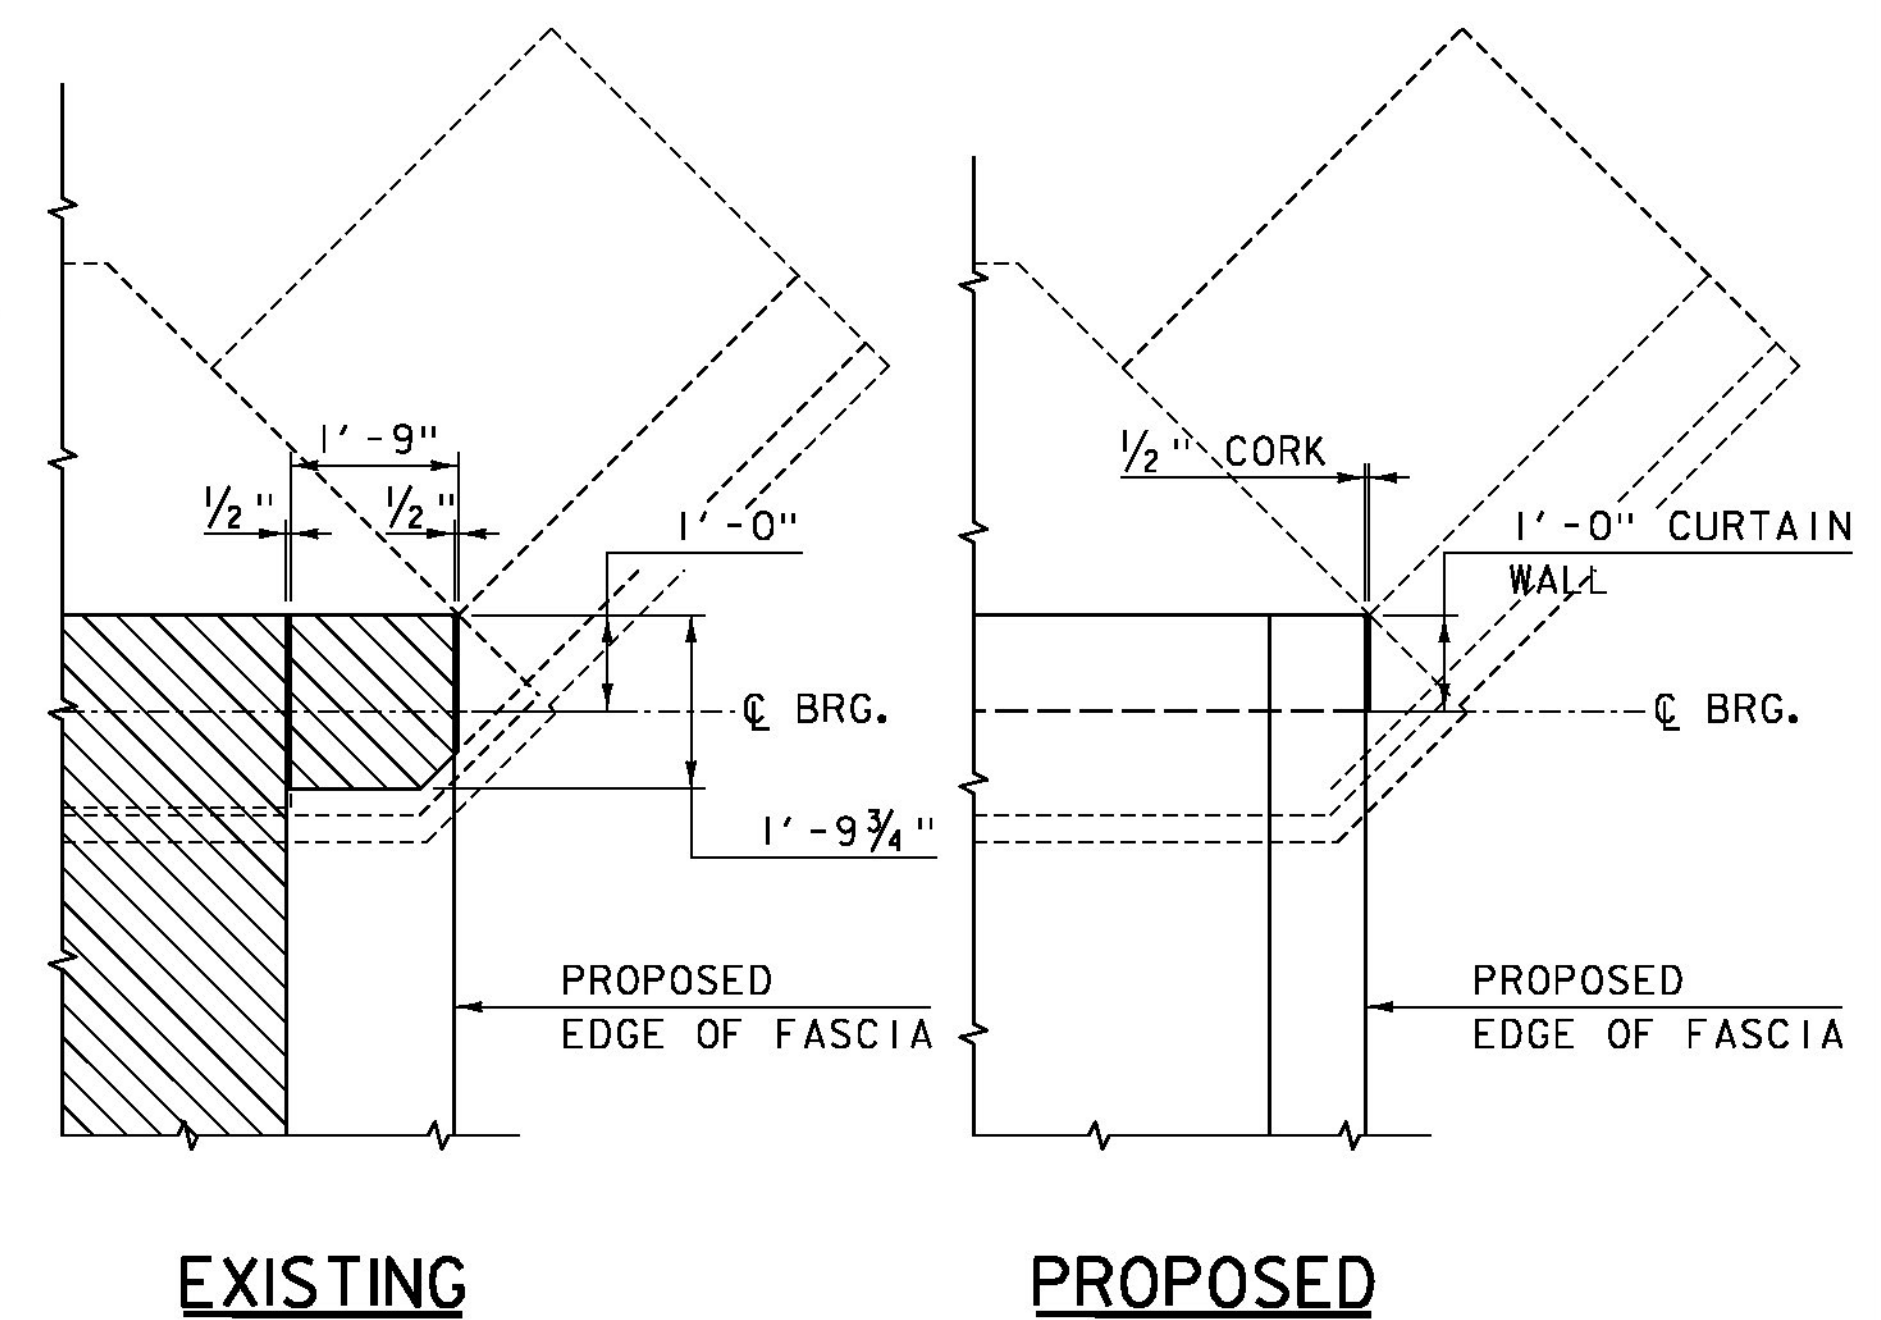

SECTION A-A
 SCALE: 1/2" = 1'-0"

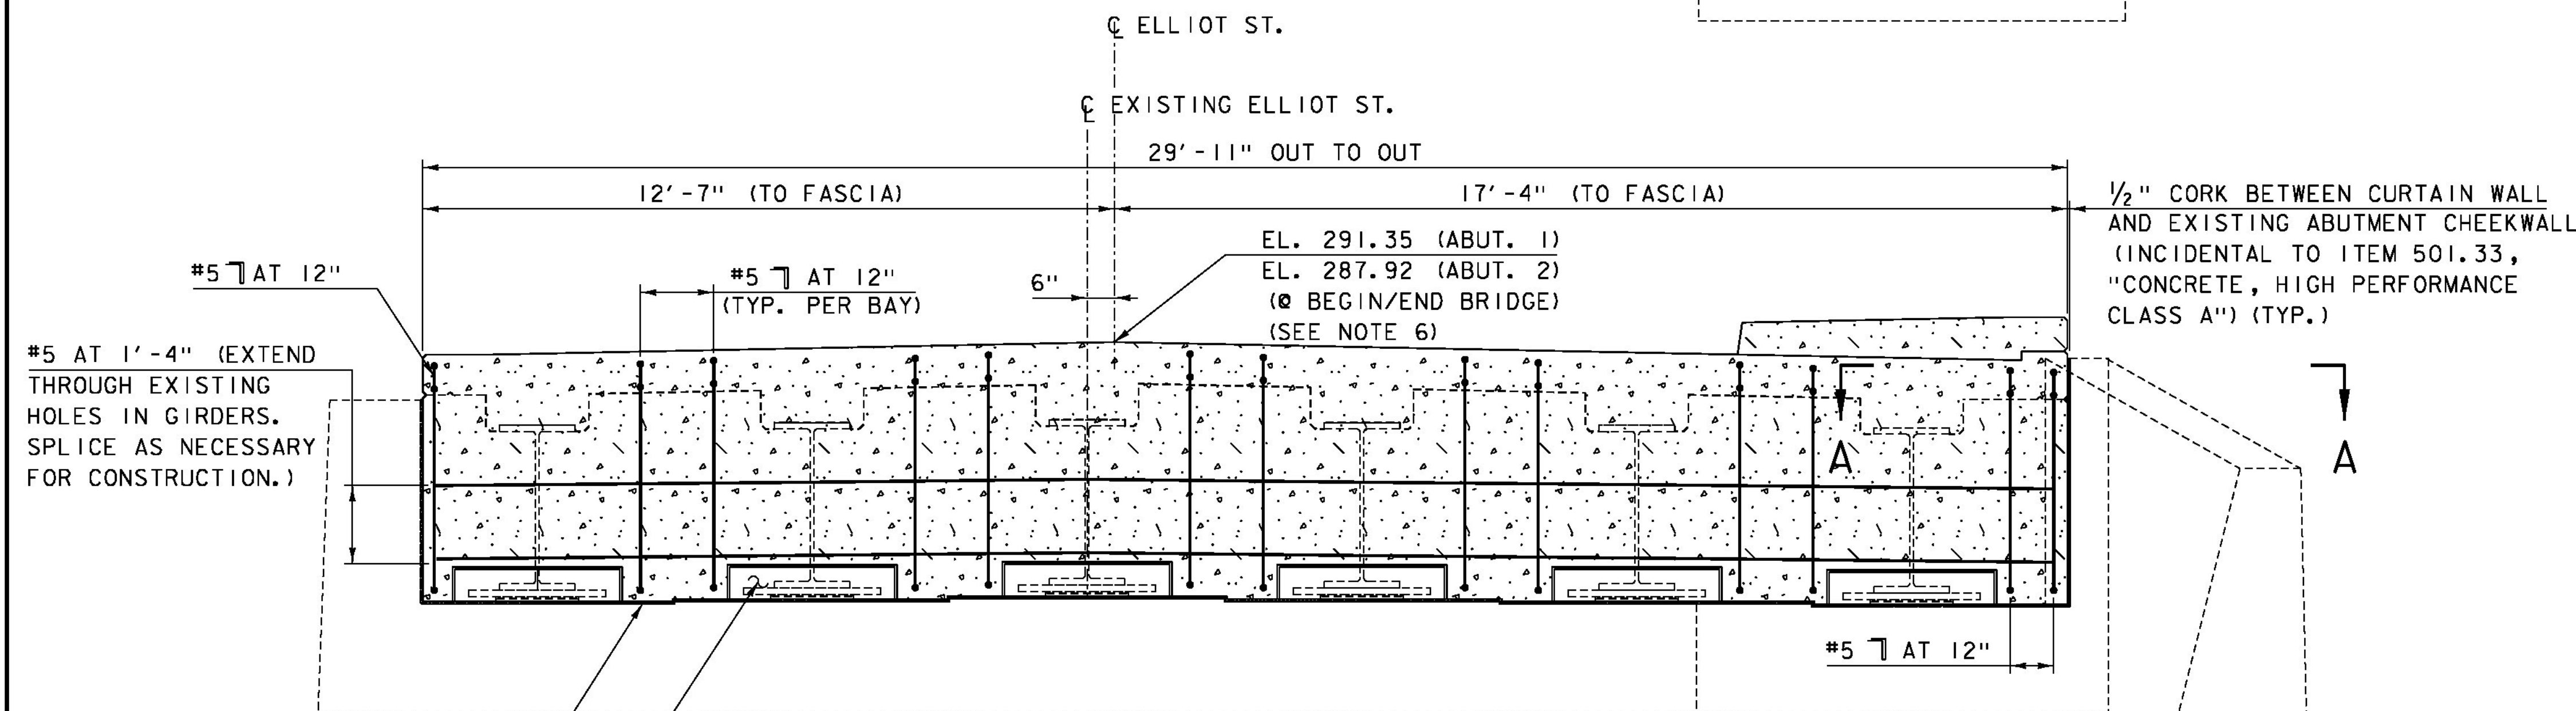

**ABUTMENT 2 CURTAIN WALL
 MASONRY AND REINFORCEMENT ELEVATION**
 (ABUTMENT 2 SHOWN, ABUTMENT 1 SIMILAR)
 SCALE: 1/2" = 1'-0"

- PARTIAL REMOVAL OF STRUCTURE (SEE NOTE 18 ON SHEET 3)
- CONCRETE, HIGH PERFORMANCE CLASS A

NOTES:

1. 3" CLEAR, UNLESS OTHERWISE SPECIFIED ON THE PLANS.
2. 3'-1" BAR LAP UNLESS OTHERWISE SPECIFIED ON THE PLANS.
3. EF = EACH FACE
4. SEE SHEET 16 FOR TYPICAL CURTAIN WALL SECTION AND CURTAIN WALL BLOCKOUT AROUND BEARINGS DETAILS.
5. SEE SECTION F-F ON SHEET 14 FOR CURTAIN WALL AT SIDEWALK RAMP REINFORCEMENT LAYOUT.
6. ELEVATIONS ARE FOR INFORMATIONAL PURPOSES ONLY. FINAL FINISHED GRADE SHALL BE DETERMINED BY VTRANS AFTER EXISTING TOP OF DECK AND TOP OF BEAM ELEVATIONS ARE SURVEYED. SEE PROJECT NOTE 22 ON SHEET 3.

PROJECT NAME: BRATTLEBORO
 PROJECT NUMBER: BF 2000(26)

FILE NAME: z15J091+yp-3i.dgn
 PROJECT LEADER: J. BYATT
 DESIGNED BY: S. BEAUMONT
 PLOT DATE: 2/5/2016
 DRAWN BY: M. SMITH
 CHECKED BY: J. FRENCH
 REMOVAL & CURTAIN WALL DETAILS SHEET 1 SHEET 15 OF 26

