


33A - MOOSILAUKE VERY FINE SANDY LOAM
 0% - 3% SLOPES
 "K" = 0.24
 NOT HIGHLY ERODIBLE

60A - RUMNEY FINE SANDY LOAM, FREQUENTLY FLOODED
 0% - 2% SLOPES
 "K" = 0.28
 NOT HIGHLY ERODIBLE

18D - BUCKLAND FINE SANDY LOAM, VERY STONY
 15% - 35% SLOPES
 "K" = 0.43
 HIGHLY ERODIBLE

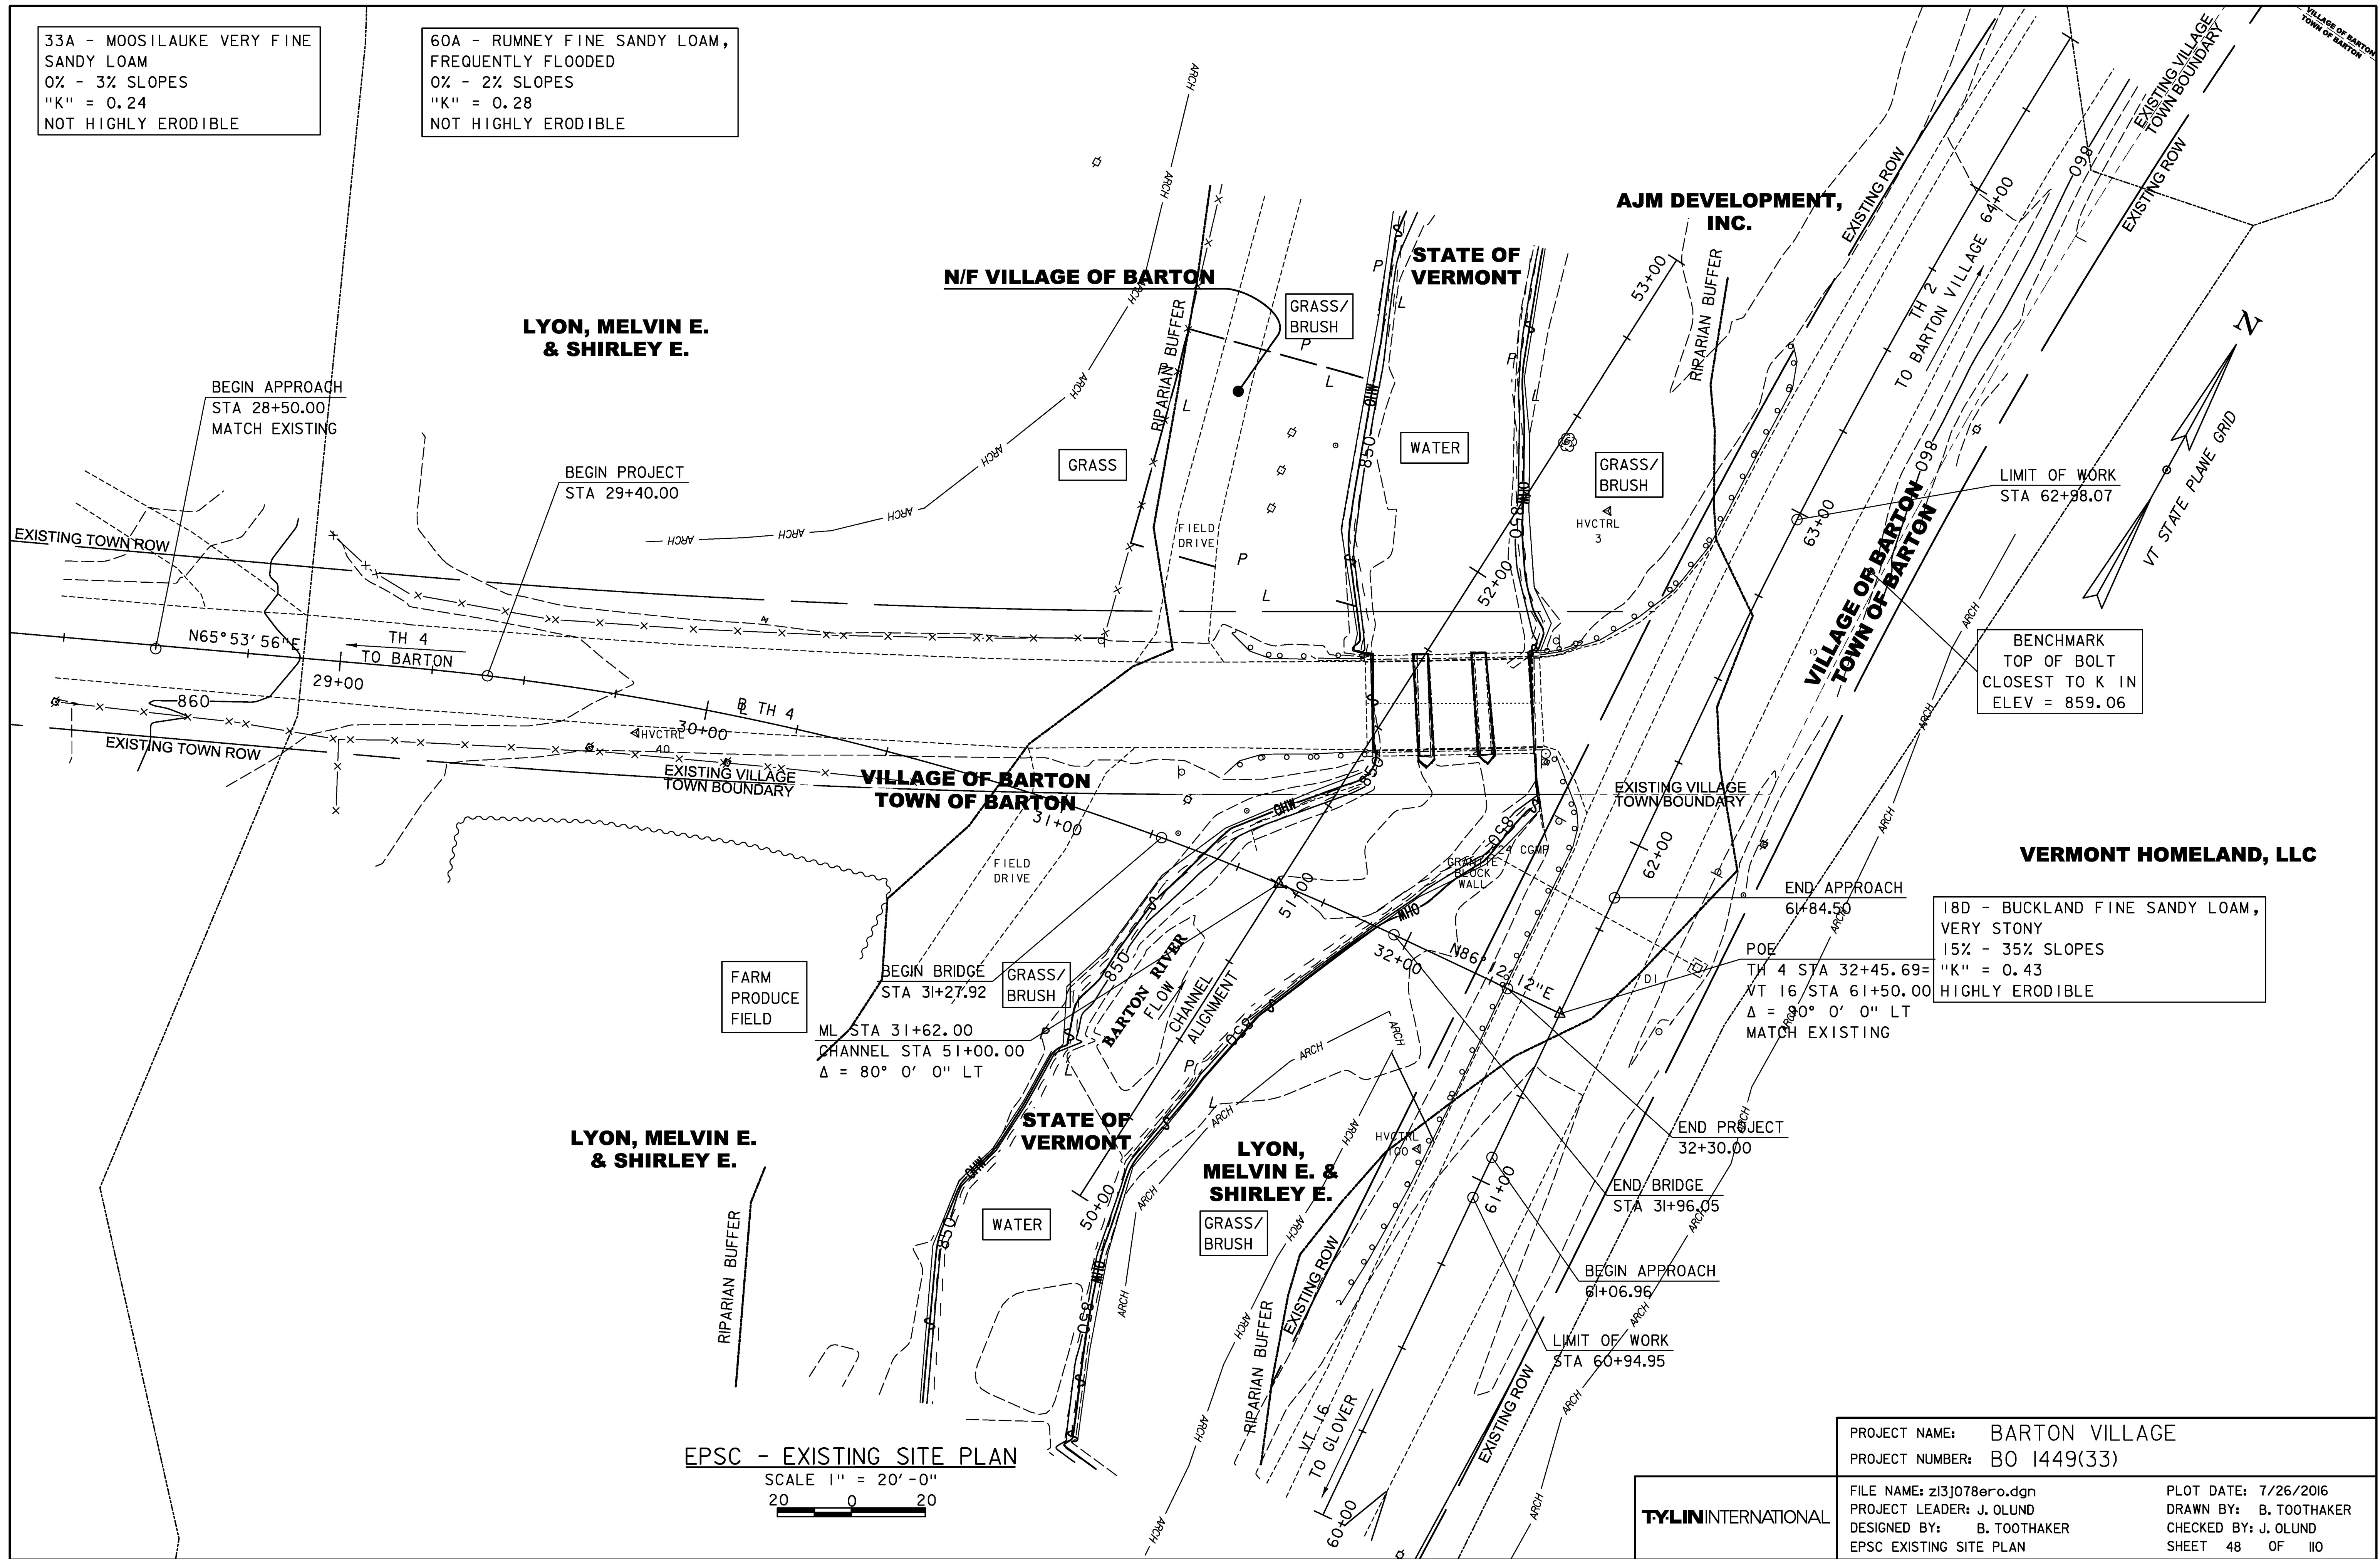

EPSC - EXISTING SITE PLAN
 SCALE 1" = 20'-0"
 20 0 20

PROJECT NAME:	BARTON VILLAGE
PROJECT NUMBER:	BO 1449(33)
FILE NAME:	z13j078ero.dgn
PROJECT LEADER:	J. OLUND
DESIGNED BY:	B. TOOTHAKER
EPSC EXISTING SITE PLAN	
PLOT DATE:	7/26/2016
DRAWN BY:	B. TOOTHAKER
CHECKED BY:	J. OLUND
SHEET	48 OF 110

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