


150A - PEACHAM MUCK  
WITH 0-8% SLOPES  
"K FACTOR" = 0.28

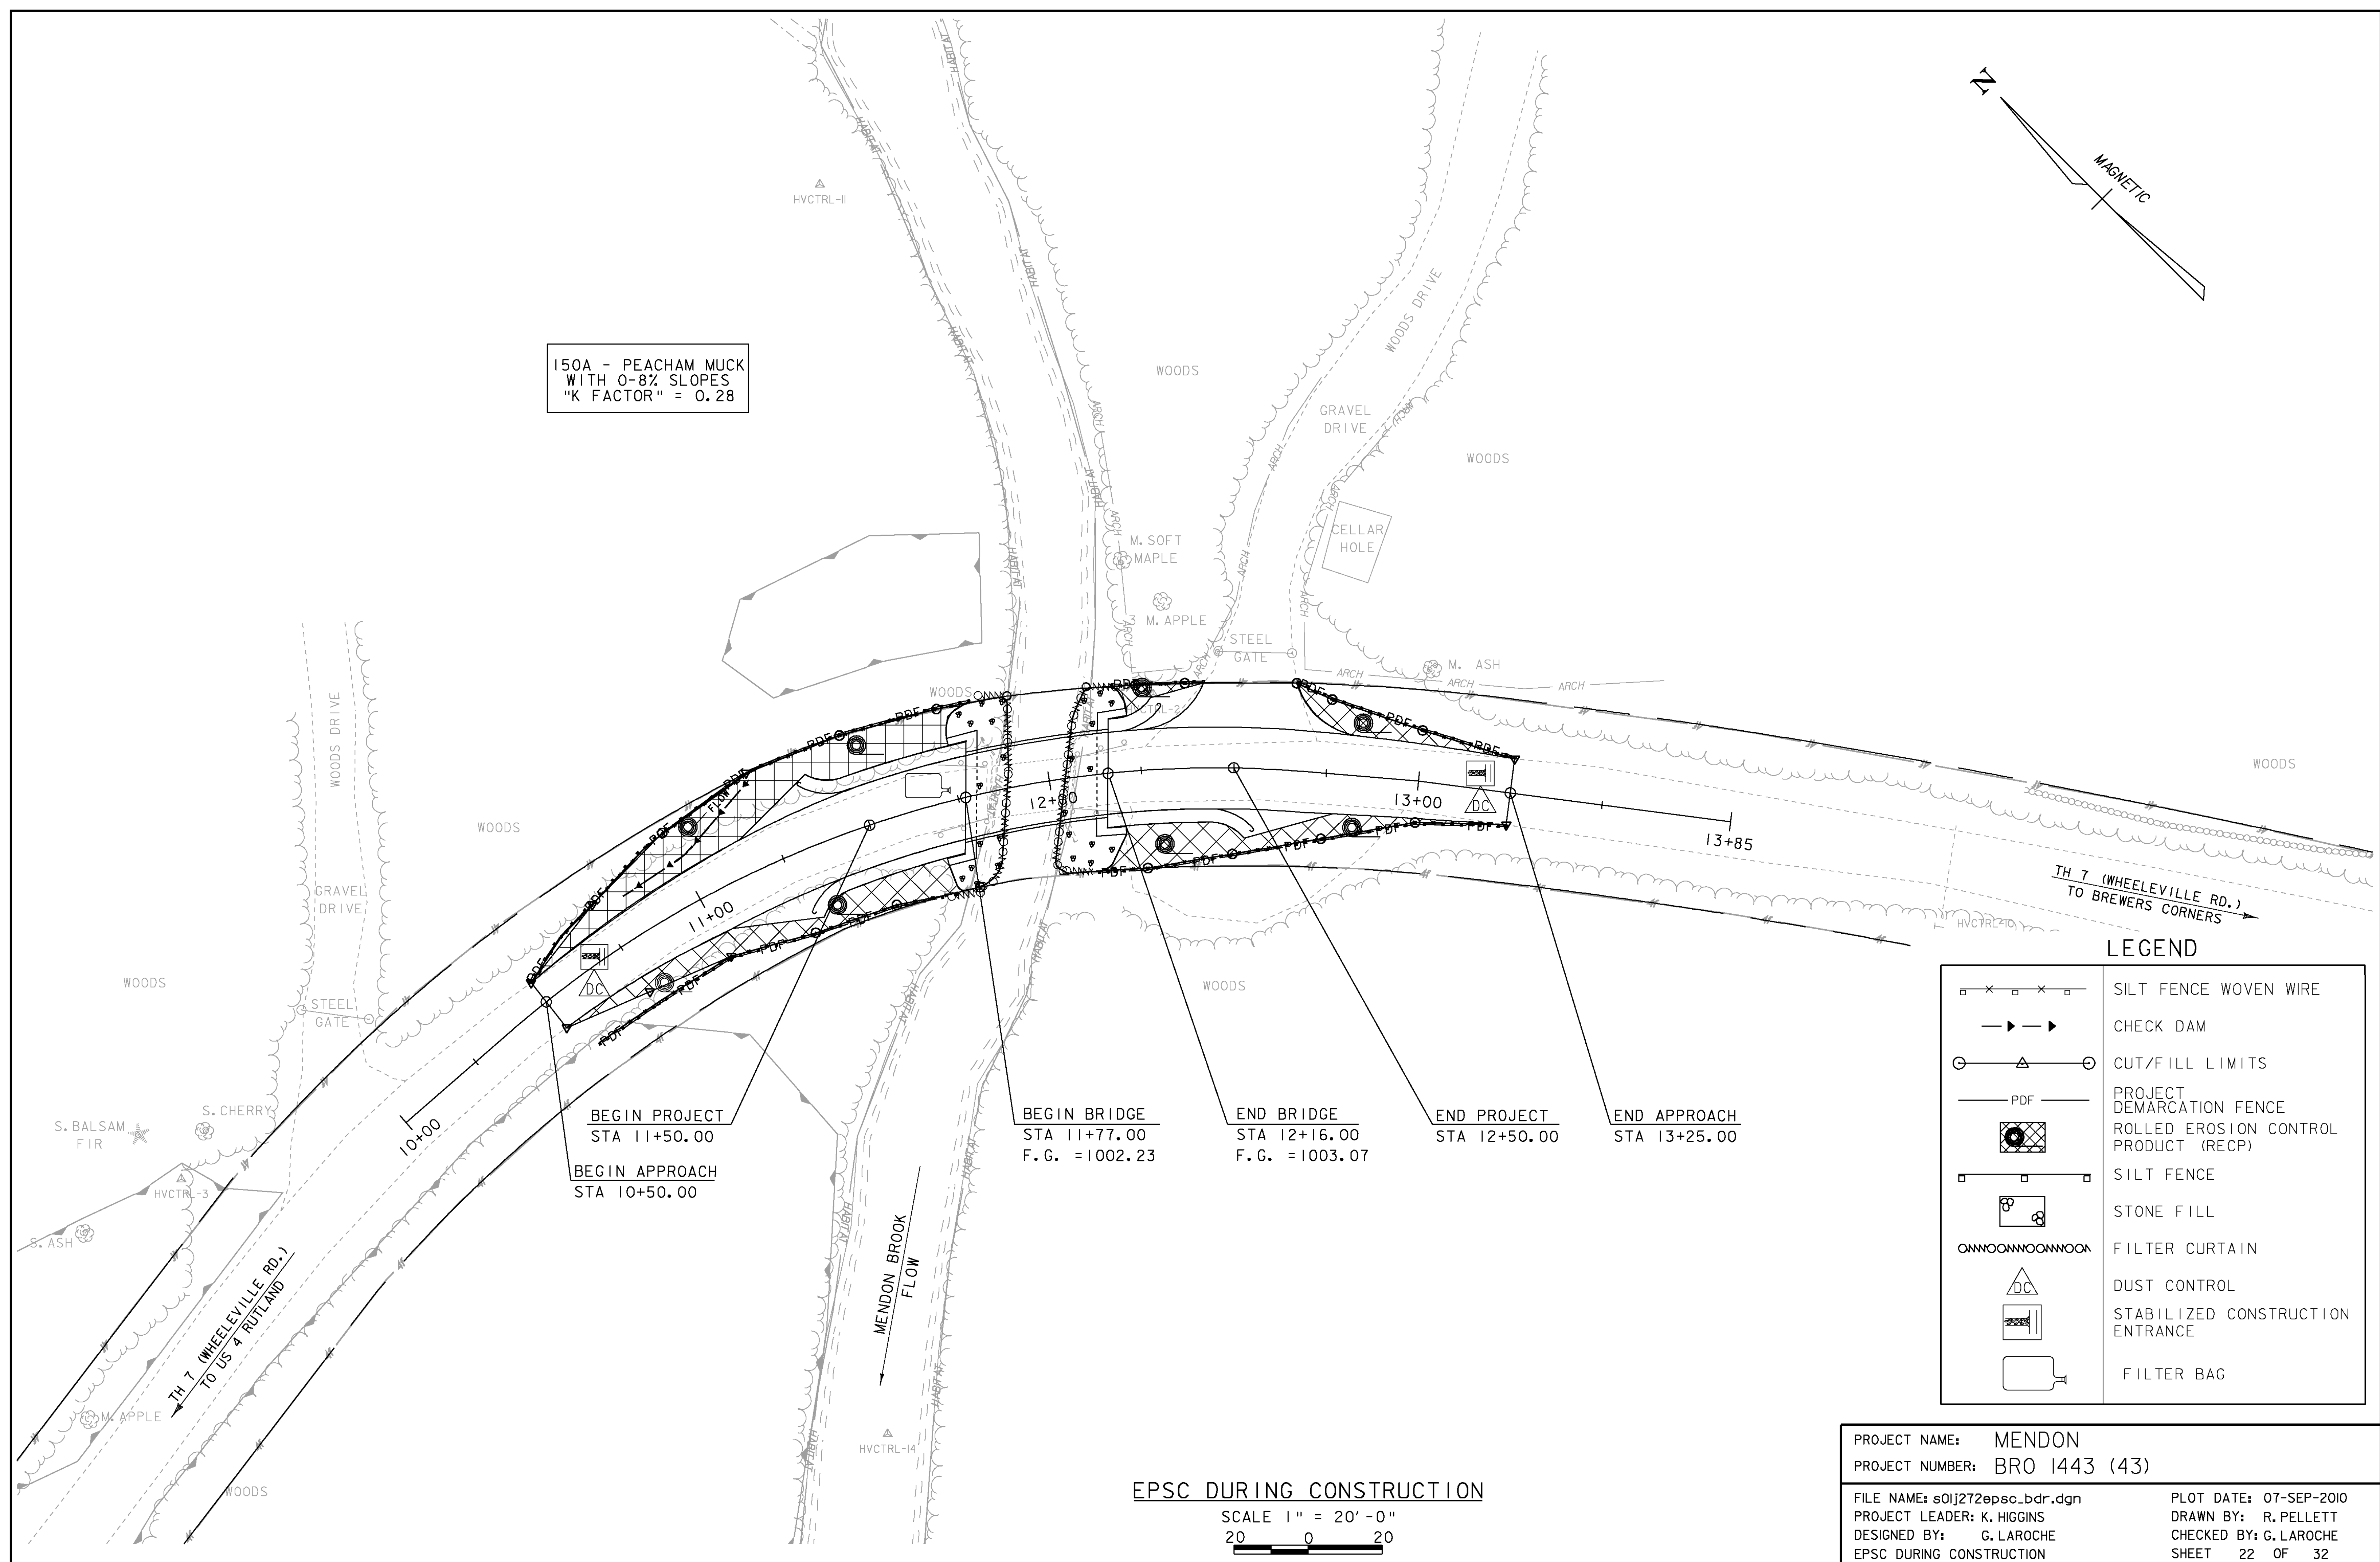

**LEGEND**

|  |                                       |
|--|---------------------------------------|
|  | SILT FENCE WOVEN WIRE                 |
|  | CHECK DAM                             |
|  | CUT/FILL LIMITS                       |
|  | PROJECT DEMARCATION FENCE             |
|  | ROLLED EROSION CONTROL PRODUCT (RECP) |
|  | SILT FENCE                            |
|  | STONE FILL                            |
|  | FILTER CURTAIN                        |
|  | DUST CONTROL                          |
|  | STABILIZED CONSTRUCTION ENTRANCE      |
|  | FILTER BAG                            |

BEGIN PROJECT  
STA 11+50.00  
BEGIN APPROACH  
STA 10+50.00

BEGIN BRIDGE  
STA 11+77.00  
F.G. = 1002.23

END BRIDGE  
STA 12+16.00  
F.G. = 1003.07

END PROJECT  
STA 12+50.00

END APPROACH  
STA 13+25.00

**EPSC DURING CONSTRUCTION**

SCALE 1" = 20'-0"  
20 0 20

|                                |                        |
|--------------------------------|------------------------|
| PROJECT NAME: MENDON           | PLOT DATE: 07-SEP-2010 |
| PROJECT NUMBER: BRO 1443 (43)  | DRAWN BY: R. PELLETT   |
| FILE NAME: s01j272epsc_bdr.dgn | CHECKED BY: G. LAROCHE |
| PROJECT LEADER: K. HIGGINS     | SHEET 22 OF 32         |
| DESIGNED BY: G. LAROCHE        |                        |
| EPSC DURING CONSTRUCTION       |                        |