

GEOTEXTILE FOR SILT FENCE
 STA. 33+80 TO 34+92, LT.
 STA. 34+99 TO 36+22, LT.
 STA. 36+27 TO 37+50, LT.
 STA. 2+10 TO 2+34, RT.
 STA. 2+79 TO 3+32, RT.
 STA. 3+66 TO 5+08, RT.

EROSION MATTING
 STA. 0+13 TO 3+44, RT.
 STA. 0+25 TO 5+97, LT.
 STA. 20+20 TO 24+69, RT.

GEOTEXTILE FOR SILT FENCE (INLET PROTECTION)
 STA. 2+74, RT.
 STA. 21+45, RT.

STONE OUTLET PROTECTION
 STA. 37+48 TO 37+49, LT.
 STA. 37+74 TO 37+82, LT.

STONE LINED PILOT CHANNEL
 STA. 34+15 TO 35+62, LT.

STONE CHECK DAMS
 STA. 35+64, LT.
 STA. 36+63, LT.
 STA. 1+00, RT.
 STA. 1+87, RT.

SNOW FENCE (MOD.-PDF)
 STA. 38+58, RT. TO 40+50, LT. (507')
 STA. 3+88, RT. TO 32+06, LT. (1033')


SNOW FENCE (MOD.-ARCH)
 STA. 2+43, RT. TO 3+88, LT. (147')
 STA. 35+65, RT. TO 38+55, LT. (466')

NOTES:

1. PLACE CONSTRUCTION FENCE OUTSIDE LIMITS OF CONSTRUCTION.
2. CONSTRUCTION FENCE TO BE PAID FOR UNDER 620.70 - SNOW FENCE (MOD.-PDF)
3. CONSTRUCTION FENCE SHALL BE PLACED IN A MANNER TO PROTECT WETLANDS FROM CONSTRUCTION ACTIVITIES.
4. ALL DRAINAGE PIPES CONSTRUCTED IN PHASE 1 SHALL BE TERMINATED AND CAPPED PRIOR TO BEGINNING PHASE 2 CONSTRUCTION.

MATCHLINE - SEE EPSC PLAN 3

EROSION CONTROL LEGEND	
	EROSION MATTING
	STONE LINED PILOT CHANNEL
	SILT FENCE
	CULVERT INLET PROTECTION
	ROCK BARRIER INLET PROTECTION
	STONE CHECK DAMS
	STONE OUTLET PROTECTION
	VEHICLE TRACKING PAD
	SNOW FENCE (MOD.-PDF)
	SNOW FENCE (MOD.-ARCH)

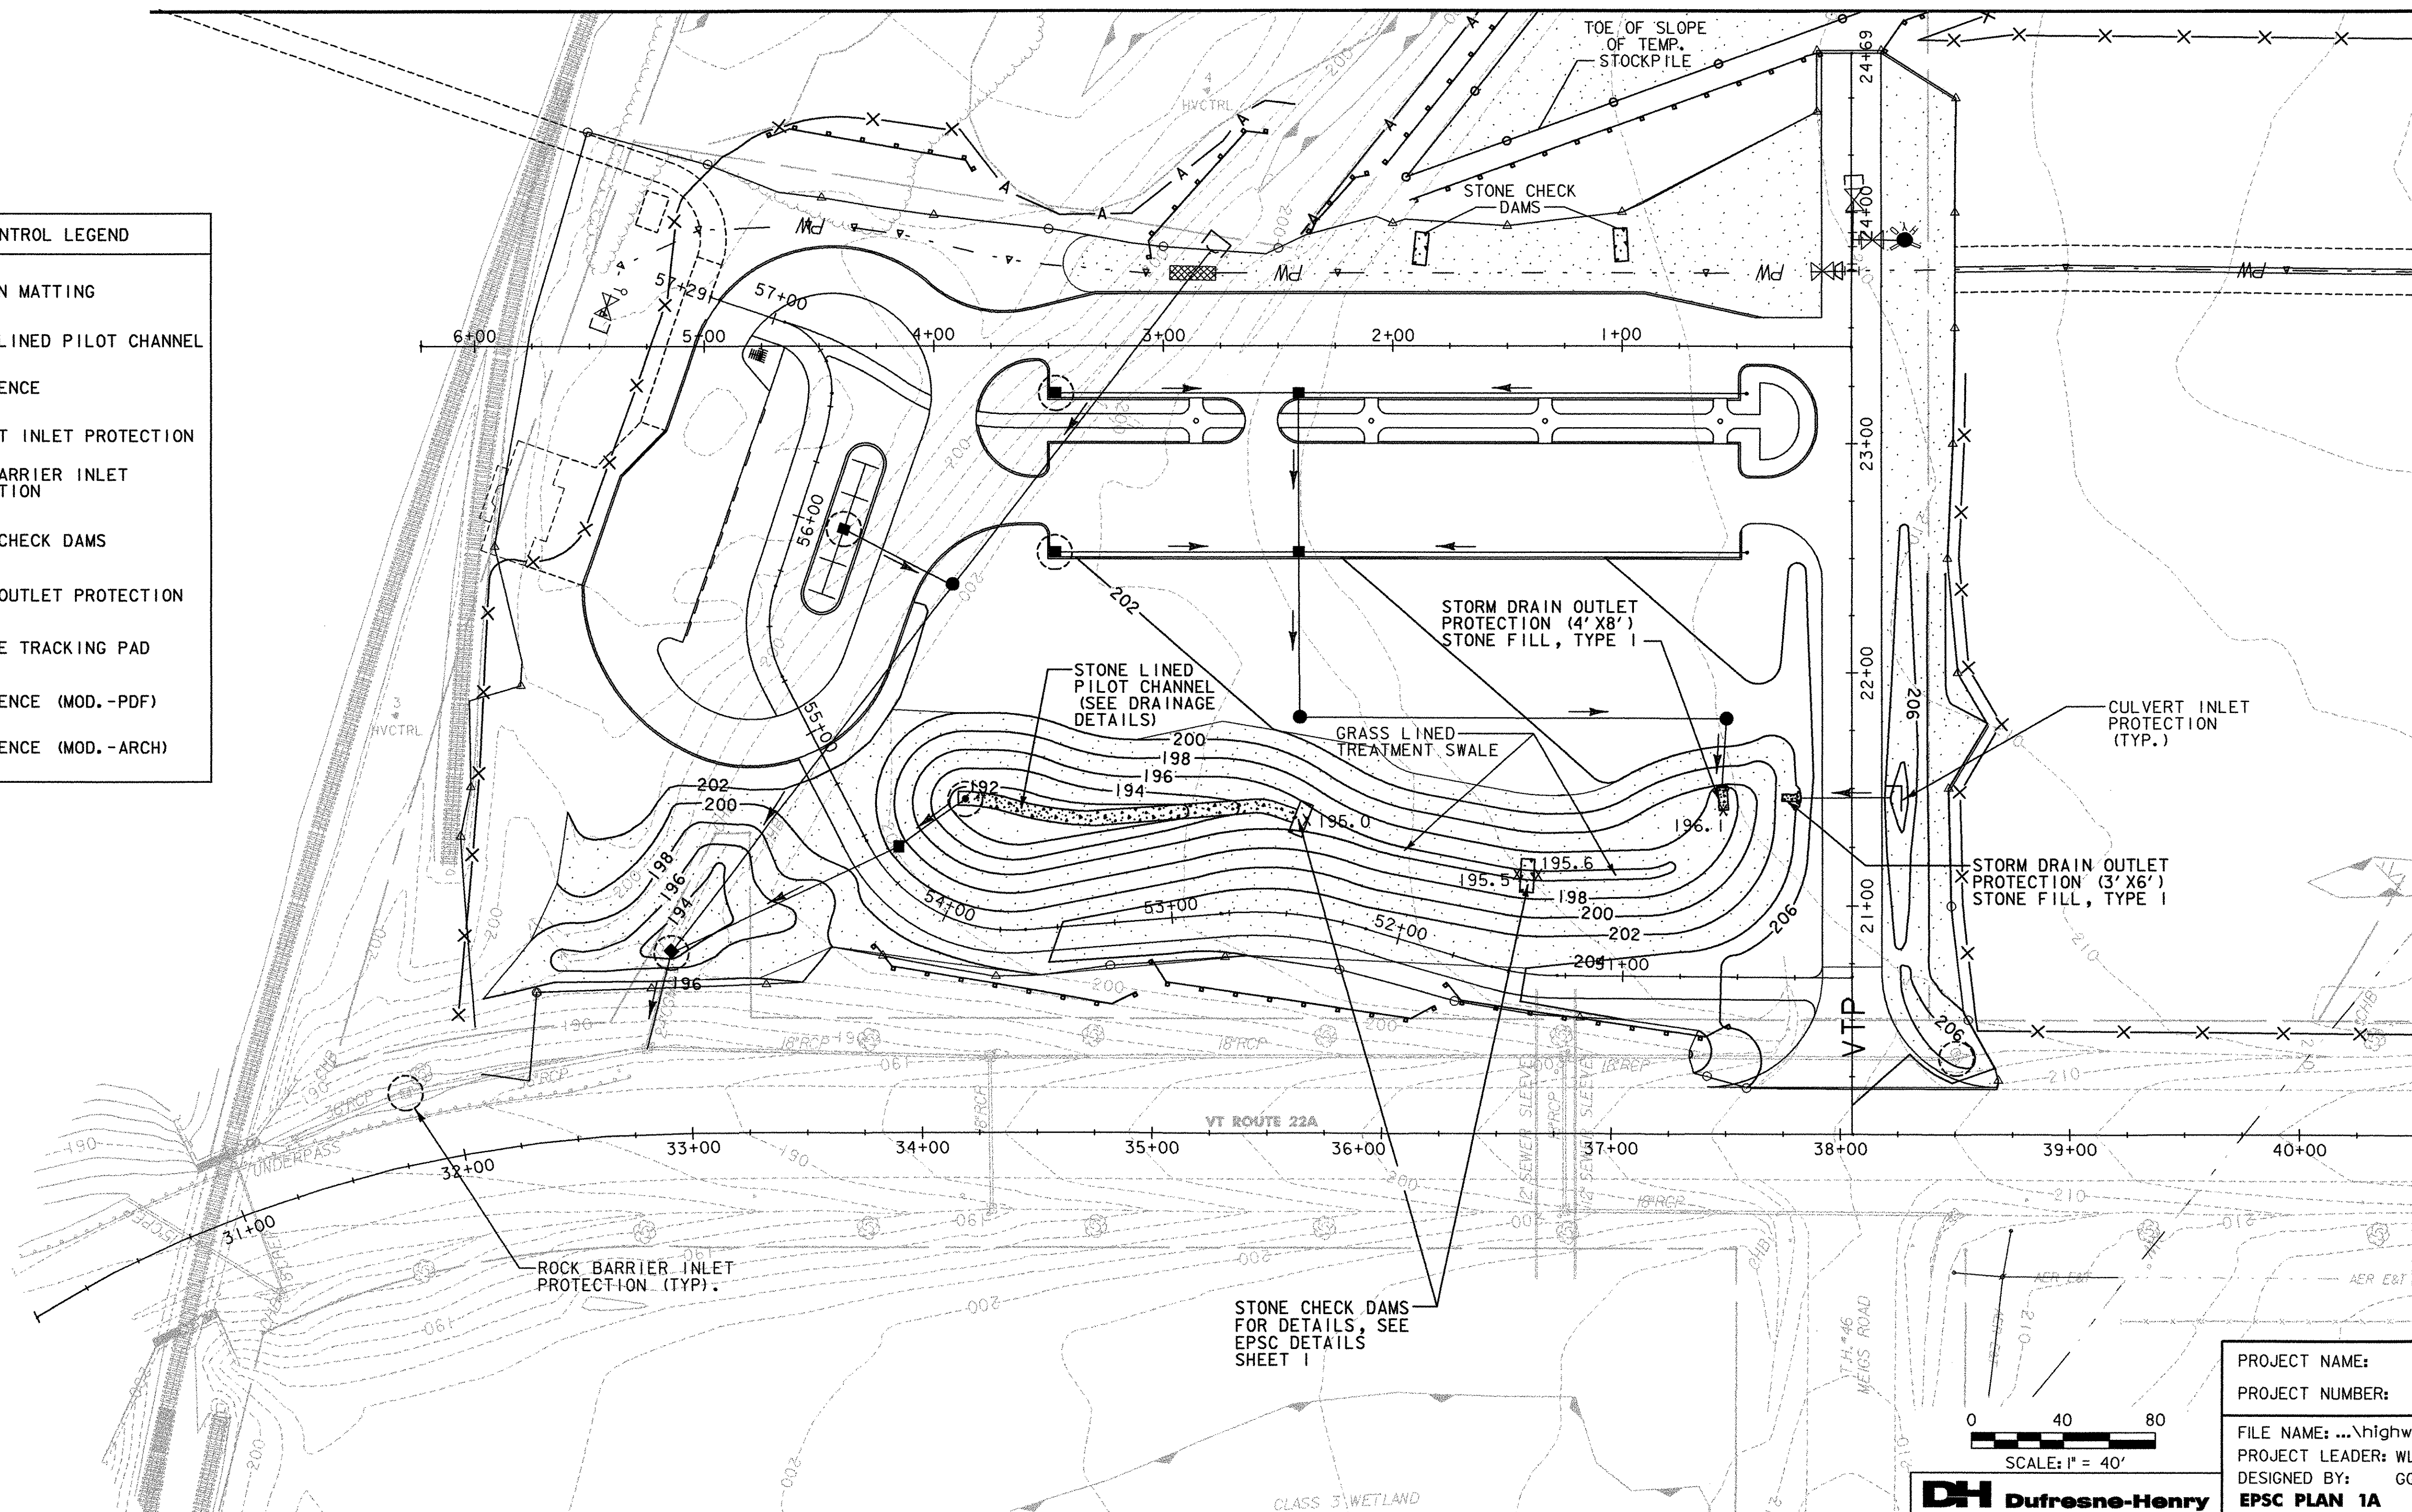

MATCHLINE STA. 40+50 - SEE EPSC PLAN 2

PROJECT NAME: FERRISBURGH/VERGS-FERRISBURGH	
PROJECT NUMBER: CMG PARK (15)S/STP EHO(2)	
FILE NAME: ...hghwy\PlotFiles\58epscla.p	DATE: 4/19/2006
PROJECT LEADER: WLD	DRAWN BY: MBL/SRZ
DESIGNED BY: GGG	CHECKED BY: GAS
EPSC PLAN 1A	SHEET 58 OF 65

0 40 80
 SCALE: 1" = 40'

