


**EROSION CONTROL LAYOUT**  
SCALE 1" = 10'-0"

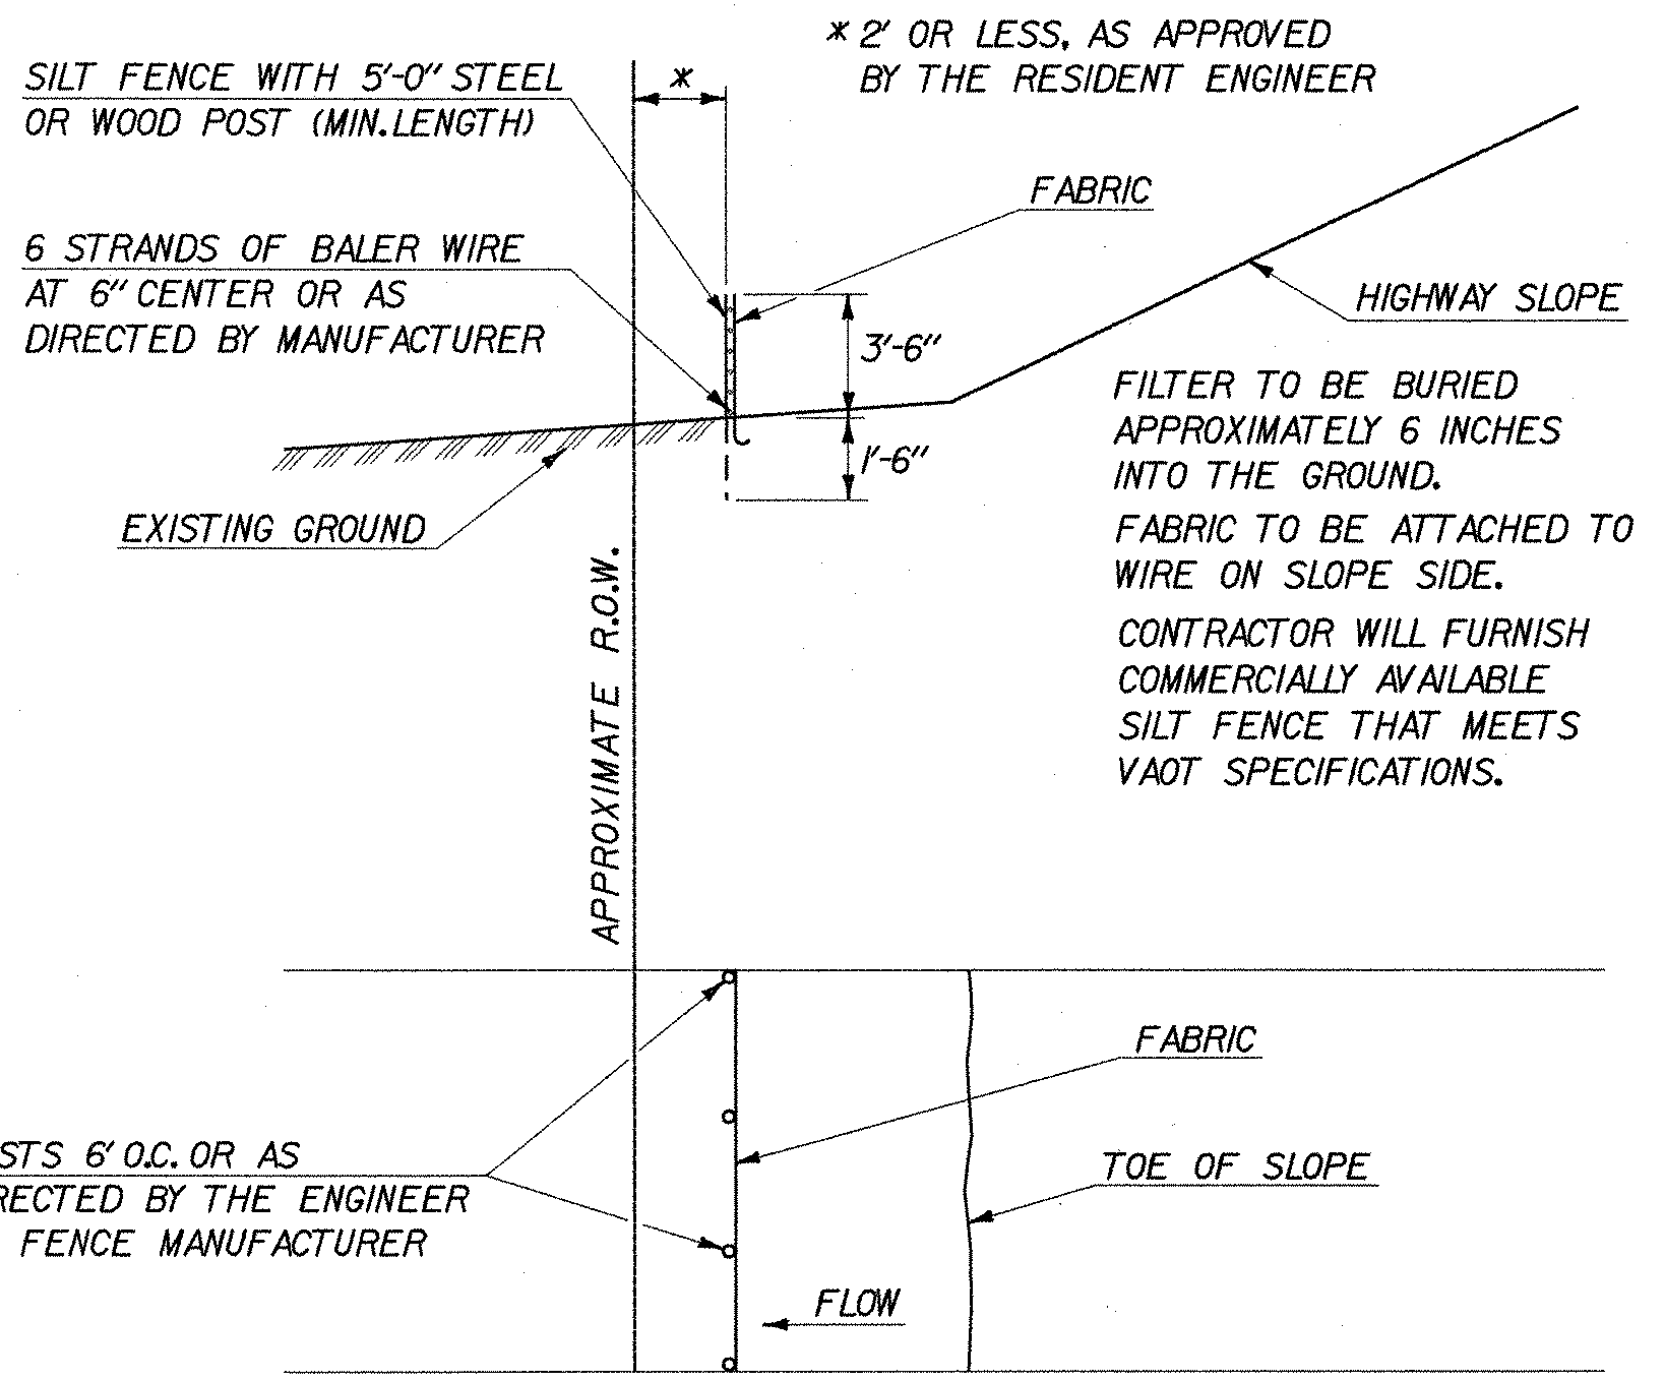


**SILT FENCE DETAIL**  
NOT TO SCALE

**NOTES**

1. THE EROSION CONTROL MEASURES SHOWN ON THIS SHEET ARE FOR ILLUSTRATIVE PURPOSES ONLY. THE ACTUAL EROSION CONTROL PLAN SHALL BE BASED ON EXISTING FIELD CONDITIONS AND SUBMITTED BY THE CONTRACTOR FOR APPROVAL TO THE REGIONAL CONSTRUCTION ENGINEER AND STREAM ALTERATION ENGINEER. PAYMENT FOR THE DEVELOPMENT OF THE EROSION CONTROL PLAN SHALL BE INCLUDED IN ITEM 652.10, EROSION AND SEDIMENT CONTROL PLAN.
2. THE CONTRACTOR'S ATTENTION IS DIRECTED TO THE FACT THERE WILL BE AREAS WHERE THE LOCATION OF THE SILT FENCE WILL BE IN CLOSE PROXIMITY TO THE LIMITS OF THE PROPOSED TOES OF SLOPE IN ORDER TO KEEP ALL WORK WITHIN THE EXISTING RIGHT-OF-WAY LIMITS. THE CONTRACTOR SHALL TAKE SPECIAL PRECAUTIONS TO HIGHLIGHT THE LOCATION OF THE SILT FENCE AND TO AVOID DAMAGING IT. SPECIAL DETAILS FOR SILT FENCE MAY BE REQUIRED IN THESE AREAS AND SHALL BE INCLUDED WITH THE SUBMITTAL OF THE EROSION AND SEDIMENT CONTROL PLAN. A SAMPLE DETAIL IS INCLUDED ON THIS SHEET FOR REFERENCE PURPOSES.
3. MONITORING AND MAINTAINING THE EROSION AND SEDIMENT CONTROL PLAN SHALL BE PER ITEM 652.20, MONITORING EROSION AND SEDIMENT CONTROL PLAN AND ITEM 652.30, FIELD MAINTENANCE OF EROSION AND SEDIMENT CONTROL PLAN.

**LEGEND**

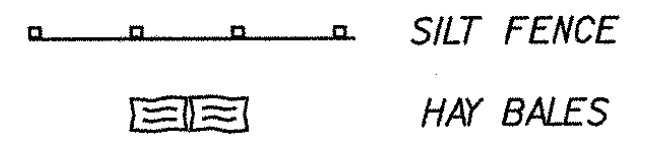

|   |                              |                          |              |
|---|------------------------------|--------------------------|--------------|
| <b>STATE OF VERMONT<br/>AGENCY OF TRANSPORTATION</b>                |                              |                          |              |
| Town Of   | LYNDON                       | Bridge No.               | 2            |
| Highway No.   | ALT VT 122                   | Log Sta.                 |              |
|   |                              | Surv. Sta.               |              |
| <b>CENTER STREET OVER PASSUMPSIC RIVER<br/>EROSION CONTROL PLAN</b> |                              |                          |              |
| Designed By   | R. JOY                       | Drawn By                 | S. MERKMAN   |
| Checked By  | E. WEINGARTNER               | Date                     | 10/03        |
|   |                              | Bridge Design Supervisor | M. ZYDEL     |
|   |                              | Date                     | 10/03        |
| PROJECT   | LYNDON                       | PROJECT NO.              | BHO 1447(26) |
| I.G.C. Info.  | m:\549103\6conf\z\238ecp.dgn |                          |              |
| Bridge Sheet No.  |                              | Sheet                    | 10 of 34     |

