



**GIRDER
OUTSIDE VIEW**
SCALE: 1:50

NOTE: EAST GIRDER SHOWN. WEST GIRDER SIMILAR, SEE FRAMING PLAN.

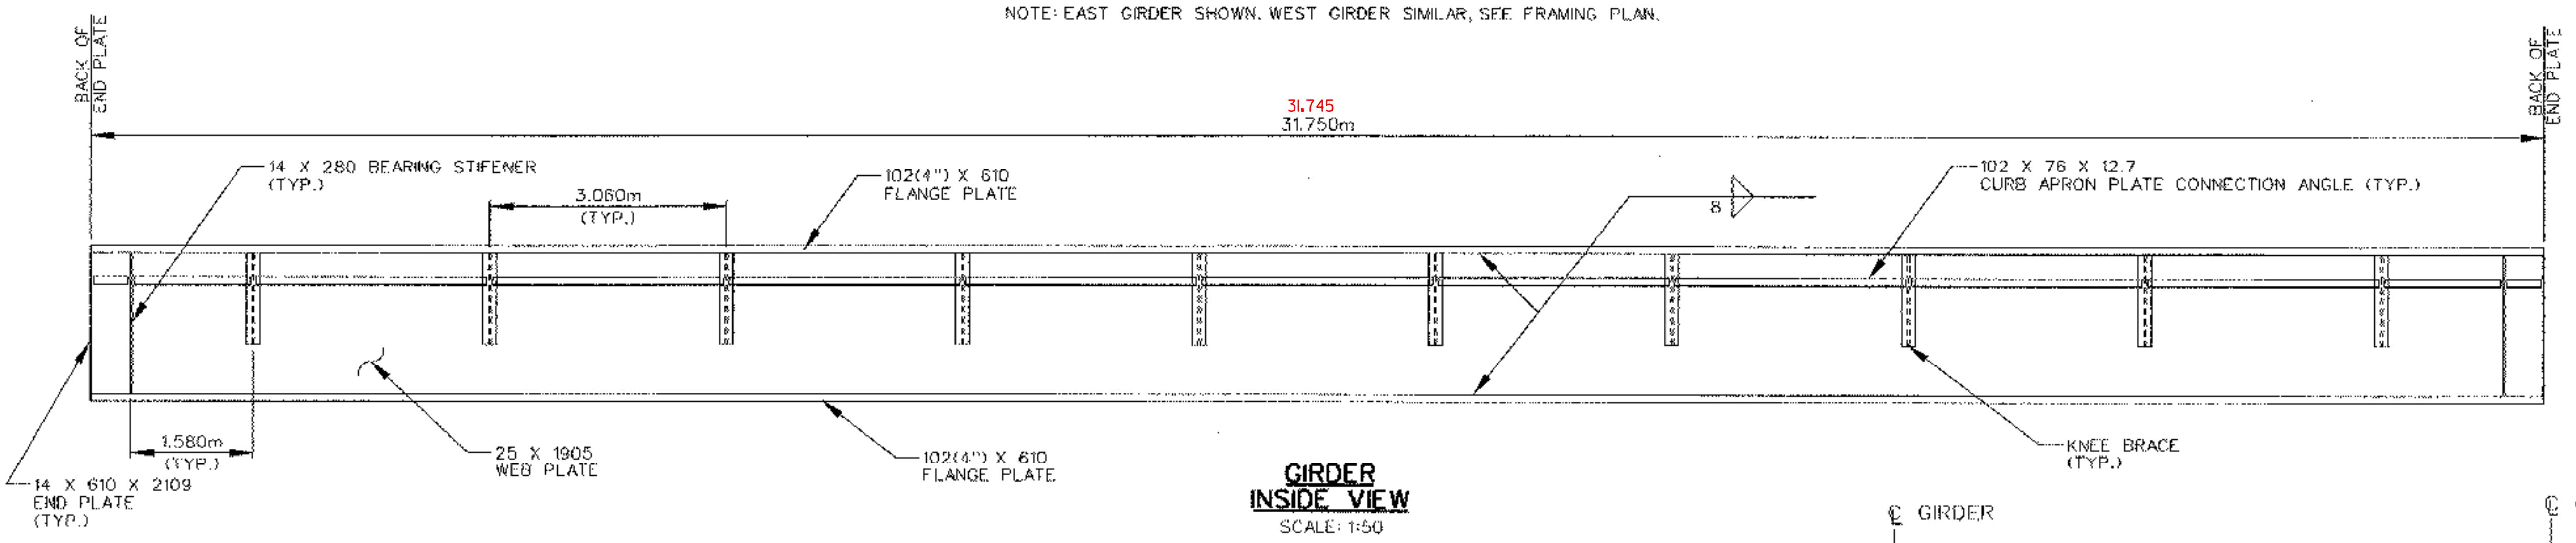


**GIRDER
INSIDE VIEW**
SCALE: 1:50

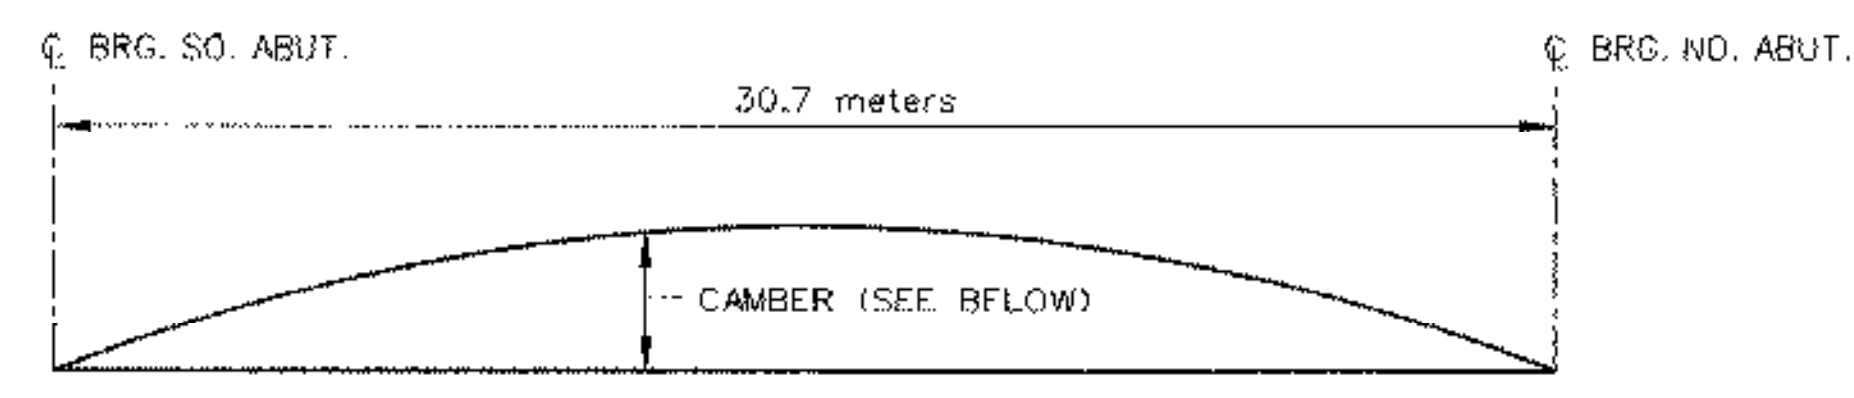

GIRDER CAMBER									
GIRDER	SO. BRG.	1/8 PT.	1/4 PT.	3/8 PT.	1/2 PT.	5/8 PT.	3/4 PT.	7/8 PT.	NO. BRG.
EAST	0	10	19	24	26	24	19	10	0
WEST	0	10	19	24	26	24	19	10	0


* CAMBER SHOWN IN mm

GIRDER CAMBER TABLE
SCALE: 1:50

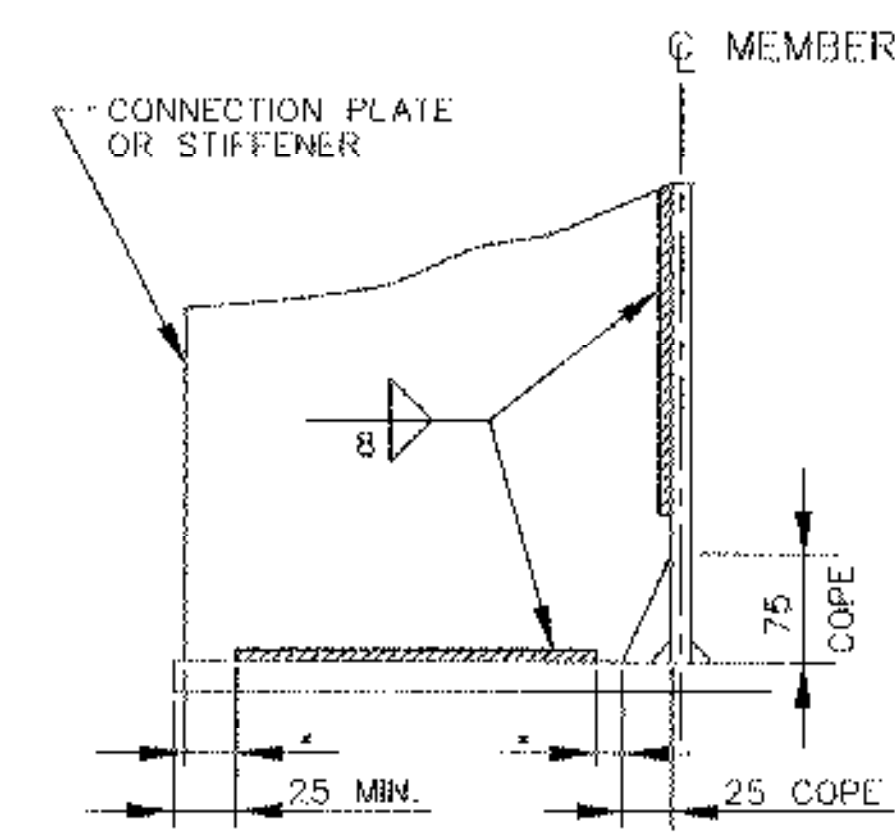


WELD TERMINATION DETAIL
N.T.S.


* NO WELD FOR 6 MIN. 12 MAX.
(EXCEPT MUST MAINTAIN 25 MINIMUM FROM EDGE OF FLANGE)

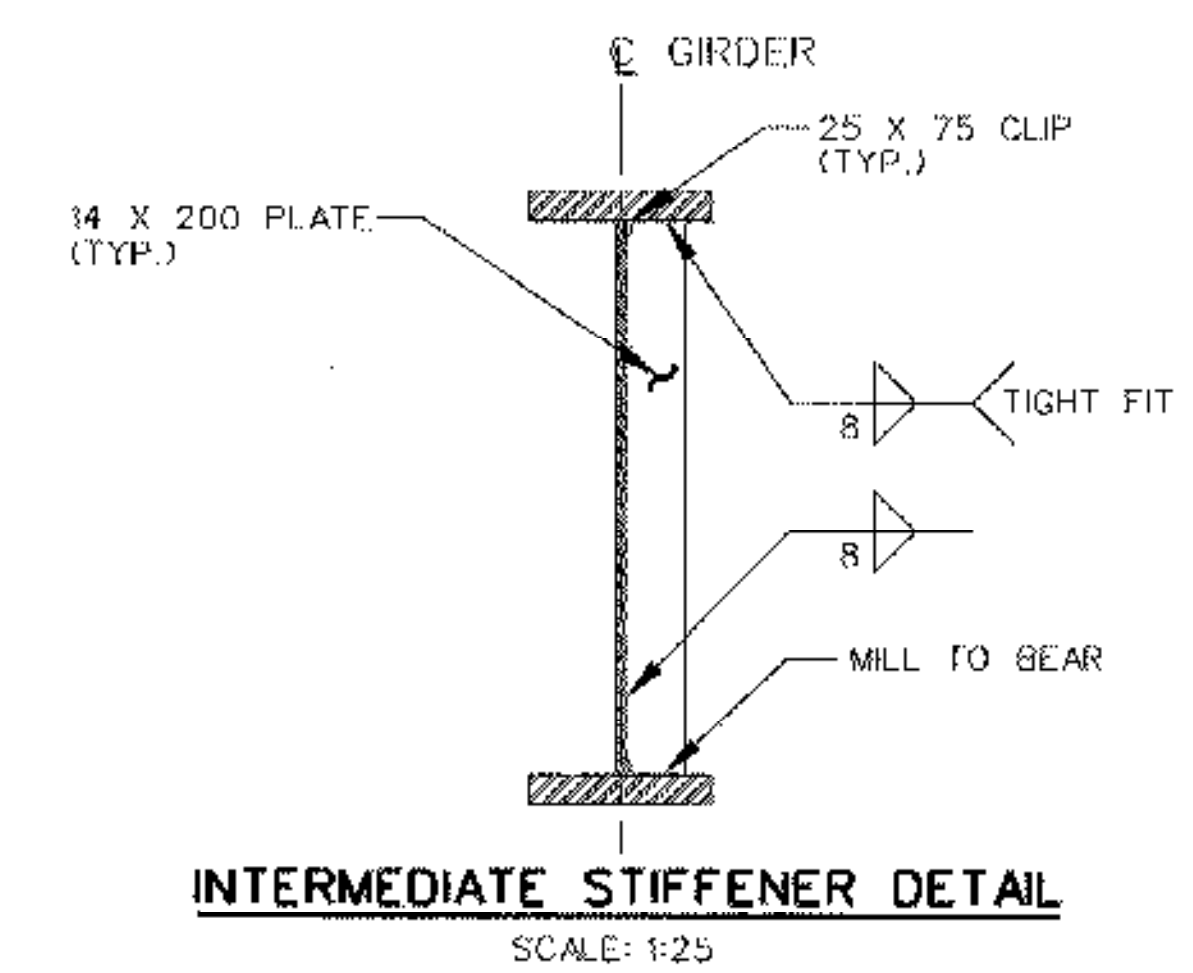

INTERMEDIATE STIFFENER DETAIL
SCALE: 1:25

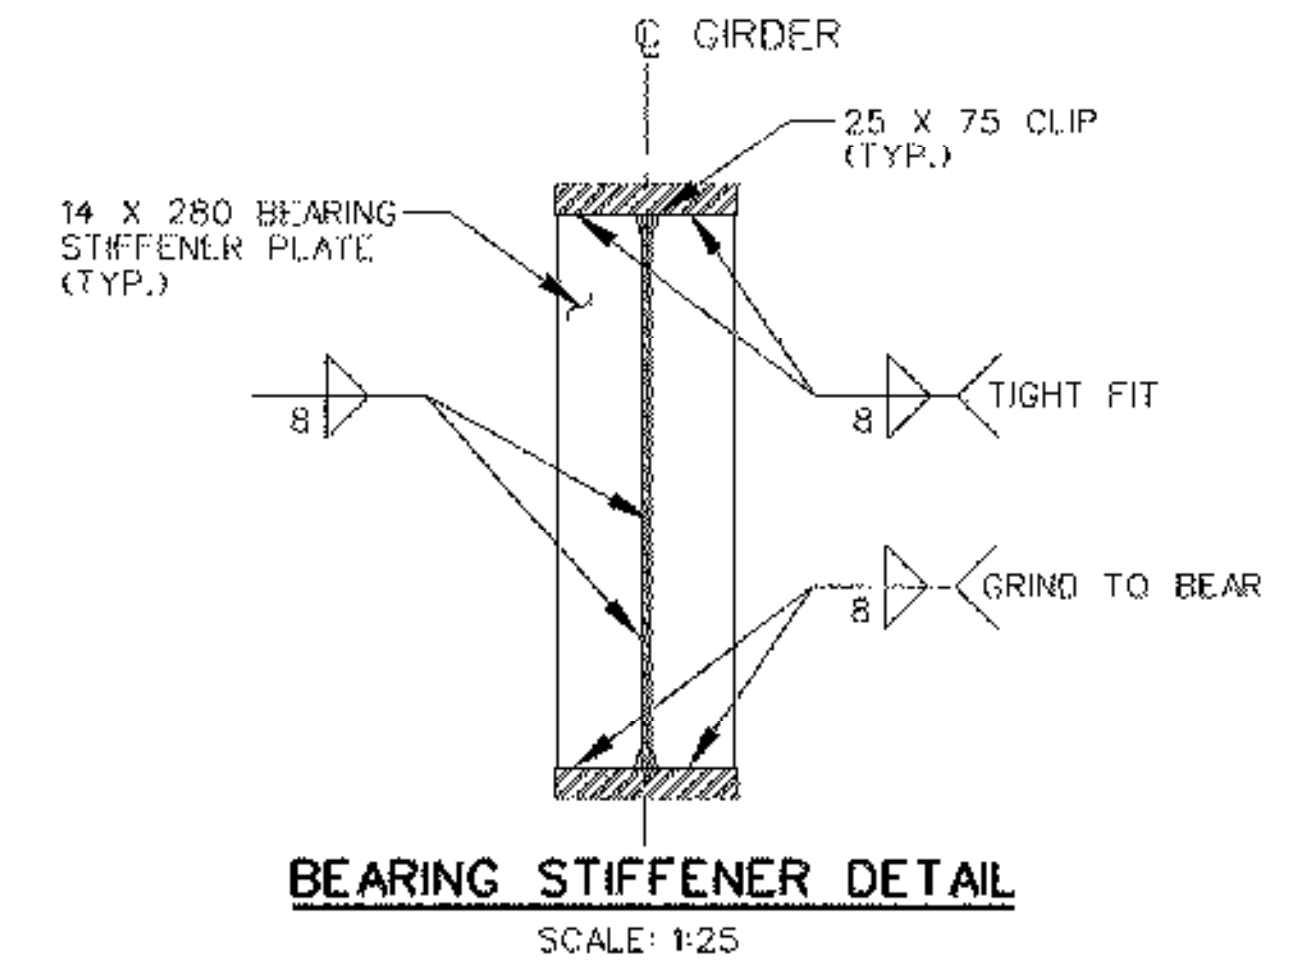

BEARING STIFFENER DETAIL
SCALE: 1:25

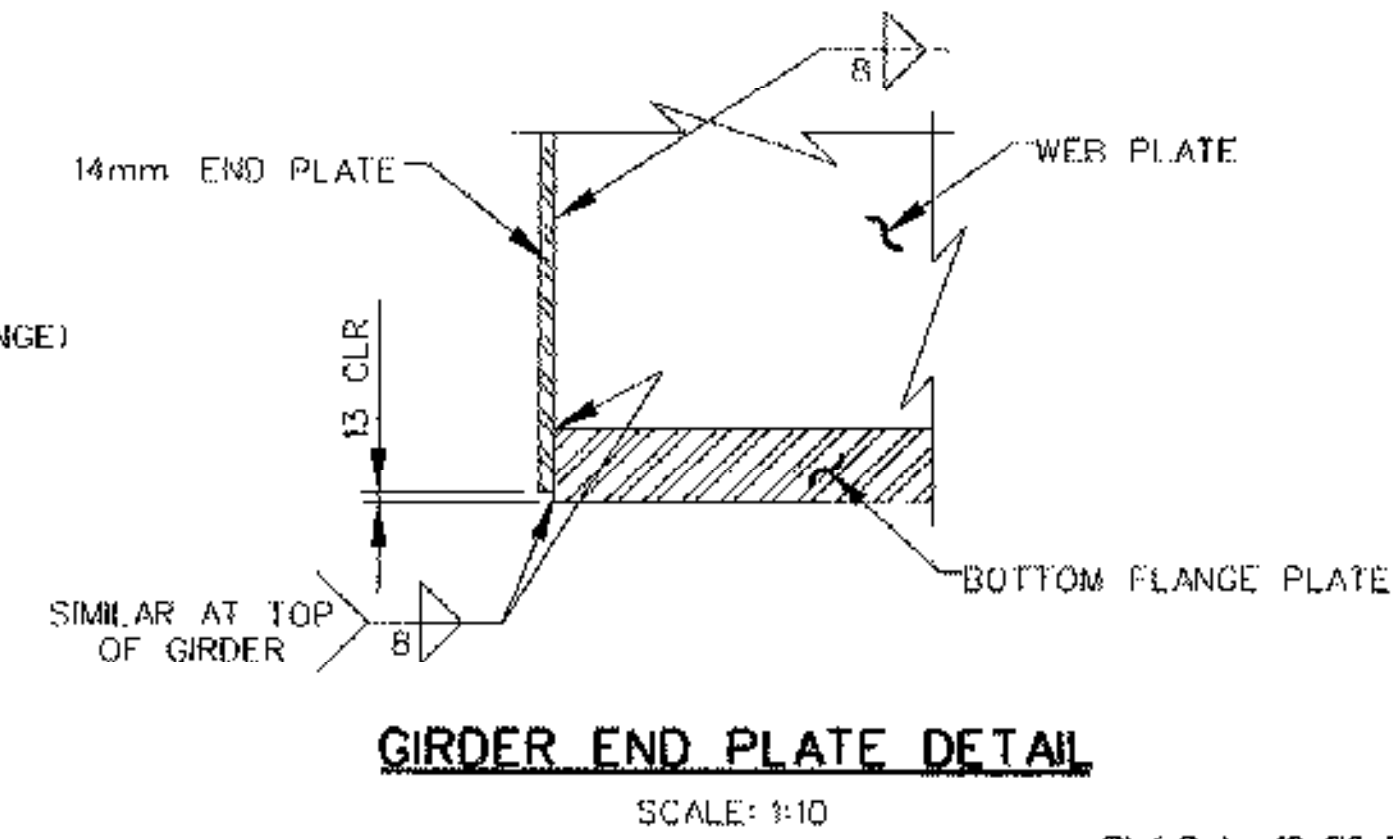

GIRDER END PLATE DETAIL
SCALE: 1:10

STATE OF VERMONT AGENCY OF TRANSPORTATION			
Town Of	BRATTLEBORO	Bridge No.	62.56
Highway No.	VT. ROUTE 9	Log Sta.	
		Surv. Sta.	
ROUTE 9 BRIDGE			
GIRDER ELEVATION, CAMBER & DETAILS			
Designed By	LM	Drawn By	DHL
Checked By	GJB	Bridge Design Supervisor	JHR
	Date	Date	
PROJECT	BRATTLEBORO	PROJECT NO.	NH 010-2(2)
I.G.C. Info.			
Bridge Sheet No. 3		Sheet 71 of 145	