


**SOIL CLASSIFICATION**  
 SOIL TYPE: PODUNK FINE SILTY LOAM  
 SLOPES: 0-3%  
 "K FACTOR" 0.24  
 CLASSIFIED: NOT HIGHLY ERODIBLE

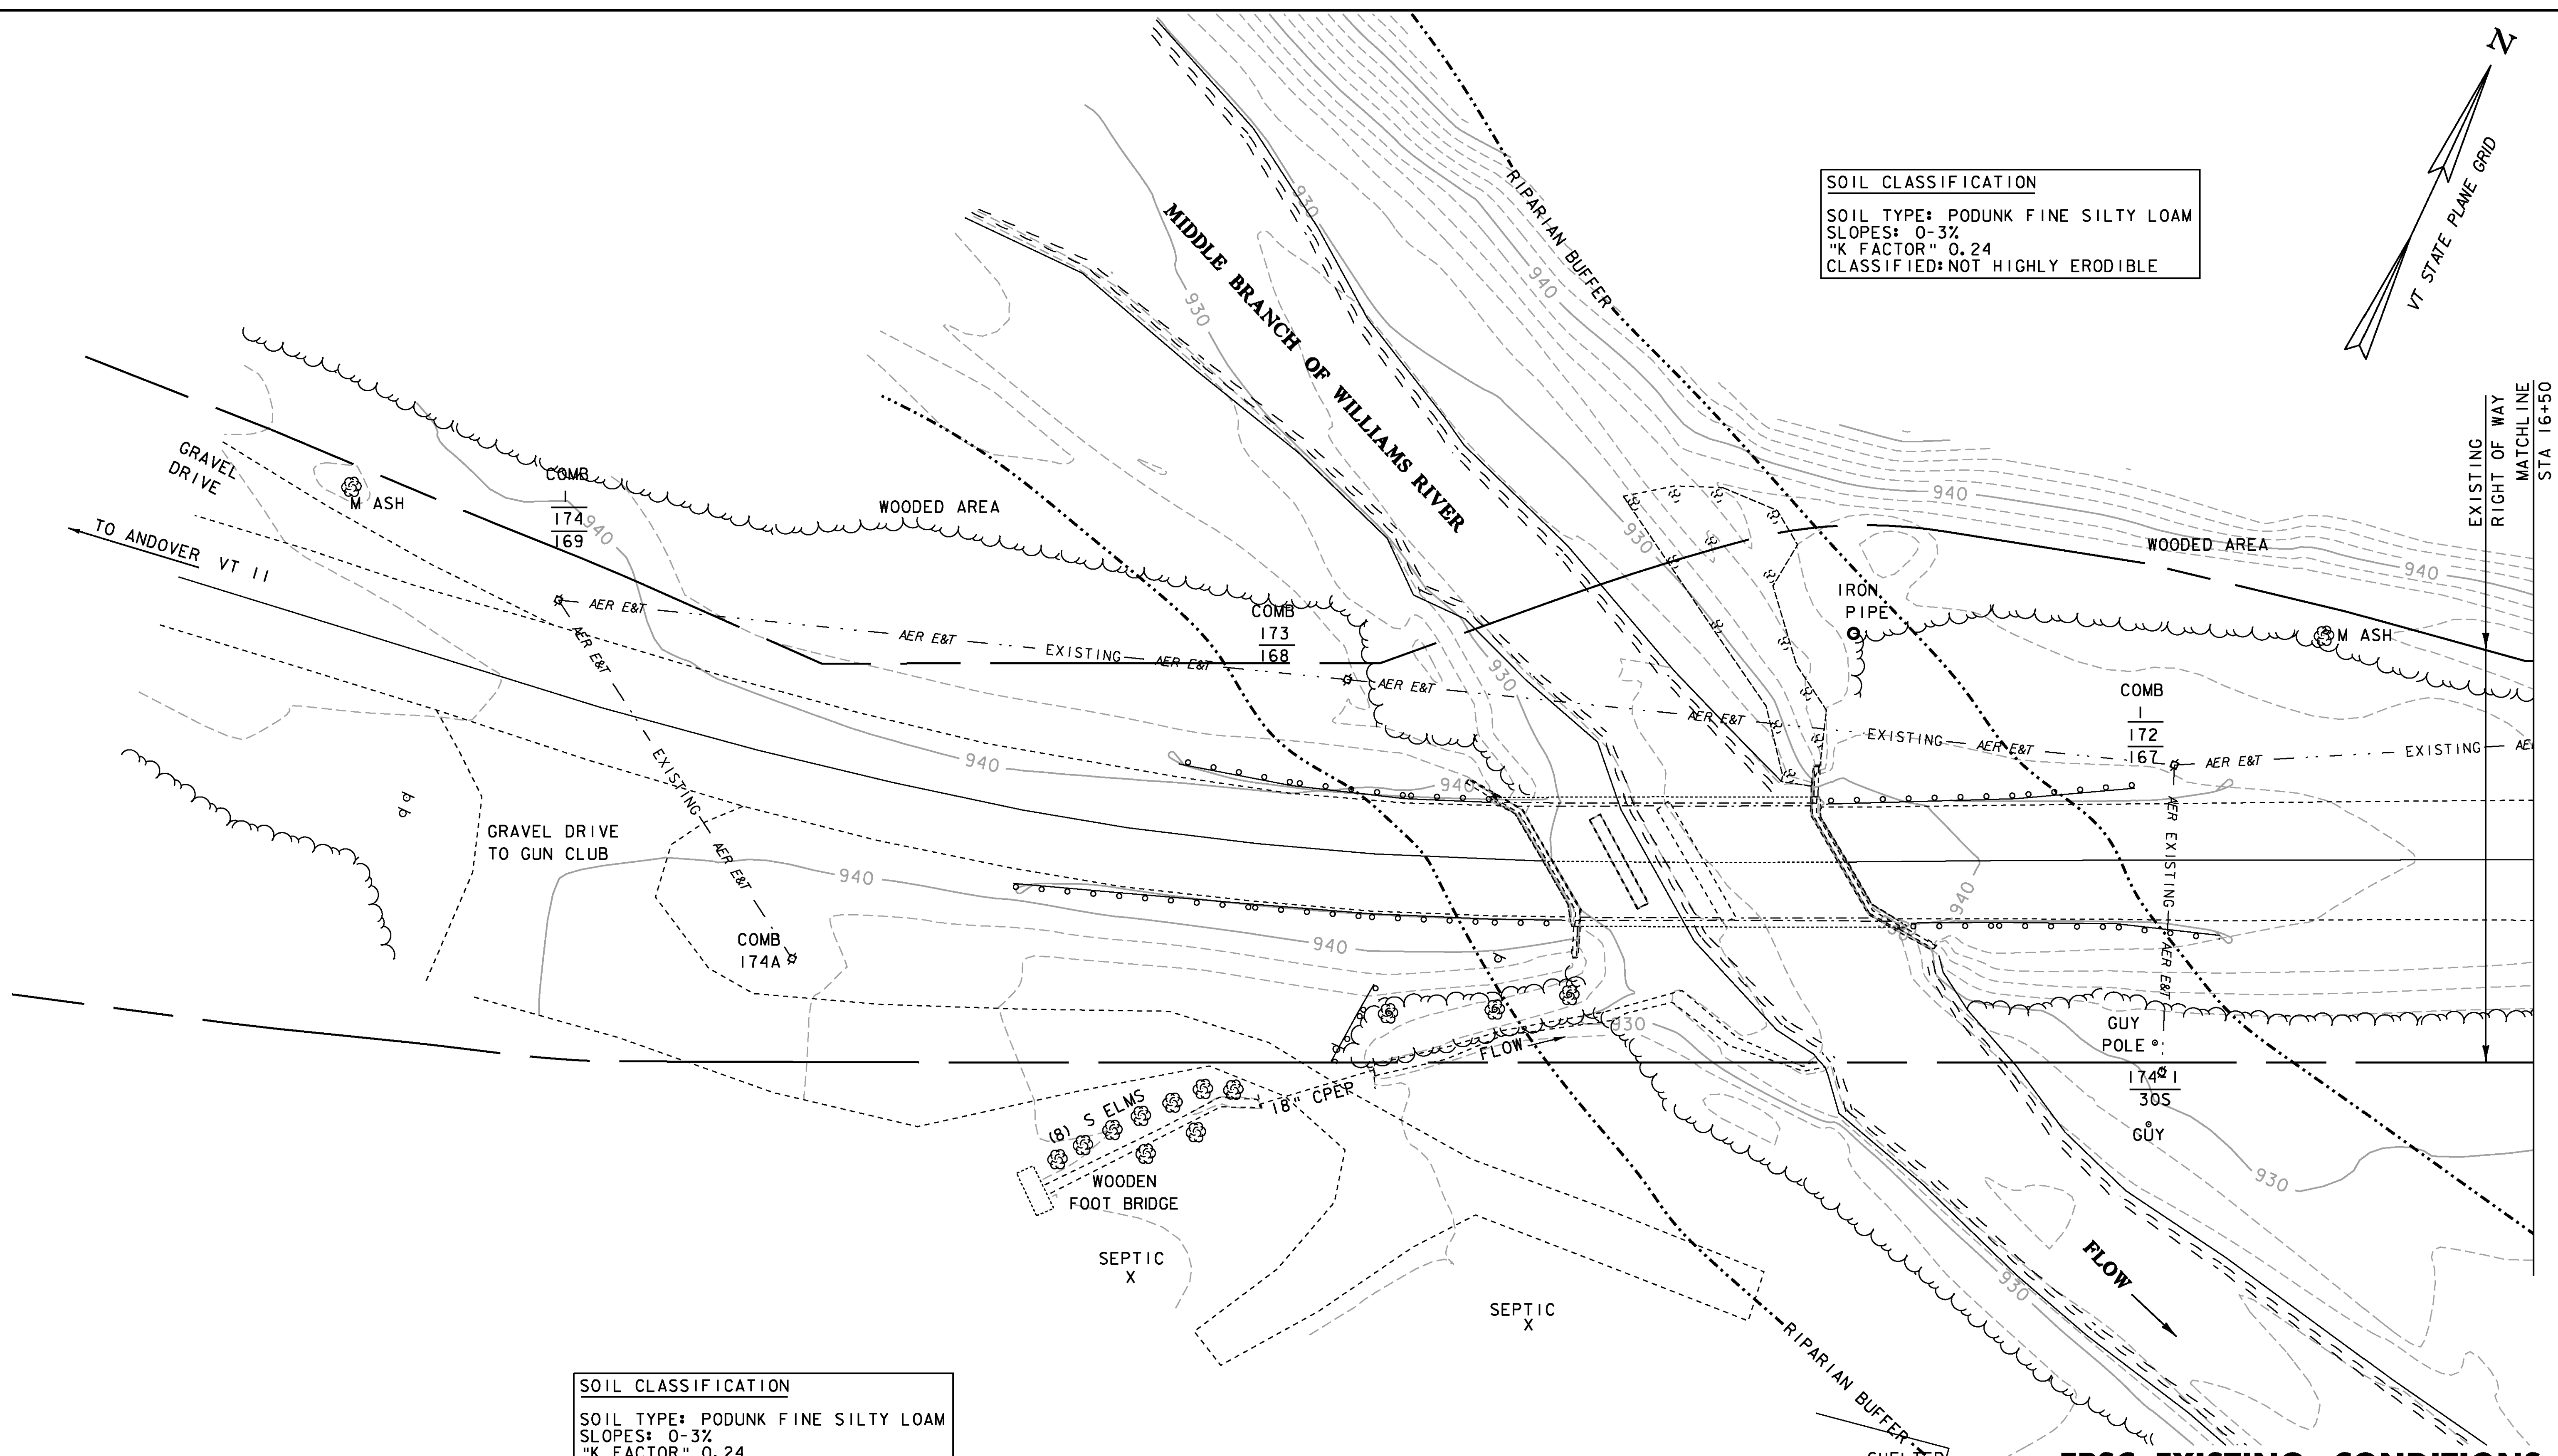

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**LEGEND**  
 --- AER E&T --- AERIAL ELECTRIC & TELEPHONE  
 - - - - - RIPARIAN BUFFER ZONE

**EPSC EXISTING CONDITIONS  
 SITE PLAN - SHEET 1**

**DATUM**  
 VERTICAL: NAVD 88  
 HORIZONTAL: NAD 83 (96)

SCALE 1" = 20'-0"  
 20 0 20

PROJECT: CHESTER	PROJECT NO.: BRF 016-1 (25)
DESIGN FILE NAME: s88b194/str/s88b194bdr_ero.dgn	PLOT DATE: 16-MAR-2011
IPARM FILE NAME: s88b194excon1.i	DESIGNED BY: E.L. RUSTAY
SQUAD LEADER: C.P. WILLIAMS	DRAWN BY: M. FESSEL
EPSC EXISTING CONDITIONS - SHEET 1	CHECKED BY: R.S. YOUNG
	SHEET: 36 OF 50