


**ROOF SYSTEM FRAMING PLAN**


SCALE 1/2" = 1'-0"

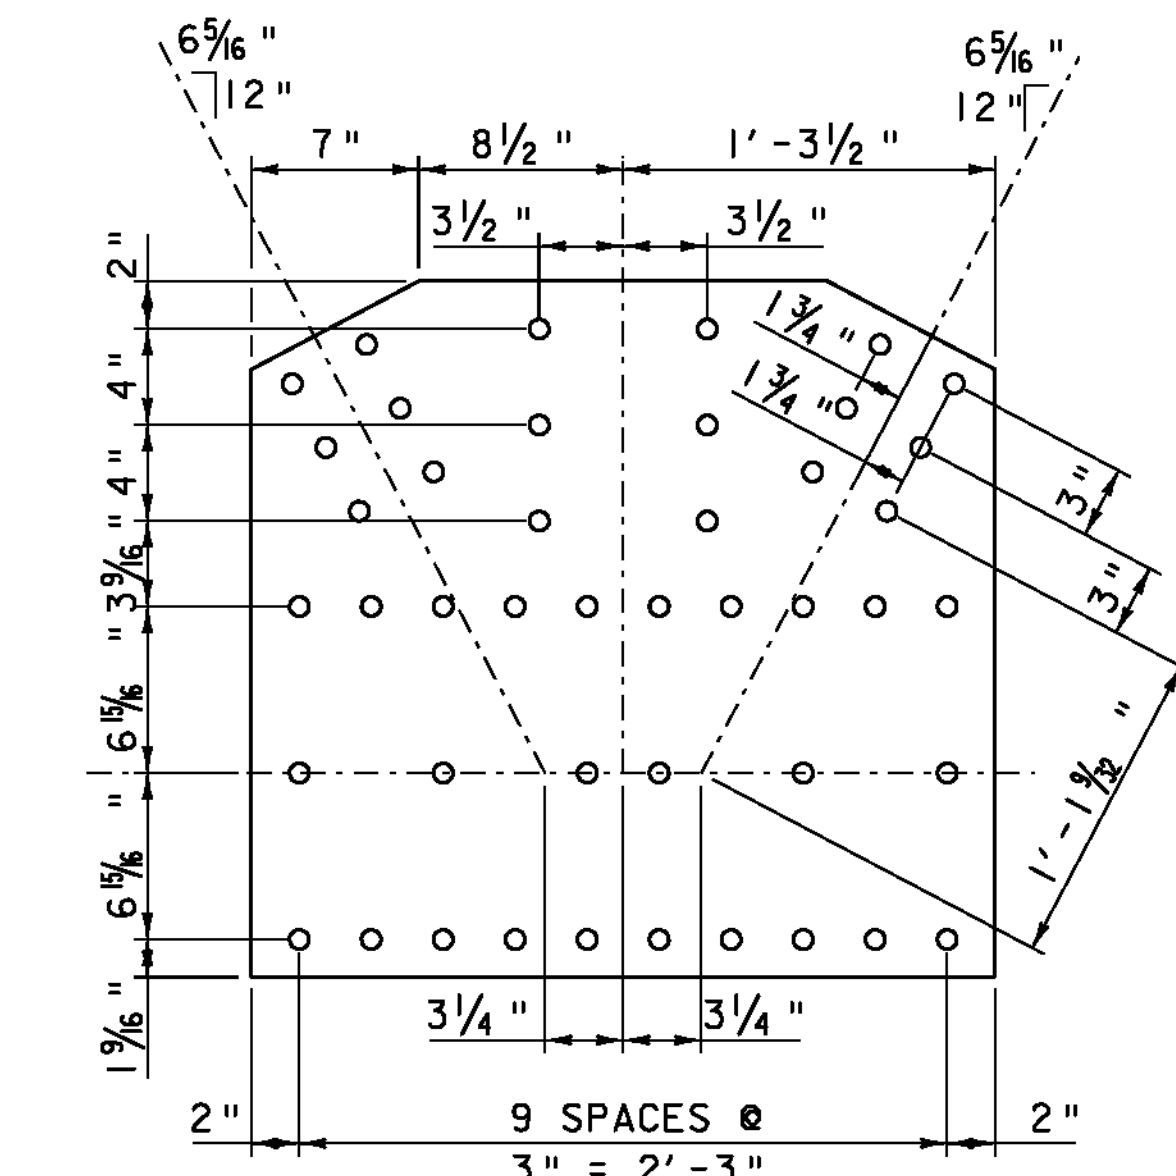

**TOP TYPICAL ROOF PLATE**

PL 5/16" x 29' x 2' - 7"


SCALE 1/2" = 1'-0"

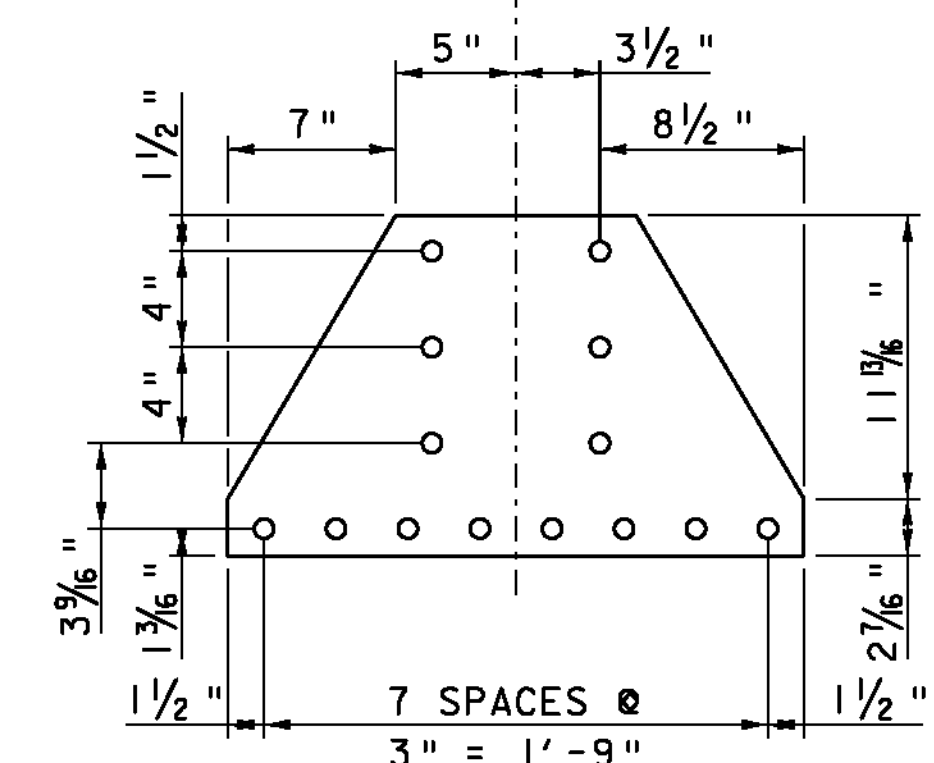

**BOTTOM TYPICAL ROOF PLATE**

PL 5/16" x 14<sup>1</sup>/<sub>4</sub>' x 2' - 0"

SCALE 1/2" = 1'-0"

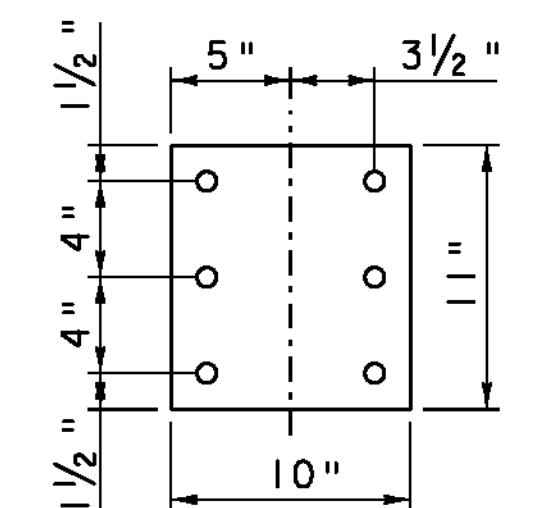

**ROOF FILLER PLATE**

PL 5/16" x 10' x 11"

SCALE 1/2" = 1'-0"

- NOTE:
1. HATCHED COMPONENTS ARE NEW
  2. 3/4" DIAMETER BOLTS IN 5/16" HOLE, UNLESS OTHERWISE NOTED.
  3. MINIMUM BOLT EDGE AND DISTANCE = 1/2", UNLESS OTHERWISE NOTED.

PROJECT NAME: BRIDGEWATER	PLOT DATE: 31-DEC-2009
PROJECT NUMBER: BRS 0149(4)	DRAWN BY: C. MOONEY
FILE NAME: s86e062roof.dgn	CHECKED BY: T. FILLBACH
PROJECT LEADER: K. HIGGINS	SHEET 29 OF 58
DESIGNED BY: T. FILLBACH	
ROOF FRAMING PLAN	