


FRAMING PLAN

SCALE 3/16" = 1'-0"

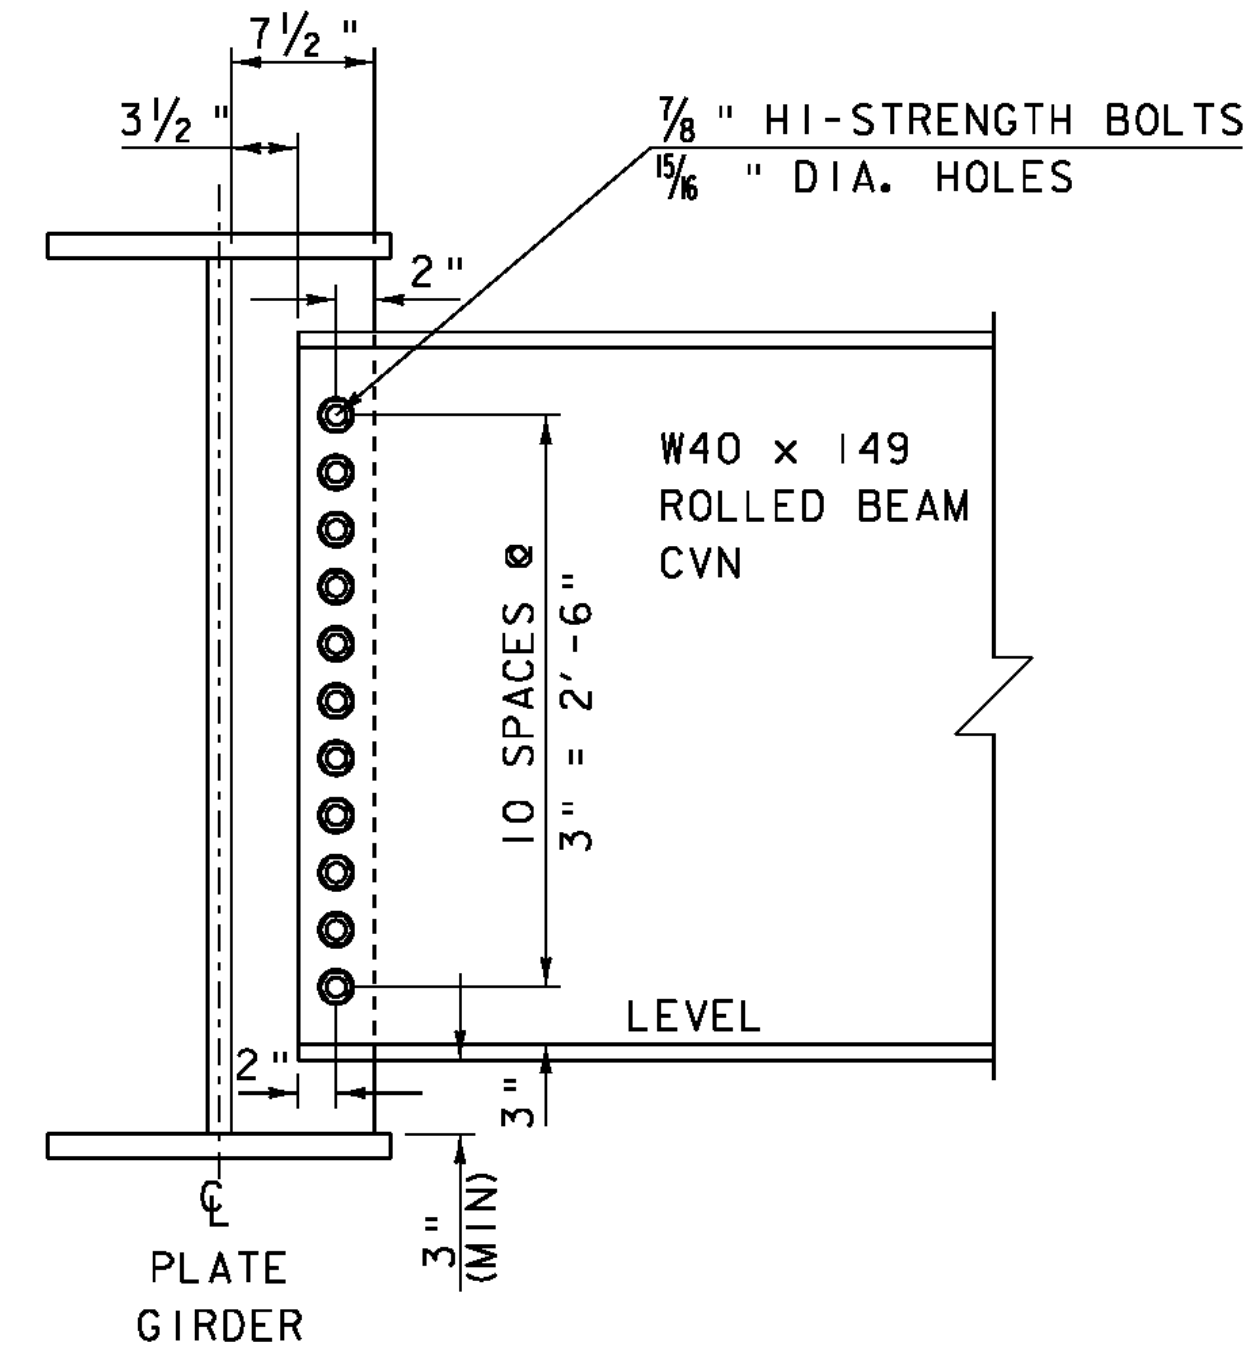

NOTE: GIRDER 1 HAS A MAXIMUM SWEEP DISTANCE OF 3'-3 3/4"
 GIRDER 2 HAS A MAXIMUM SWEEP DISTANCE OF 3'-3 1/8"
 GIRDER 3 HAS A MAXIMUM SWEEP DISTANCE OF 3'-2 1/2"
 GIRDER 4 HAS A MAXIMUM SWEEP DISTANCE OF 3'-1 15/16"
 GIRDER 5 HAS A MAXIMUM SWEEP DISTANCE OF 3'-1 3/8"
 GIRDER 6 HAS A MAXIMUM SWEEP DISTANCE OF 3'-0 15/16"
 GIRDER 7 HAS A MAXIMUM SWEEP DISTANCE OF 3'-0 1/4"
 FIELD SPLICING OF NEW STEEL CURVED GIRDERS WILL NOT BE ALLOWED

NOTE: CONTRACTOR MAY SUBMIT AN EQUIVALENT PLATE DIAPHRAGMS INSTEAD OF THE ROLLED BEAM

INTERMEDIATE DIAPHRAGM DETAIL

N. T. S.

PROJECT NAME: CHESTER	PLOT DATE: 20-SEP-2010
PROJECT NUMBER: BRF 025-1(37)	DRAWN BY: D.D.BEARD
FILE NAME: Structures\s95bi68sup.dgn	CHECKED BY: R.S.YOUNG
PROJECT LEADER: C.P.WILLIAMS	SHEET 81 OF 124
DESIGNED BY: E.R.CHARBONNEAU	
BRIDGE 9 FRAMING PLAN	

