


LEGEND

- AER E&T — ··· AERIAL ELECTRIC & TELEPHONE
- ARCH — ARCHEOLOGICAL AREA
- HISTORIC — HISTORIC AREA
- P — PROPERTY LINE
- L — RIPARIAN BUFFER
- S — SANITARY SEWER PIPE

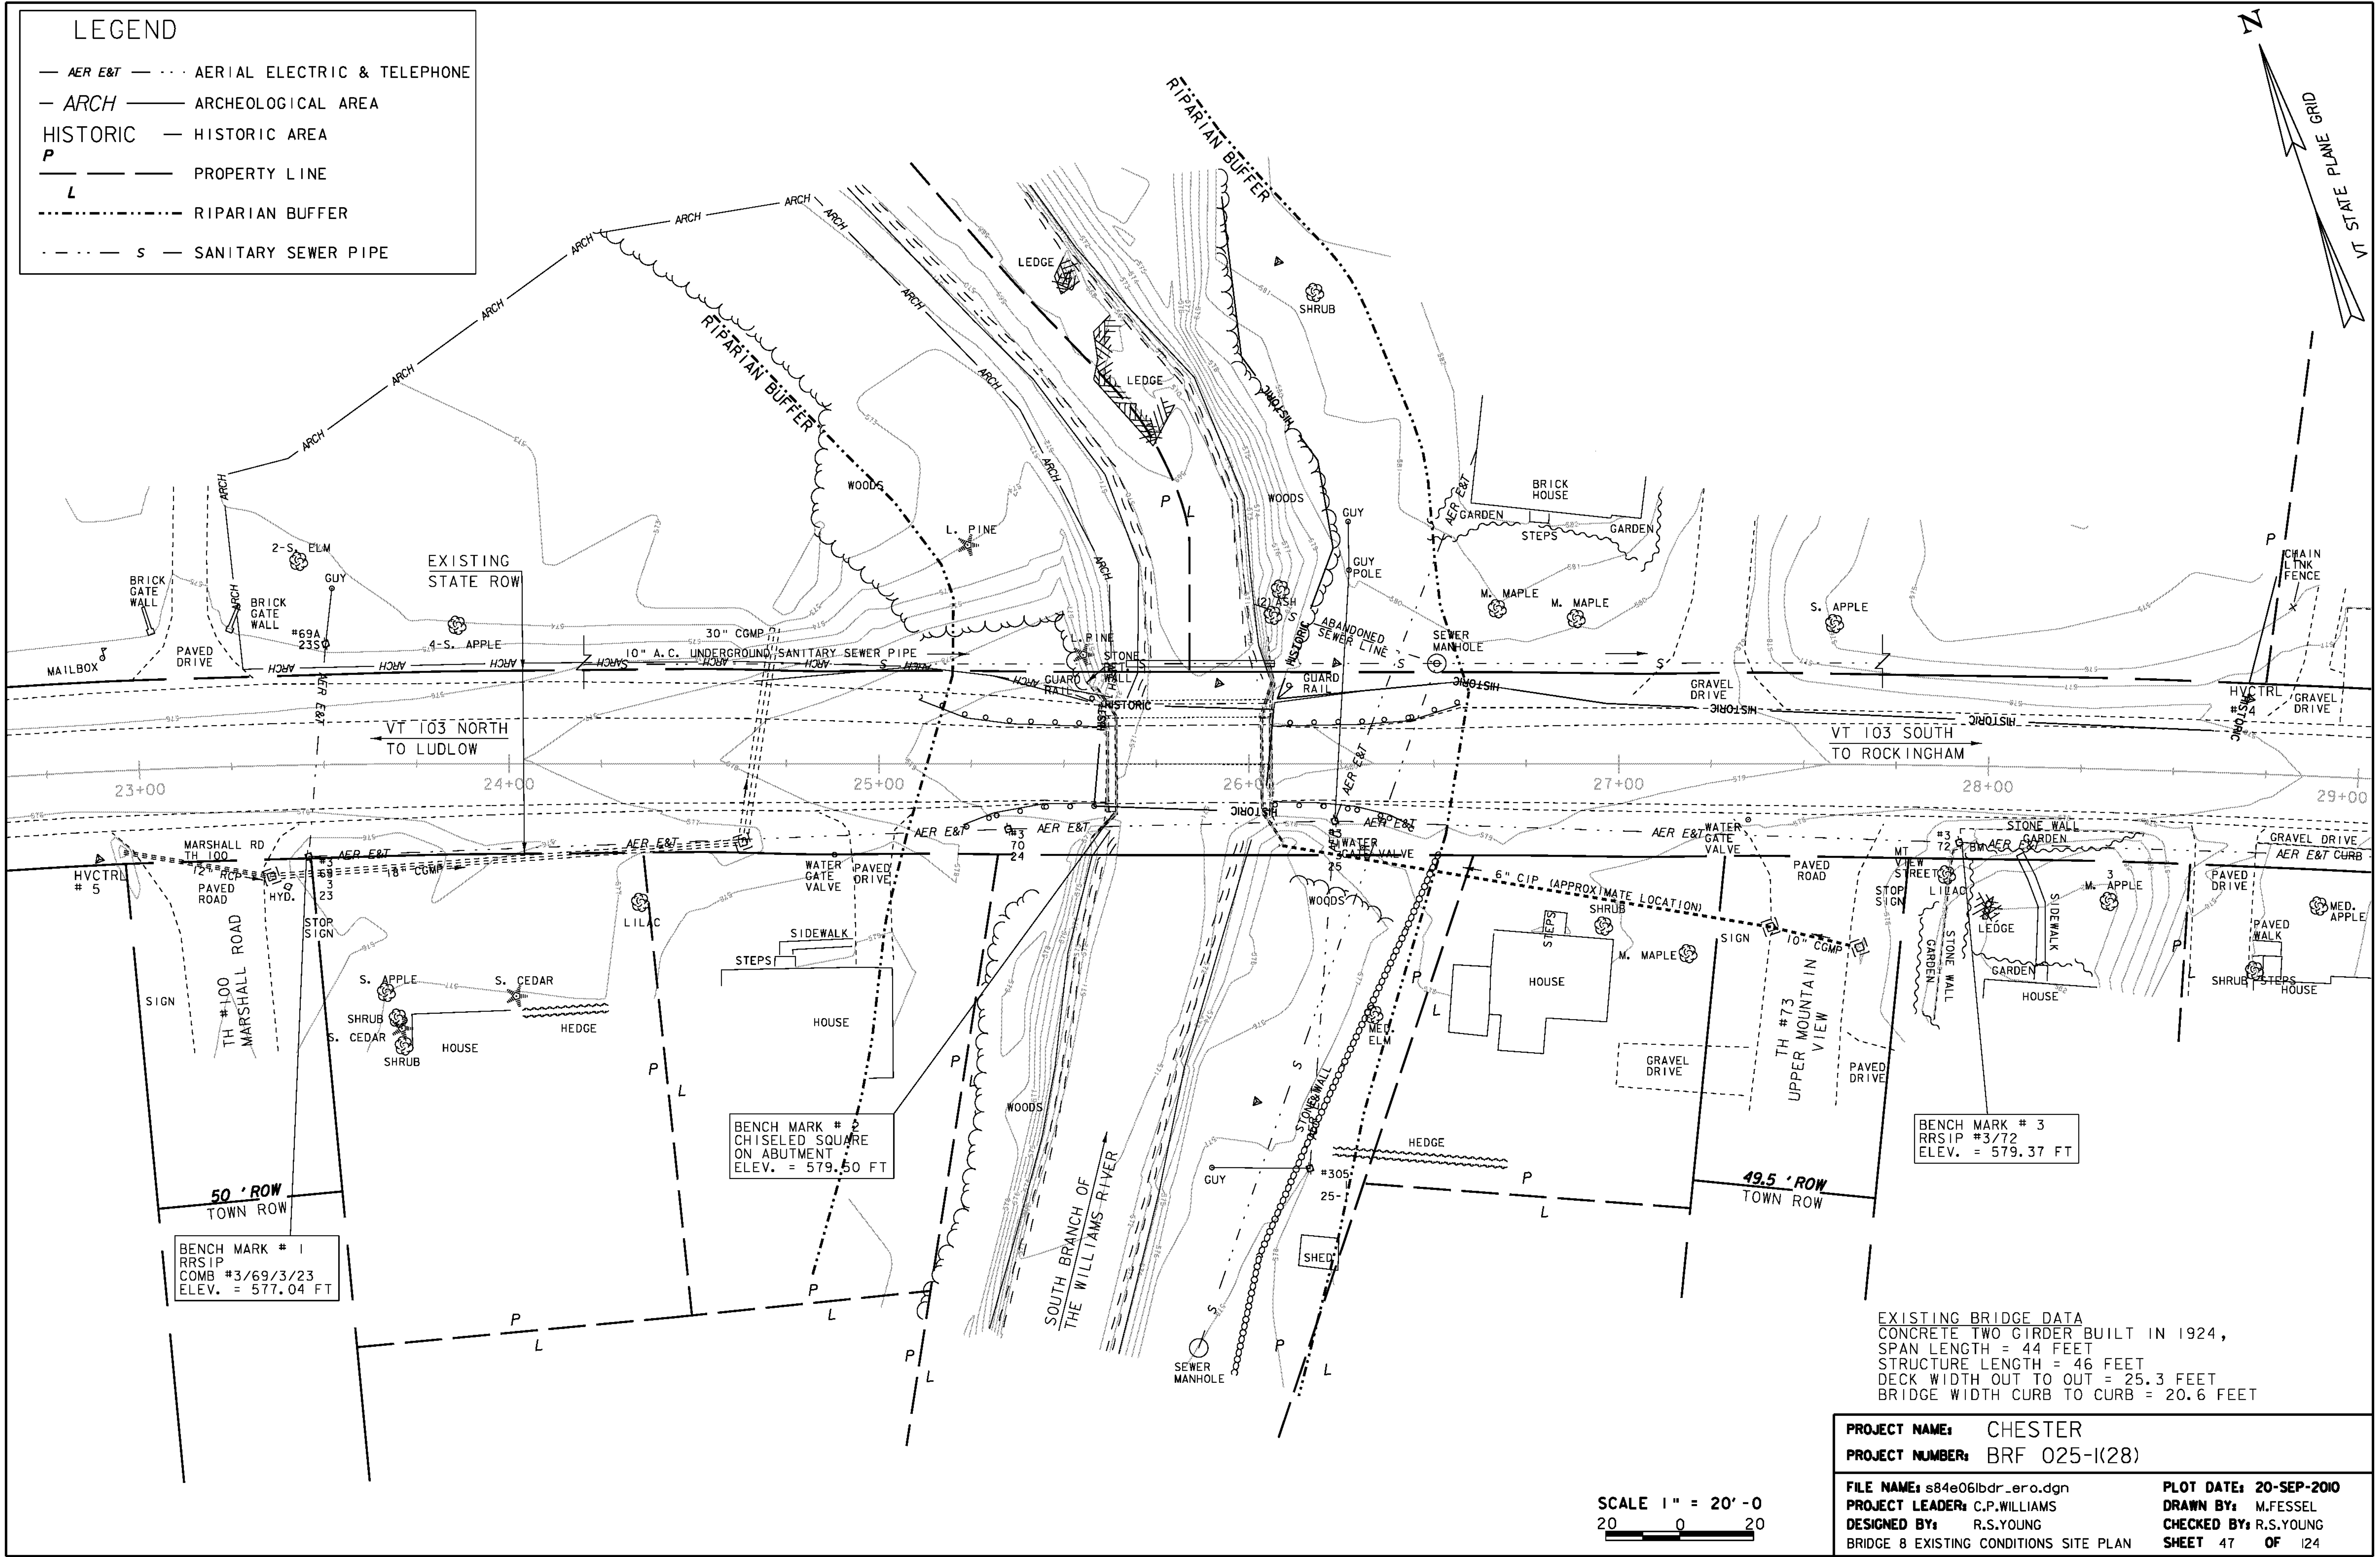

EXISTING BRIDGE DATA
 CONCRETE TWO GIRDER BUILT IN 1924,
 SPAN LENGTH = 44 FEET
 STRUCTURE LENGTH = 46 FEET
 DECK WIDTH OUT TO OUT = 25.3 FEET
 BRIDGE WIDTH CURB TO CURB = 20.6 FEET

PROJECT NAME:	CHESTER	PLOT DATE:	20-SEP-2010
PROJECT NUMBER:	BRF 025-1(28)	DRAWN BY:	M.FESSEL
FILE NAME:	s84e06lbr_ero.dgn	DESIGNED BY:	R.S.YOUNG
PROJECT LEADER:	C.P.WILLIAMS	CHECKED BY:	R.S.YOUNG
BRIDGE 8 EXISTING CONDITIONS SITE PLAN		SHEET	47 OF 124

SCALE 1" = 20'-0"
 20 0 20

BENCH MARK # 1
 RRSIP
 COMB #3/69/3/23
 ELEV. = 577.04 FT

BENCH MARK # 2
 CHISELED SQUARE
 ON ABUTMENT
 ELEV. = 579.50 FT

BENCH MARK # 3
 RRSIP #3/72
 ELEV. = 579.37 FT