



**RESTORATION PLANTING PLAN**

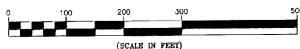

SPECIES	COMMON NAMES	QUANTITY/DENSITY/SPECIFICATION	ITEM NUMBERS
<b>GRAMINOIDS/HERBS</b>			
PHALARIS ARUNDINACEA SCIRPUS CYPERINUS	REED CANARY GRASS WOOL GRASS	12 LBS (30 LBS/ACRE) 200, BR. 2' ON CENTER	651.15 (MOD #1) 656.40
GLYCERIA CANADENSIS CAREX LACUSTRIS POLYGONUM PENNSYLVANICUM	MANNA GRASS LAKE SEDGE SMART WEED	2 LBS (10 LBS/ACRE) 200, BR. 2' ON CENTER 2 LBS (20 LBS/ACRE)	651.15 (MOD #2) 656.40 651.15 (MOD #3)
IRIS VERSICOLOR	BLUE FLAG IRIS	100; 10 GROUPS OF 10, 3' ON CENTER	656.40
<b>SHRUBS</b>			
CORNUS STOLONIFERA	RED - OSIER DOGWOOD	120; 18"-2'; STAGGERED ROW AT BASE OF SLOPE, 5' ON CENTER	656.35
POTENTILLA FRUTICOSA	SHRUBBY CINQUEFOIL	50; 12"-18"; 10 CLUMPS OF 5, 3' ON CENTER	656.35
VIBURNUM TRILOBUM	HIGHBUSH CRANBERRY	70; 18"-2'; 10 CLUMPS OF 3, 6' ON CENTER	656.35
SAMBUCUS CANADENSIS	ELDERBERRY	45; 2'; 15' ON CENTER	656.35

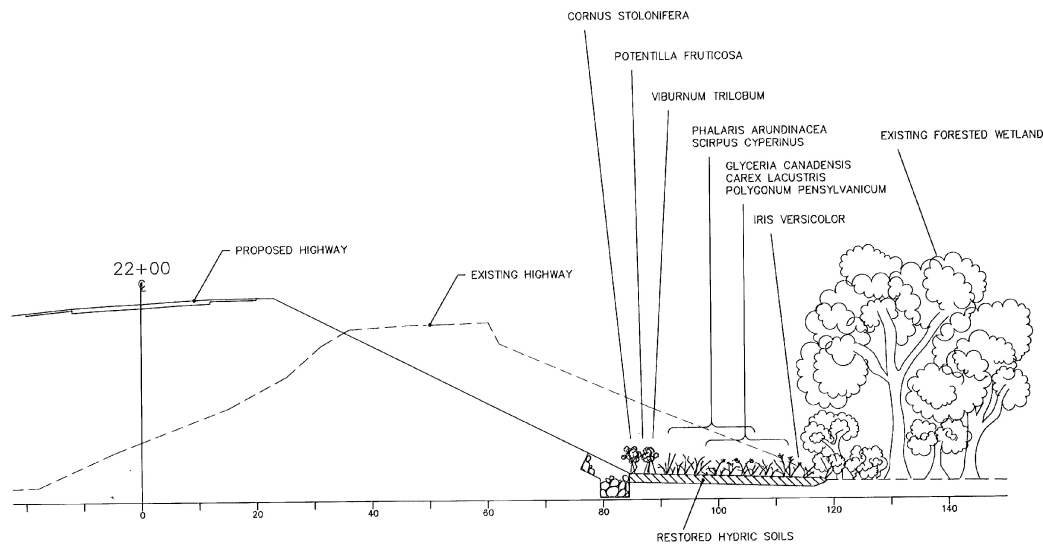

**WETLAND RESTORATION AREA: TYPICAL CROSS-SECTION**

SCALE: 1" = 10'

**EROSION CONTROL MEASURES**

SILT BARRIERS, STAKED HAY-BALE DIKES, JUTE MATTING, AND HAY MULCH WILL BE EMPLOYED ACCORDING TO THE SITE PLANS AND RESIDENT ENGINEER TO INHIBIT EROSION AND TO STABILIZE NEWLY ESTABLISHED SLOPES.

**WETLAND MITIGATION**

SURVEYED BY \_\_\_\_\_ DATE \_\_\_\_\_  
 DRAWN BY V.A.O.T. DATE 08/94  
 TRACED BY K.G.G. DATE 11/94  
 WALLINGFORD  
 PROJ. BRS NO. 0137(13)  
 SHEET 25 OF 113