


50D COLTON LOAMY FINE SAND  
WITH 15% TO 25% SLOPES  
"K FACTOR" = 0.17

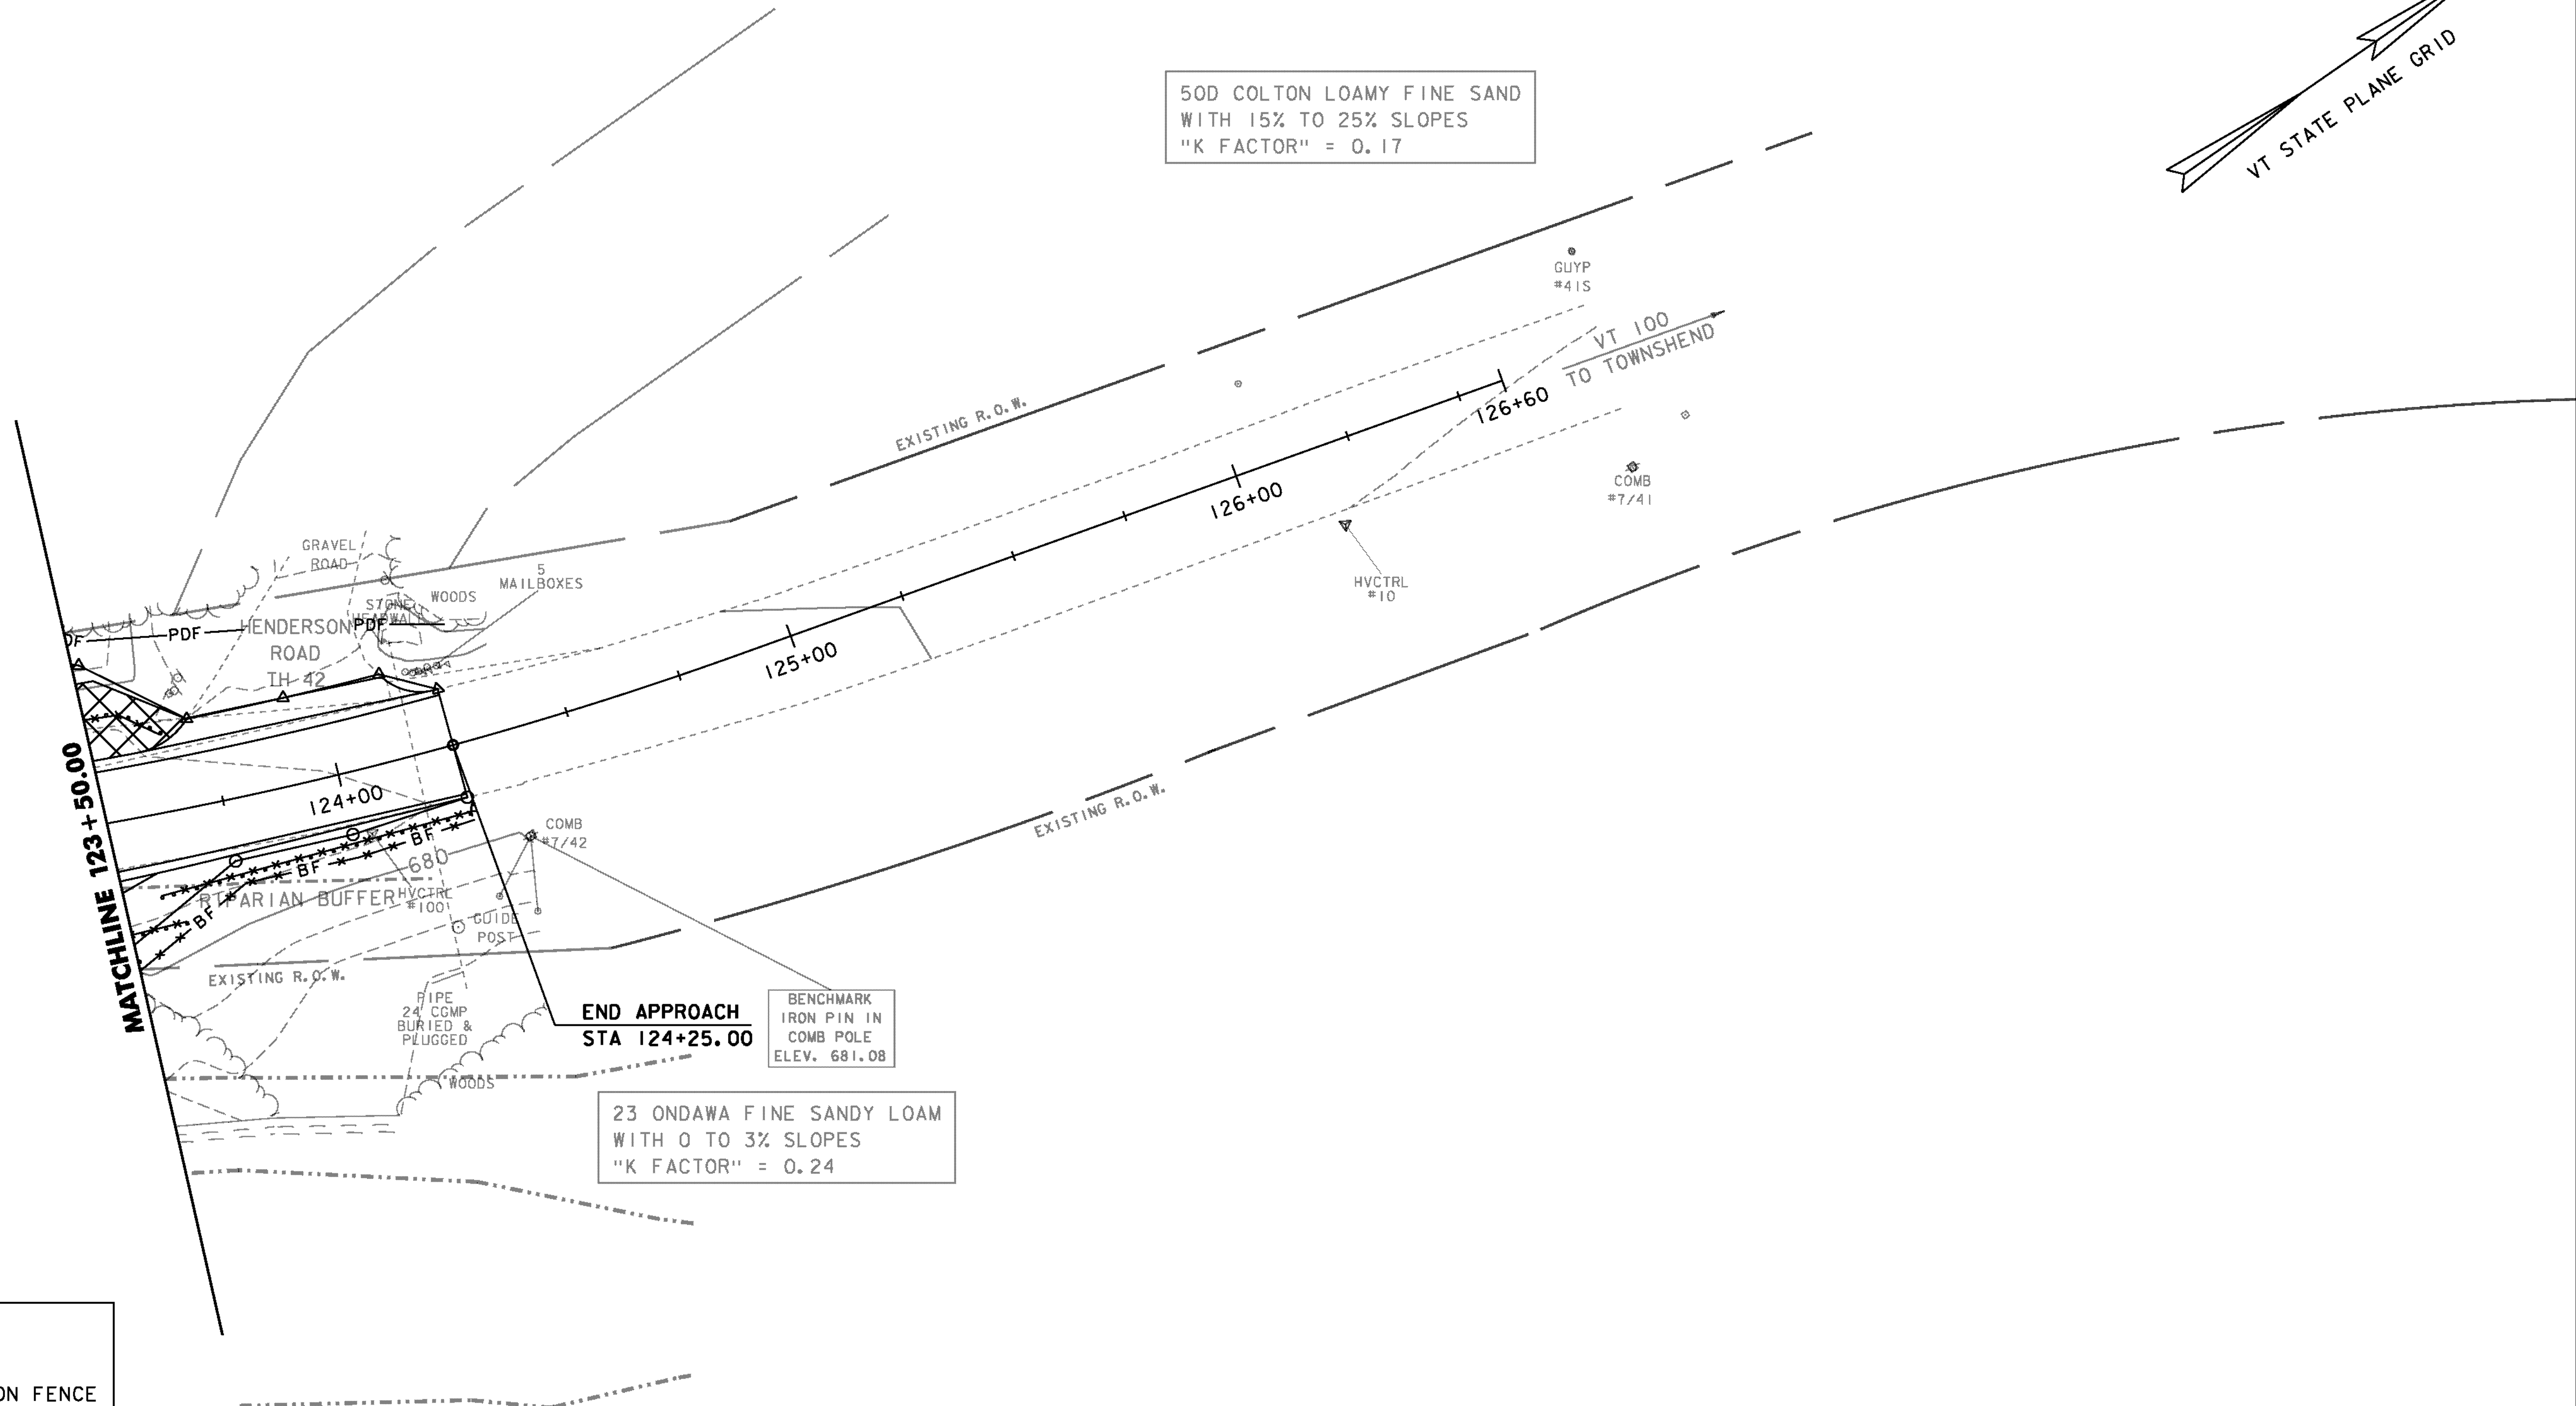

END APPROACH  
STA 124+25.00  
BENCHMARK  
IRON PIN IN  
COMB POLE  
ELEV. 681.08

23 ONDAWA FINE SANDY LOAM  
WITH 0 TO 3% SLOPES  
"K FACTOR" = 0.24

23 ONDAWA FINE SANDY LOAM  
WITH 0 TO 3% SLOPES  
"K FACTOR" = 0.24

**LEGEND**

	CUT/FILL LIMITS
	PROJECT DEMARCATION FENCE
	SILT FENCE, WIRE WOVEN REINFORCED
	BARRIER FENCE
	FILTER BAG
	SURFACE ROUGHENING
	ROLLED EROSION CONTROL PRODUCT (RECP)
	STONE FILL
	STABILIZED CONSTRUCTION ENTRANCE
	TURBIDITY CURTAIN

**EPSC - CONSTRUCTION SITE PLAN SHEET 3**

SCALE 1" = 20'-0"  
20 0 20

PROJECT NAME: JAMAICA	PLOT DATE: 12-OCT-2012
PROJECT NUMBER: ER-BRF 013-1(16)	DRAWN BY: K. FRIEDLAND
FILE NAME: s11b212ero_dur.dgn	CHECKED BY: G. LAROCHE
PROJECT LEADER: K. HIGGINS	SHEET 52 OF 85
DESIGNED BY: G. LAROCHE	
EPSC CONSTRUCTION SITE PLAN SHEET 3	