


64 UDIFLUENTS, LOAMY
WITH 0% TO 3% SLOPES
"K FACTOR" = N/A

64 UDIFLUENTS, LOAMY
WITH 0% TO 3% SLOPES
"K FACTOR" = N/A

50D COLTON LOAMY FINE SAND
WITH 15% TO 25% SLOPES
"K FACTOR" = 0.17

MATCHLINE 118 + 00.00

MATCHLINE 123 + 50.00

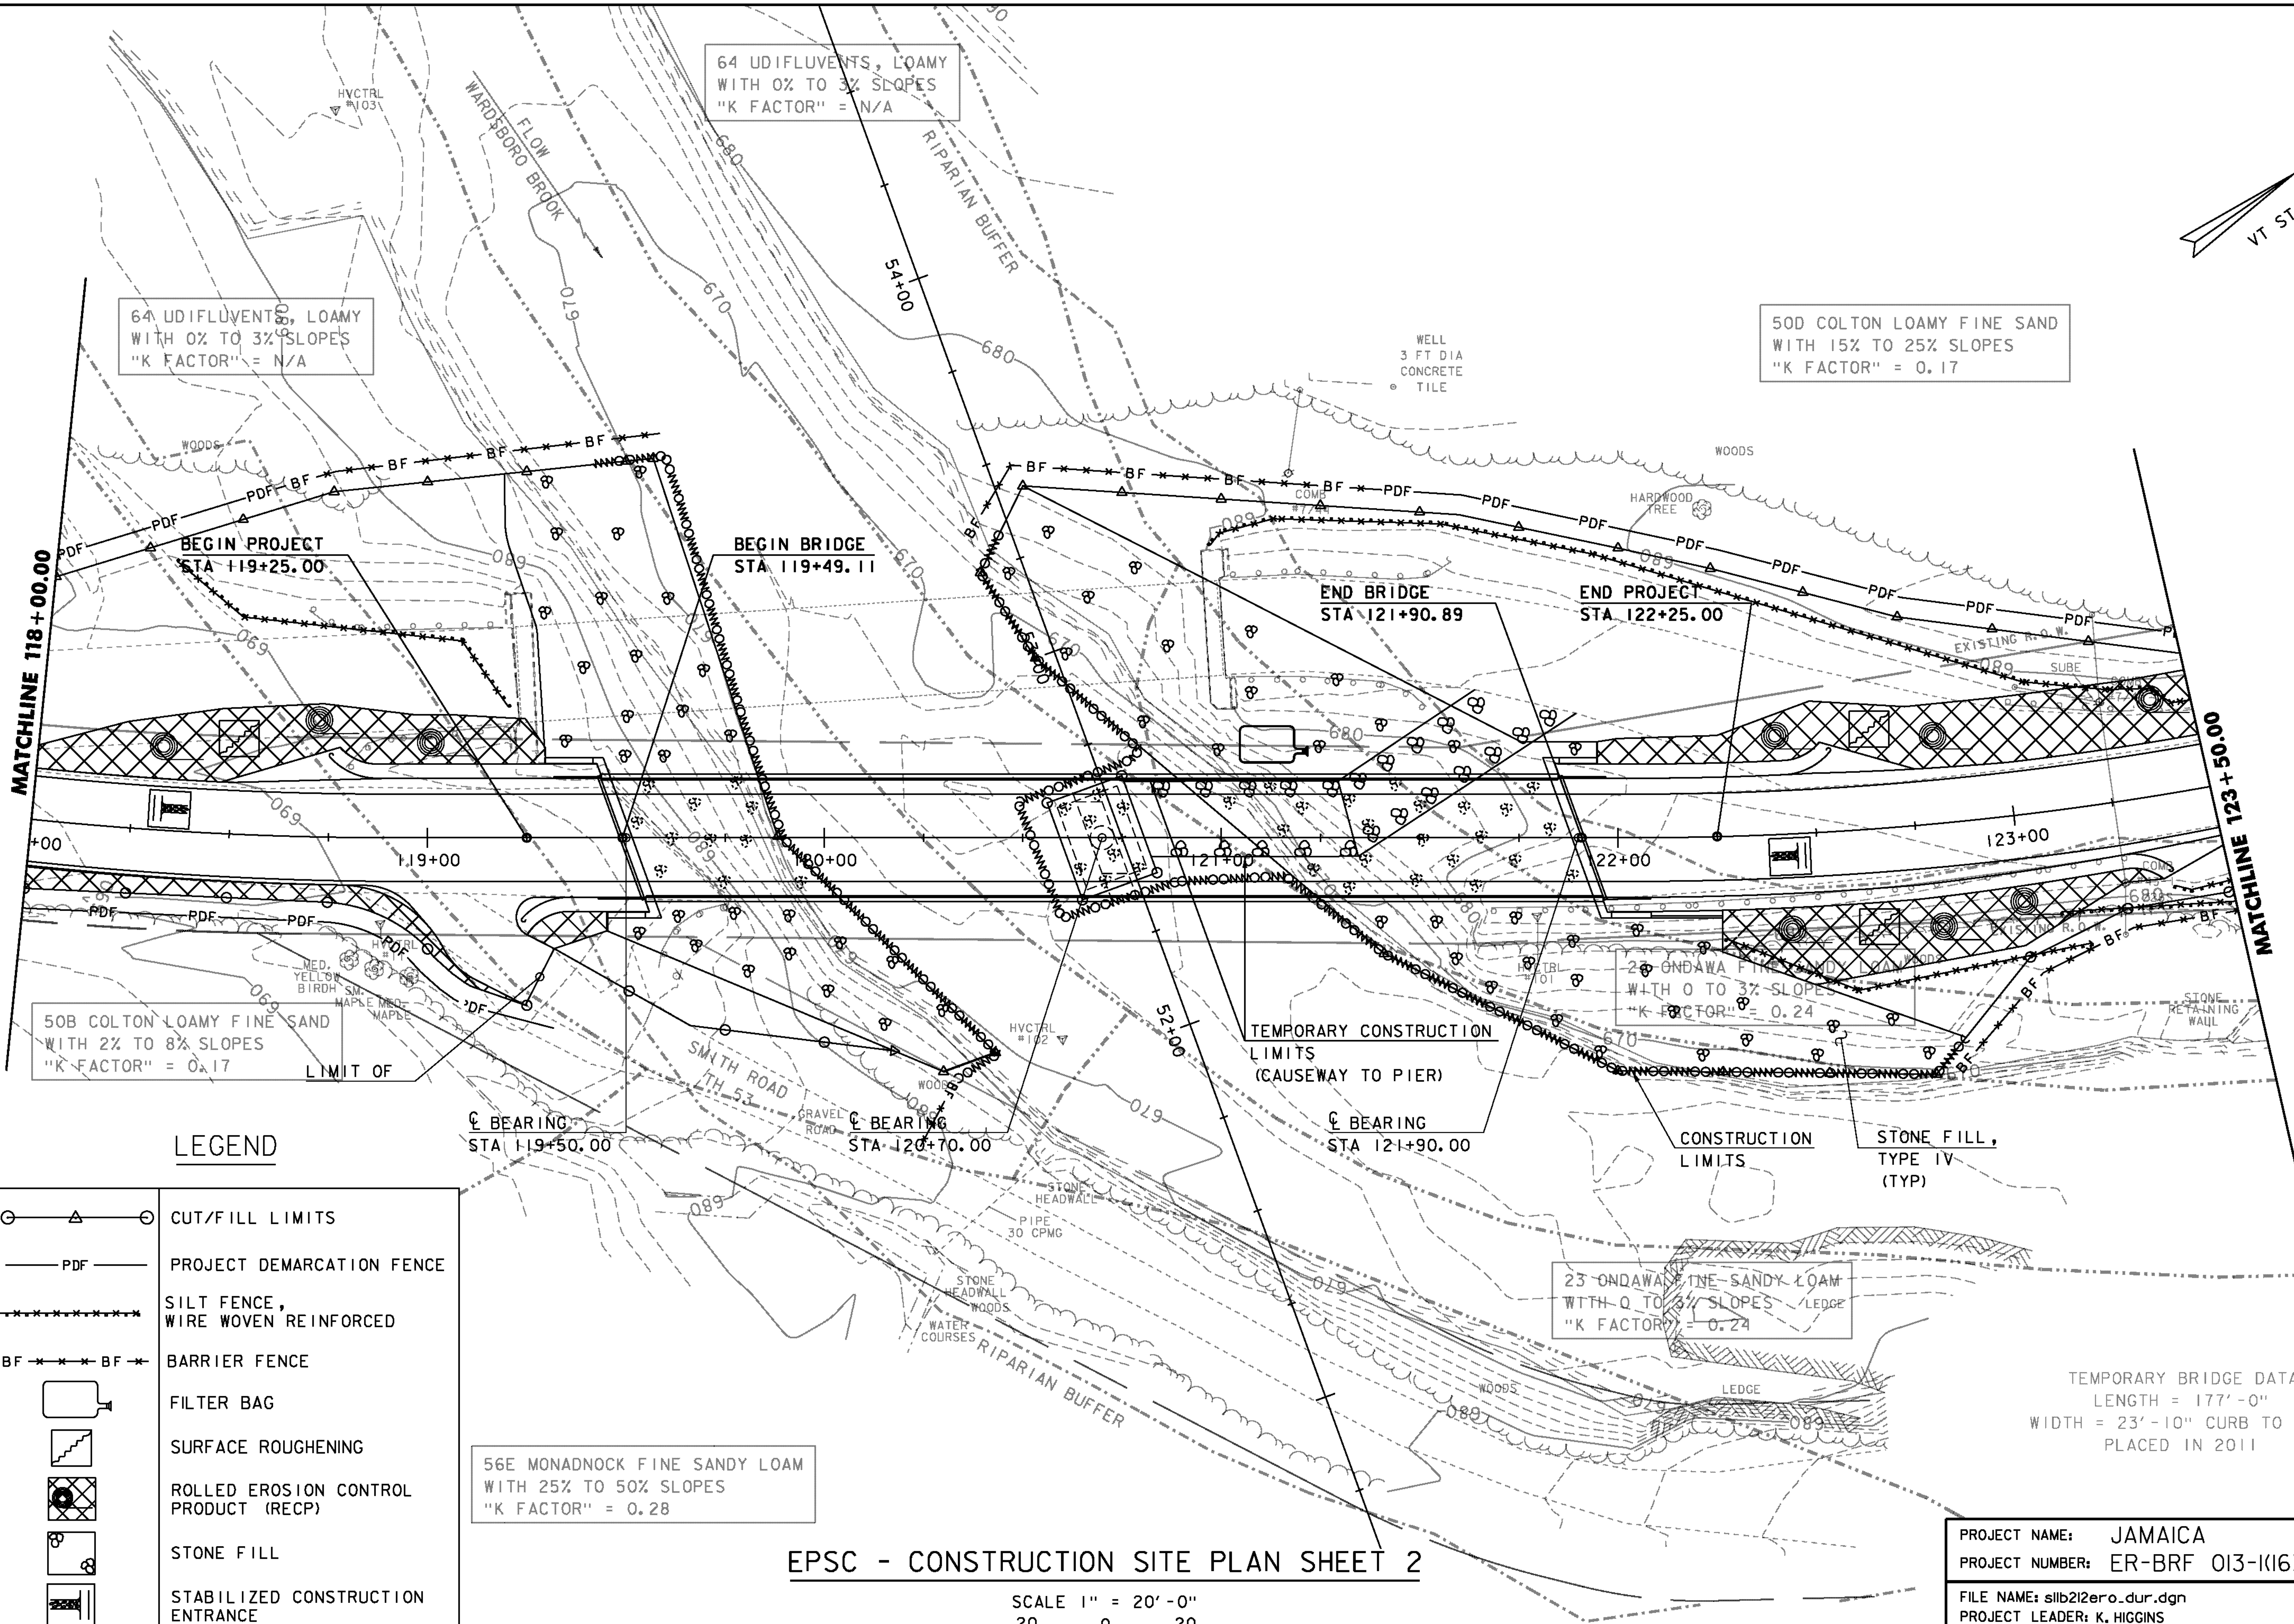

LEGEND

	CUT/FILL LIMITS
	PROJECT DEMARCATION FENCE
	SILT FENCE, WIRE WOVEN REINFORCED
	BARRIER FENCE
	FILTER BAG
	SURFACE ROUGHENING
	ROLLED EROSION CONTROL PRODUCT (RECP)
	STONE FILL
	STABILIZED CONSTRUCTION ENTRANCE
	TURBIDITY CURTAIN

56E MONADNOCK FINE SANDY LOAM
WITH 25% TO 50% SLOPES
"K FACTOR" = 0.28

23 ONDAWA FINE SANDY LOAM
WITH 0 TO 3% SLOPES
"K FACTOR" = 0.24

EPSC - CONSTRUCTION SITE PLAN SHEET 2

SCALE 1" = 20' - 0"
20 0 20

TEMPORARY BRIDGE DATA
LENGTH = 177' - 0"
WIDTH = 23' - 10" CURB TO CURB
PLACED IN 2011

PROJECT NAME:	JAMAICA	PLOT DATE:	12-OCT-2012
PROJECT NUMBER:	ER-BRF 013-1(16)	DRAWN BY:	K. FRIEDLAND
FILE NAME:	s1b212ero.dur.dgn	DESIGNED BY:	G. LAROCHE
PROJECT LEADER:	K. HIGGINS	CHECKED BY:	G. LAROCHE
EPSC CONSTRUCTION SITE PLAN SHEET 2		SHEET	51 OF 85