



	CUT/FILL LIMITS
	PROJECT DEMARCATION FENCE
	ROLLED EROSION CONTROL PRODUCT (RECP)
	ROCK OUTLET PROTECTION
	SOIL GROUP LINE
	SILT FENCE
	STABILIZED CONSTRUCTION ENTRANCE
	TURBIDITY CURTAIN

GEOTEXTILE FOR SILT FENCE
 STA 54+00.00 - 54+25.00 LT
 STA 54+00.00 - 55+60.00 RT
 STA 54+50.00 - 55+75.00 LT
 STA 56+00.00 - 56+65.00 RT
 STA 56+25.00 - 57+70.00 LT
 STA 56+85.00 - 57+70.00 RT

PROJECT DEMARCATION FENCE
 STA 54+00.00 - 54+25.00 LT
 STA 54+00.00 - 55+60.00 RT
 STA 54+50.00 - 55+75.00 LT
 STA 56+00.00 - 56+65.00 RT
 STA 56+25.00 - 57+70.00 LT
 STA 56+85.00 - 57+70.00 RT

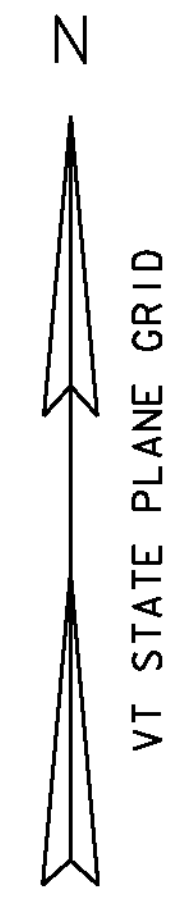

3A CHARLES SILT LOAM
 0% TO 2% SLOPES
 FREQUENTLY FLOODED
 "K" FACTOR = 0.32

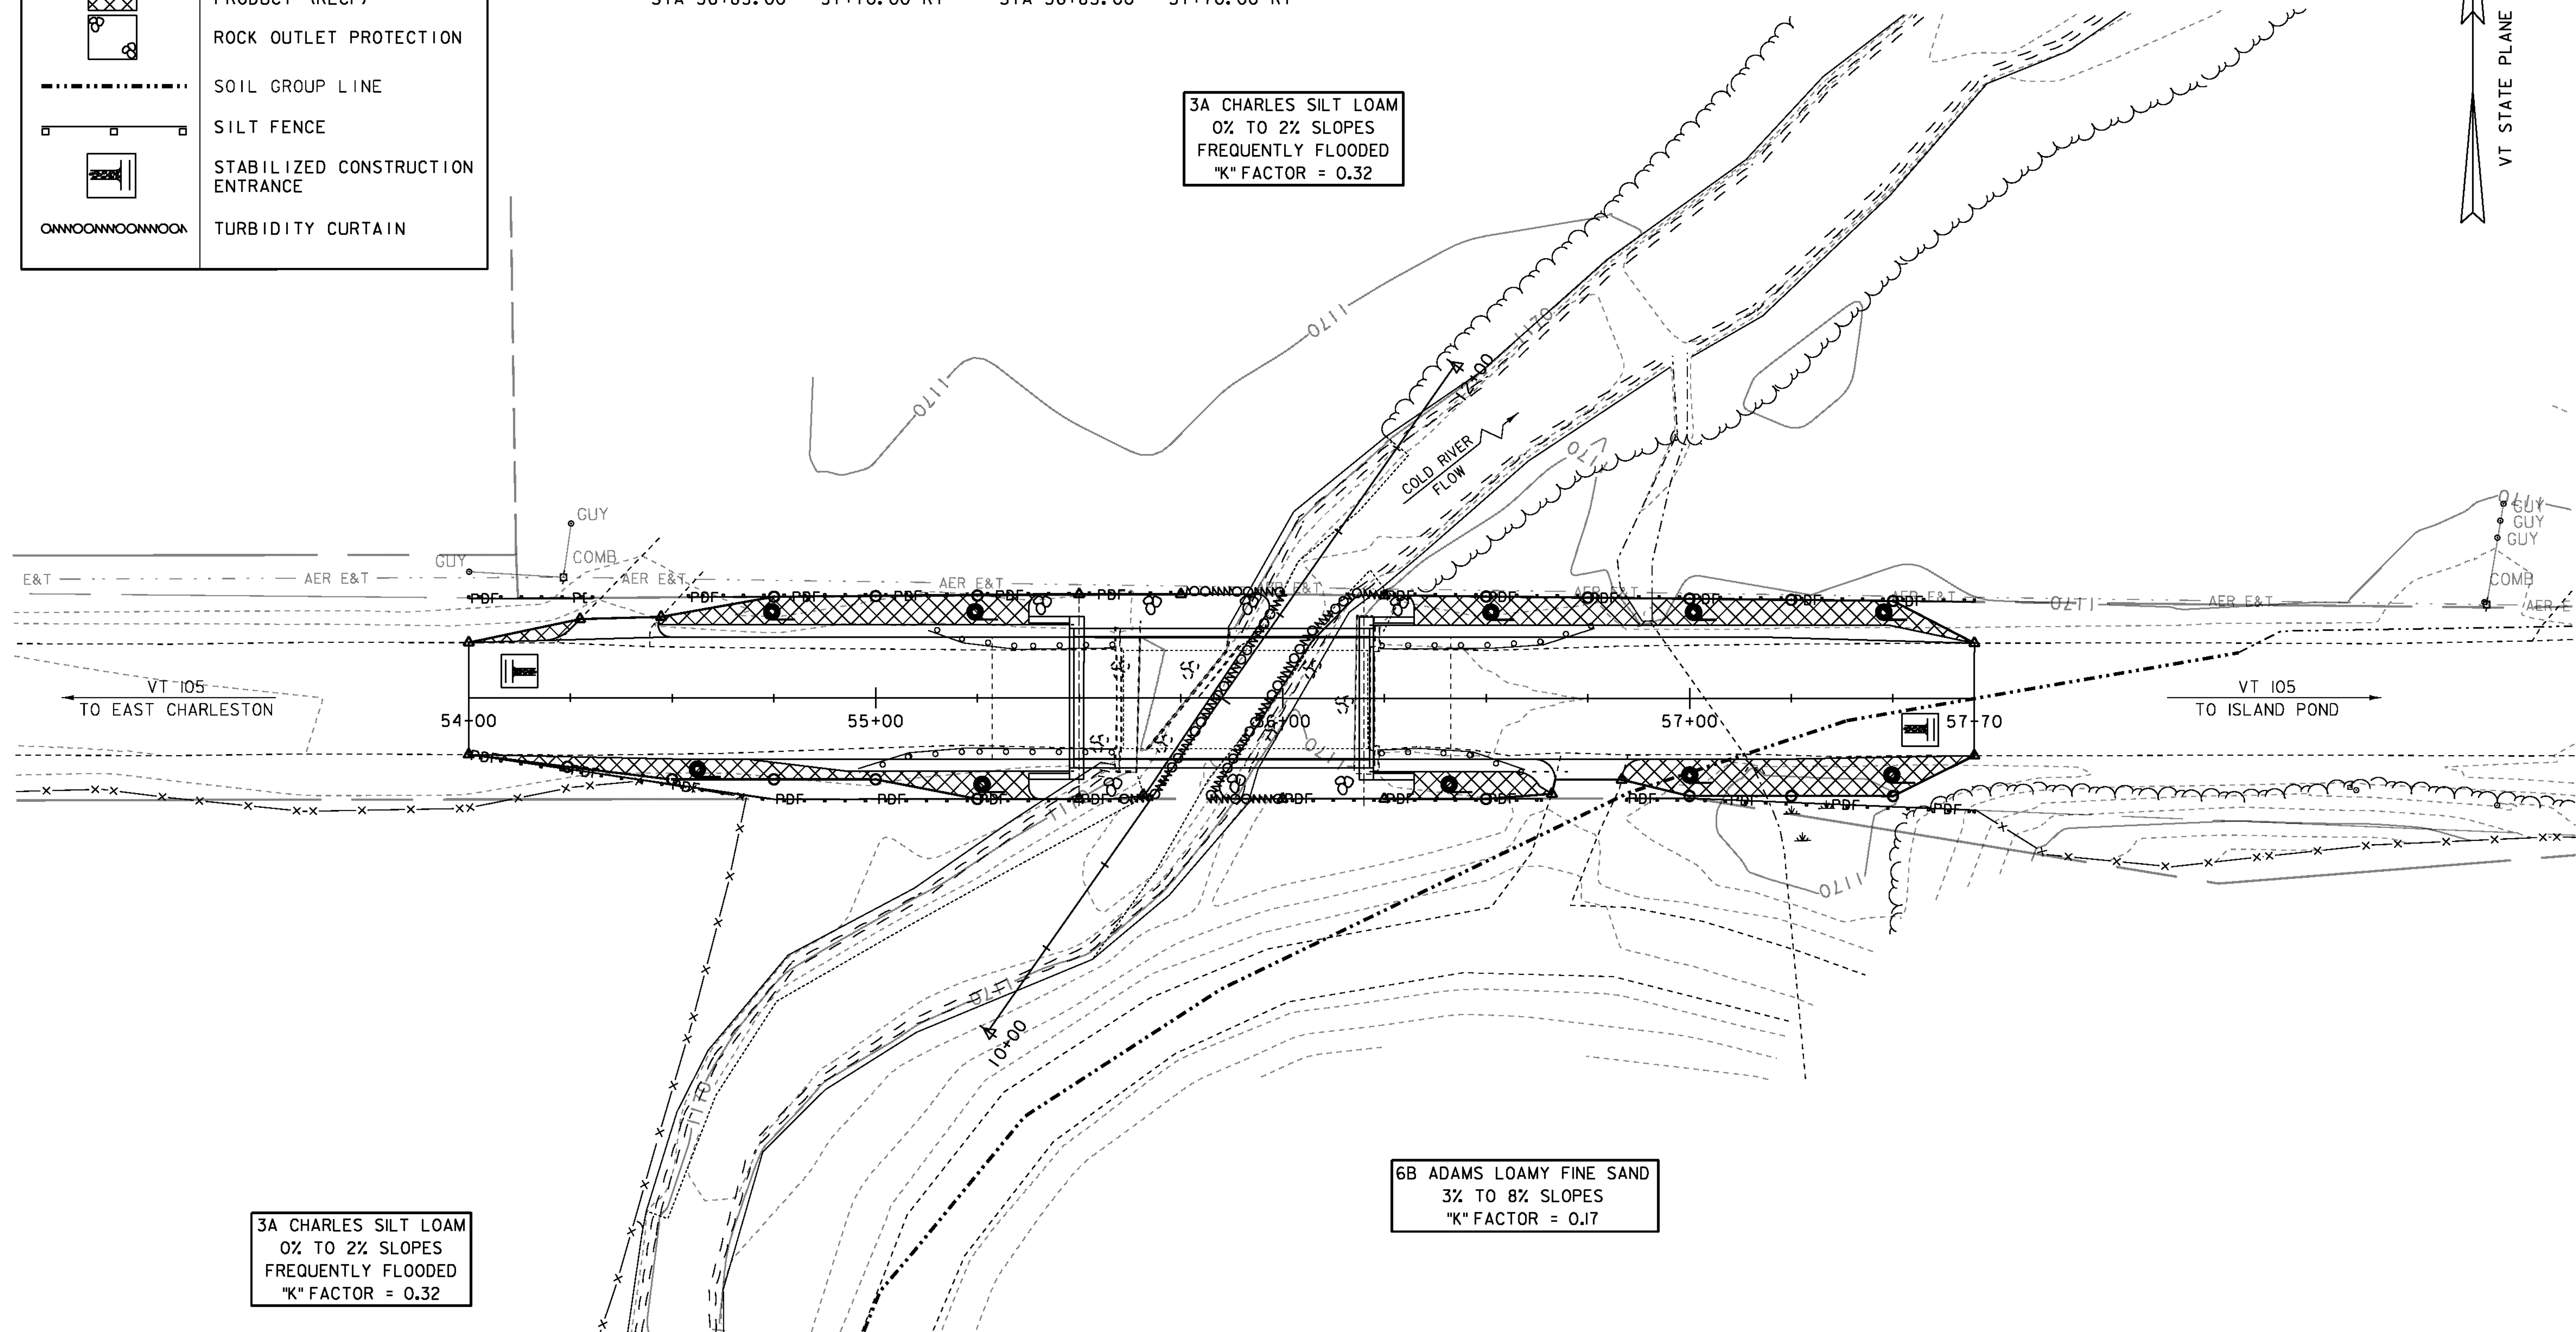

3A CHARLES SILT LOAM
 0% TO 2% SLOPES
 FREQUENTLY FLOODED
 "K" FACTOR = 0.32

6B ADAMS LOAMY FINE SAND
 3% TO 8% SLOPES
 "K" FACTOR = 0.17

NOTES:

- EXISTING CONTOURS SHOWN. SEE CROSS SECTIONS FOR FINAL CONDITIONS.
- FOR CLARITY, AREAS TO BE SEEDED AND MULCHED HAVE NOT BEEN INDICATED. ALL DISTURBED AREAS SHALL BE SEEDED AND MULCHED AS APPLICABLE.

EPSC PLAN
 SCALE 1" = 20'-0"
 20 0 20

PROJECT NAME: BRIGHTON
 PROJECT NUMBER: ER STP 034-3(25)

FILE NAME: slb208epsc.dgn
 PROJECT LEADER: K. HIGGINS
 DESIGNED BY: J. SALVATORI
 EPSC PLAN

PLOT DATE: 12-SEP-2012
 DRAWN BY: J. SALVATORI
 CHECKED BY: W. LAMMER
 SHEET 26 OF 36