



FRAMING PLAN
SCALE 1/8" = 1'-0"

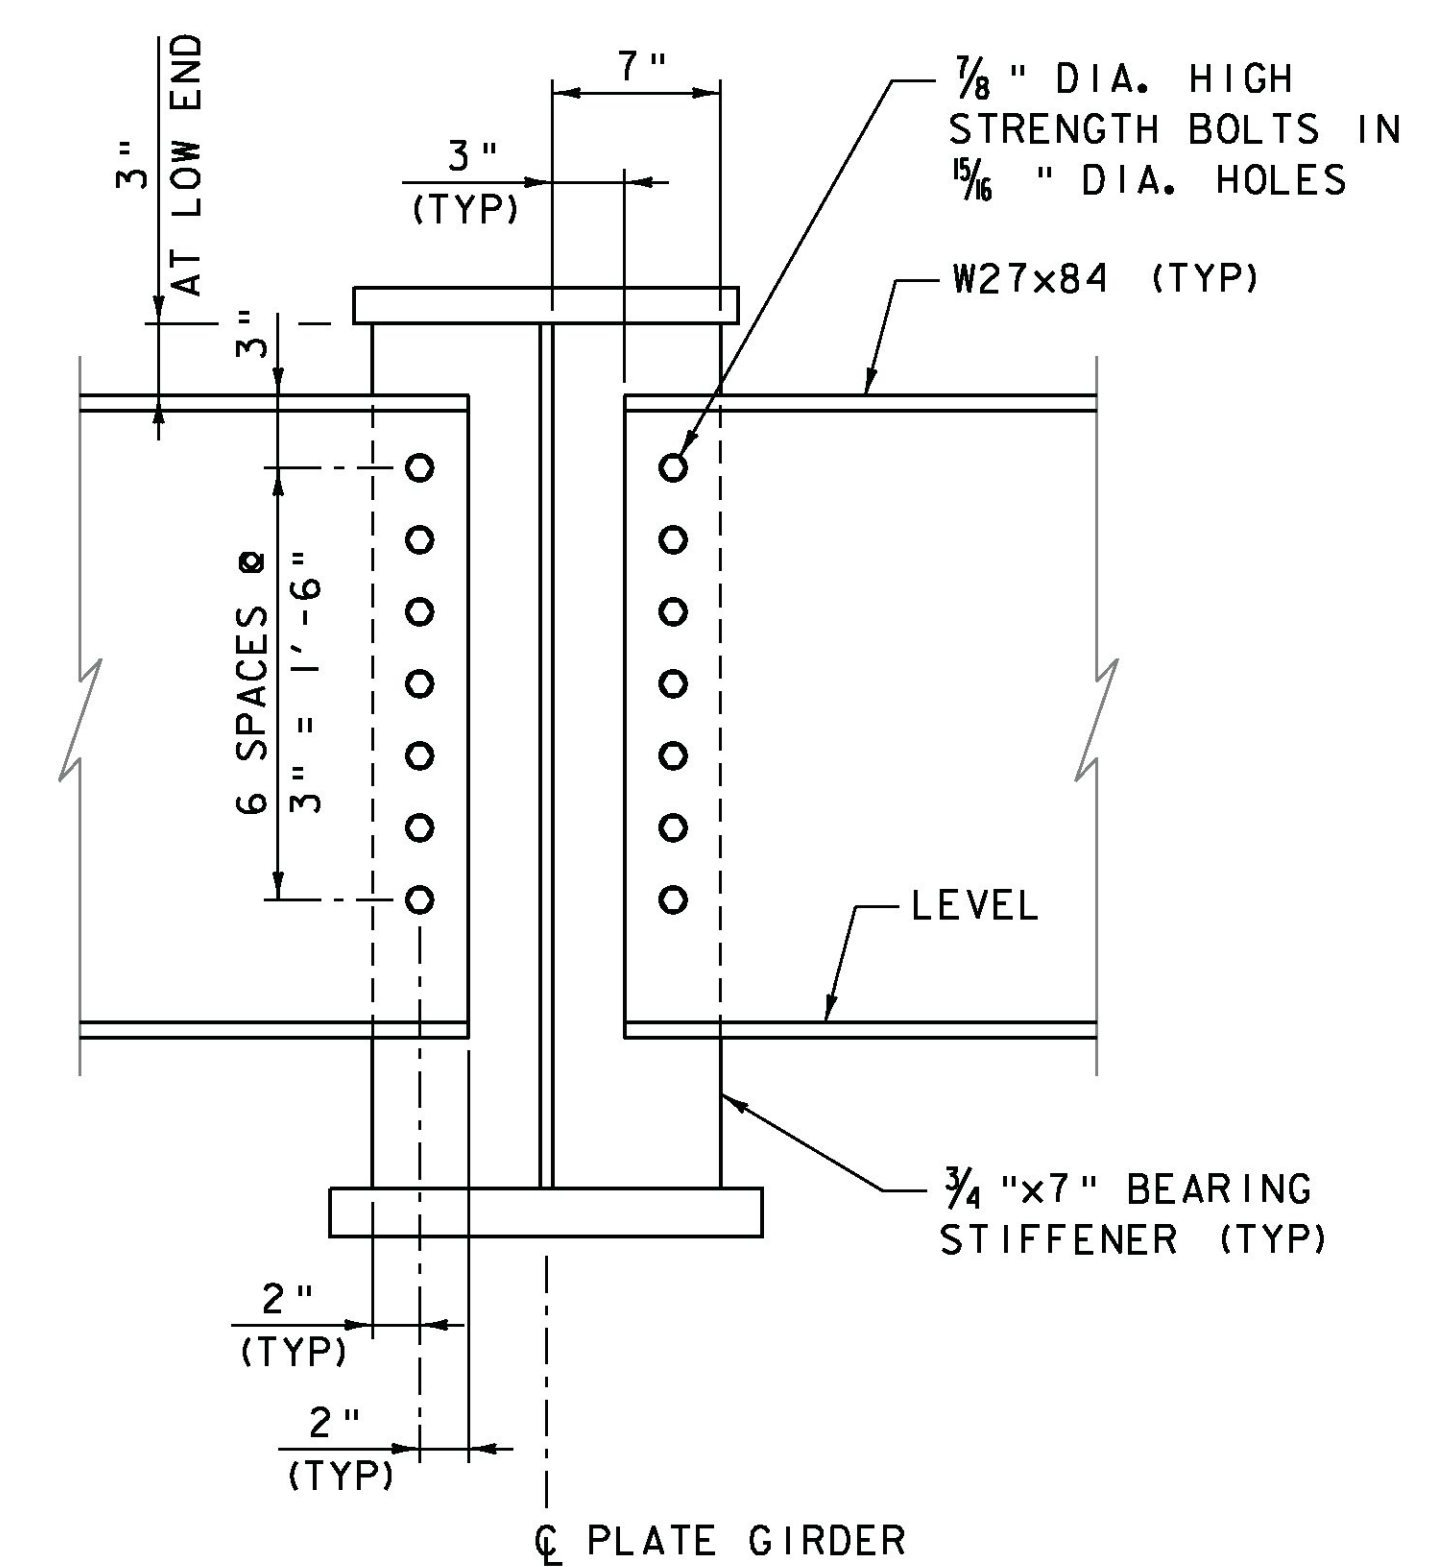

ABUTMENT DIAPHRAGM CONNECTION DETAIL
SCALE 1/2" = 1'-0"

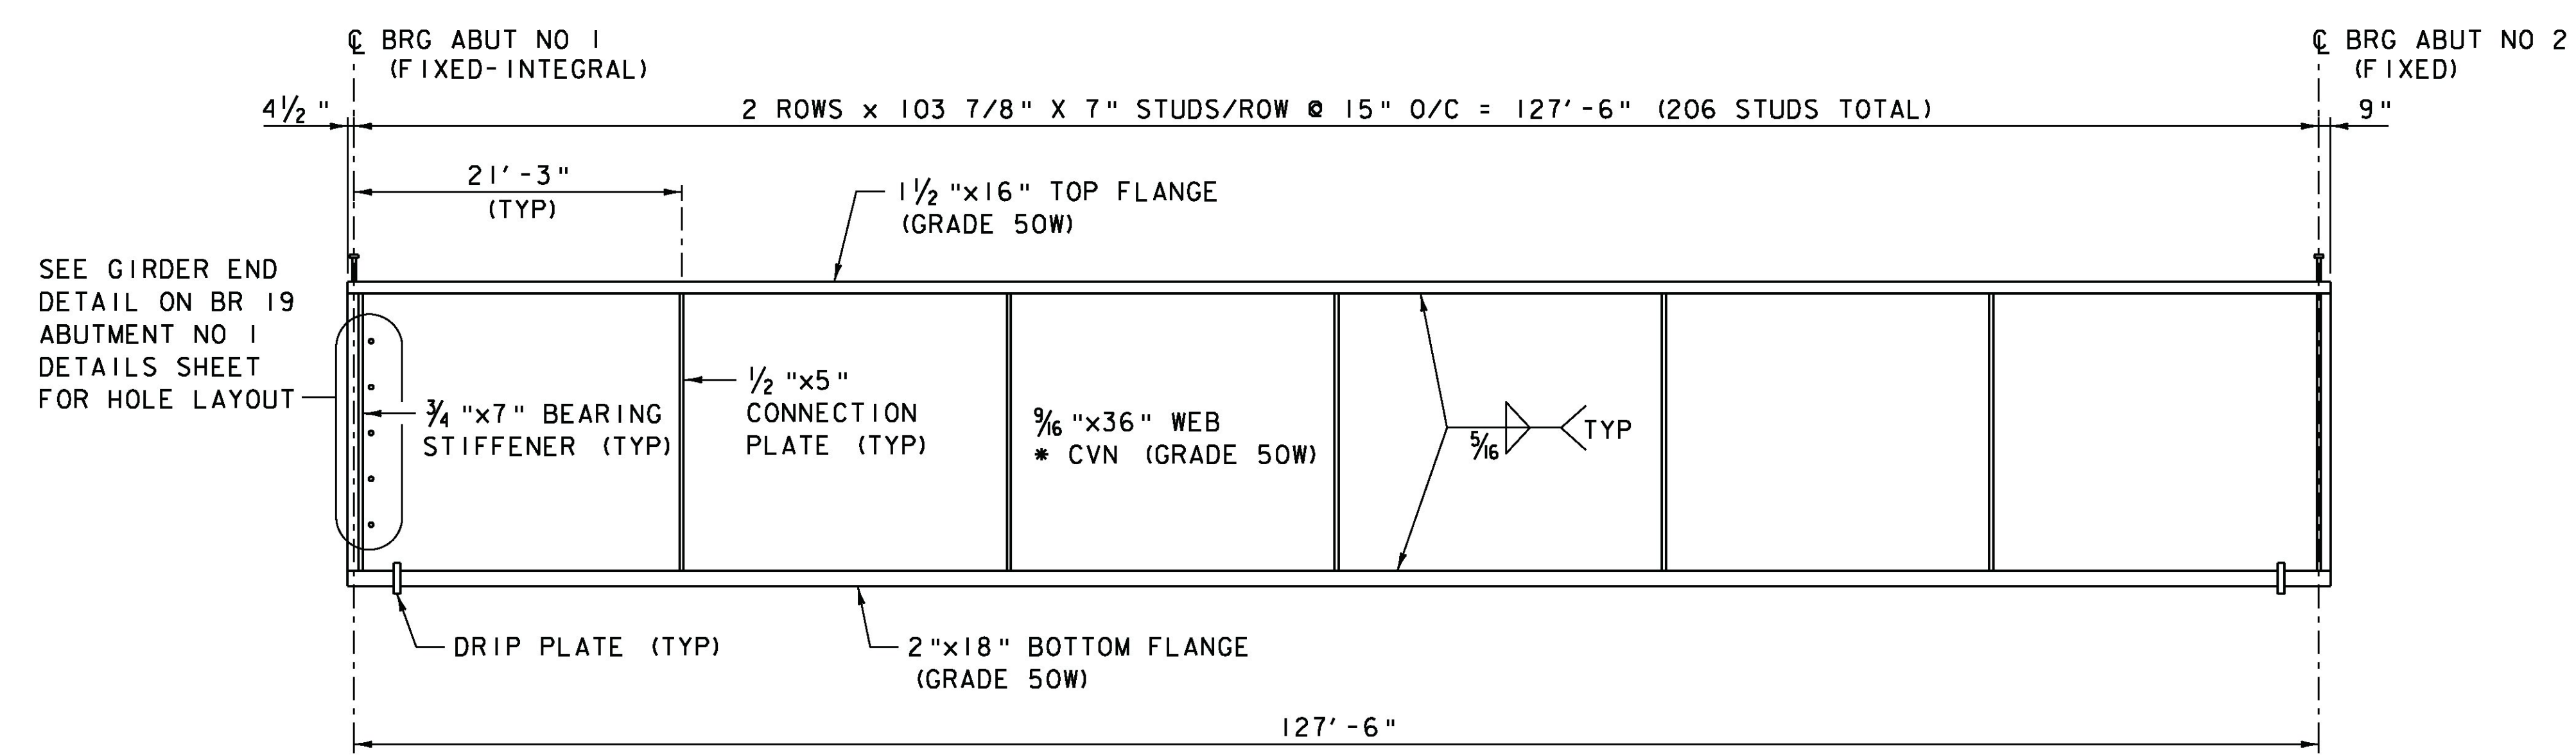

TYPICAL GIRDER ELEVATION
HORZ SCALE 1/8" = 1'-0"
VERT SCALE 3/4" = 1'-0"

- NOTES:**
1. * CVN DENOTES THAT CHARPY V-NOTCH TEST IS REQUIRED.
 2. TWO ROWS OF 3/8" DIA. WELDED STUD CONNECTORS AT 15". SEE STRUCTURES DETAIL SD-601.00.

PROJECT NAME: ROCHESTER	
PROJECT NUMBER: ER BRF 0162(18)	
FILE NAME: zilc332sup2.dgn	PLOT DATE: 8/19/2013
PROJECT LEADER: S.E. BURBANK	DRAWN BY: B.J. MASSE
DESIGNED BY: L.S. CHERVINCKY	CHECKED BY: G.S. GOODRICH
BR 19 FRAMING PLAN	SHEET 205 OF 238

