



FRAMING PLAN
SCALE 1/4" = 1'-0"

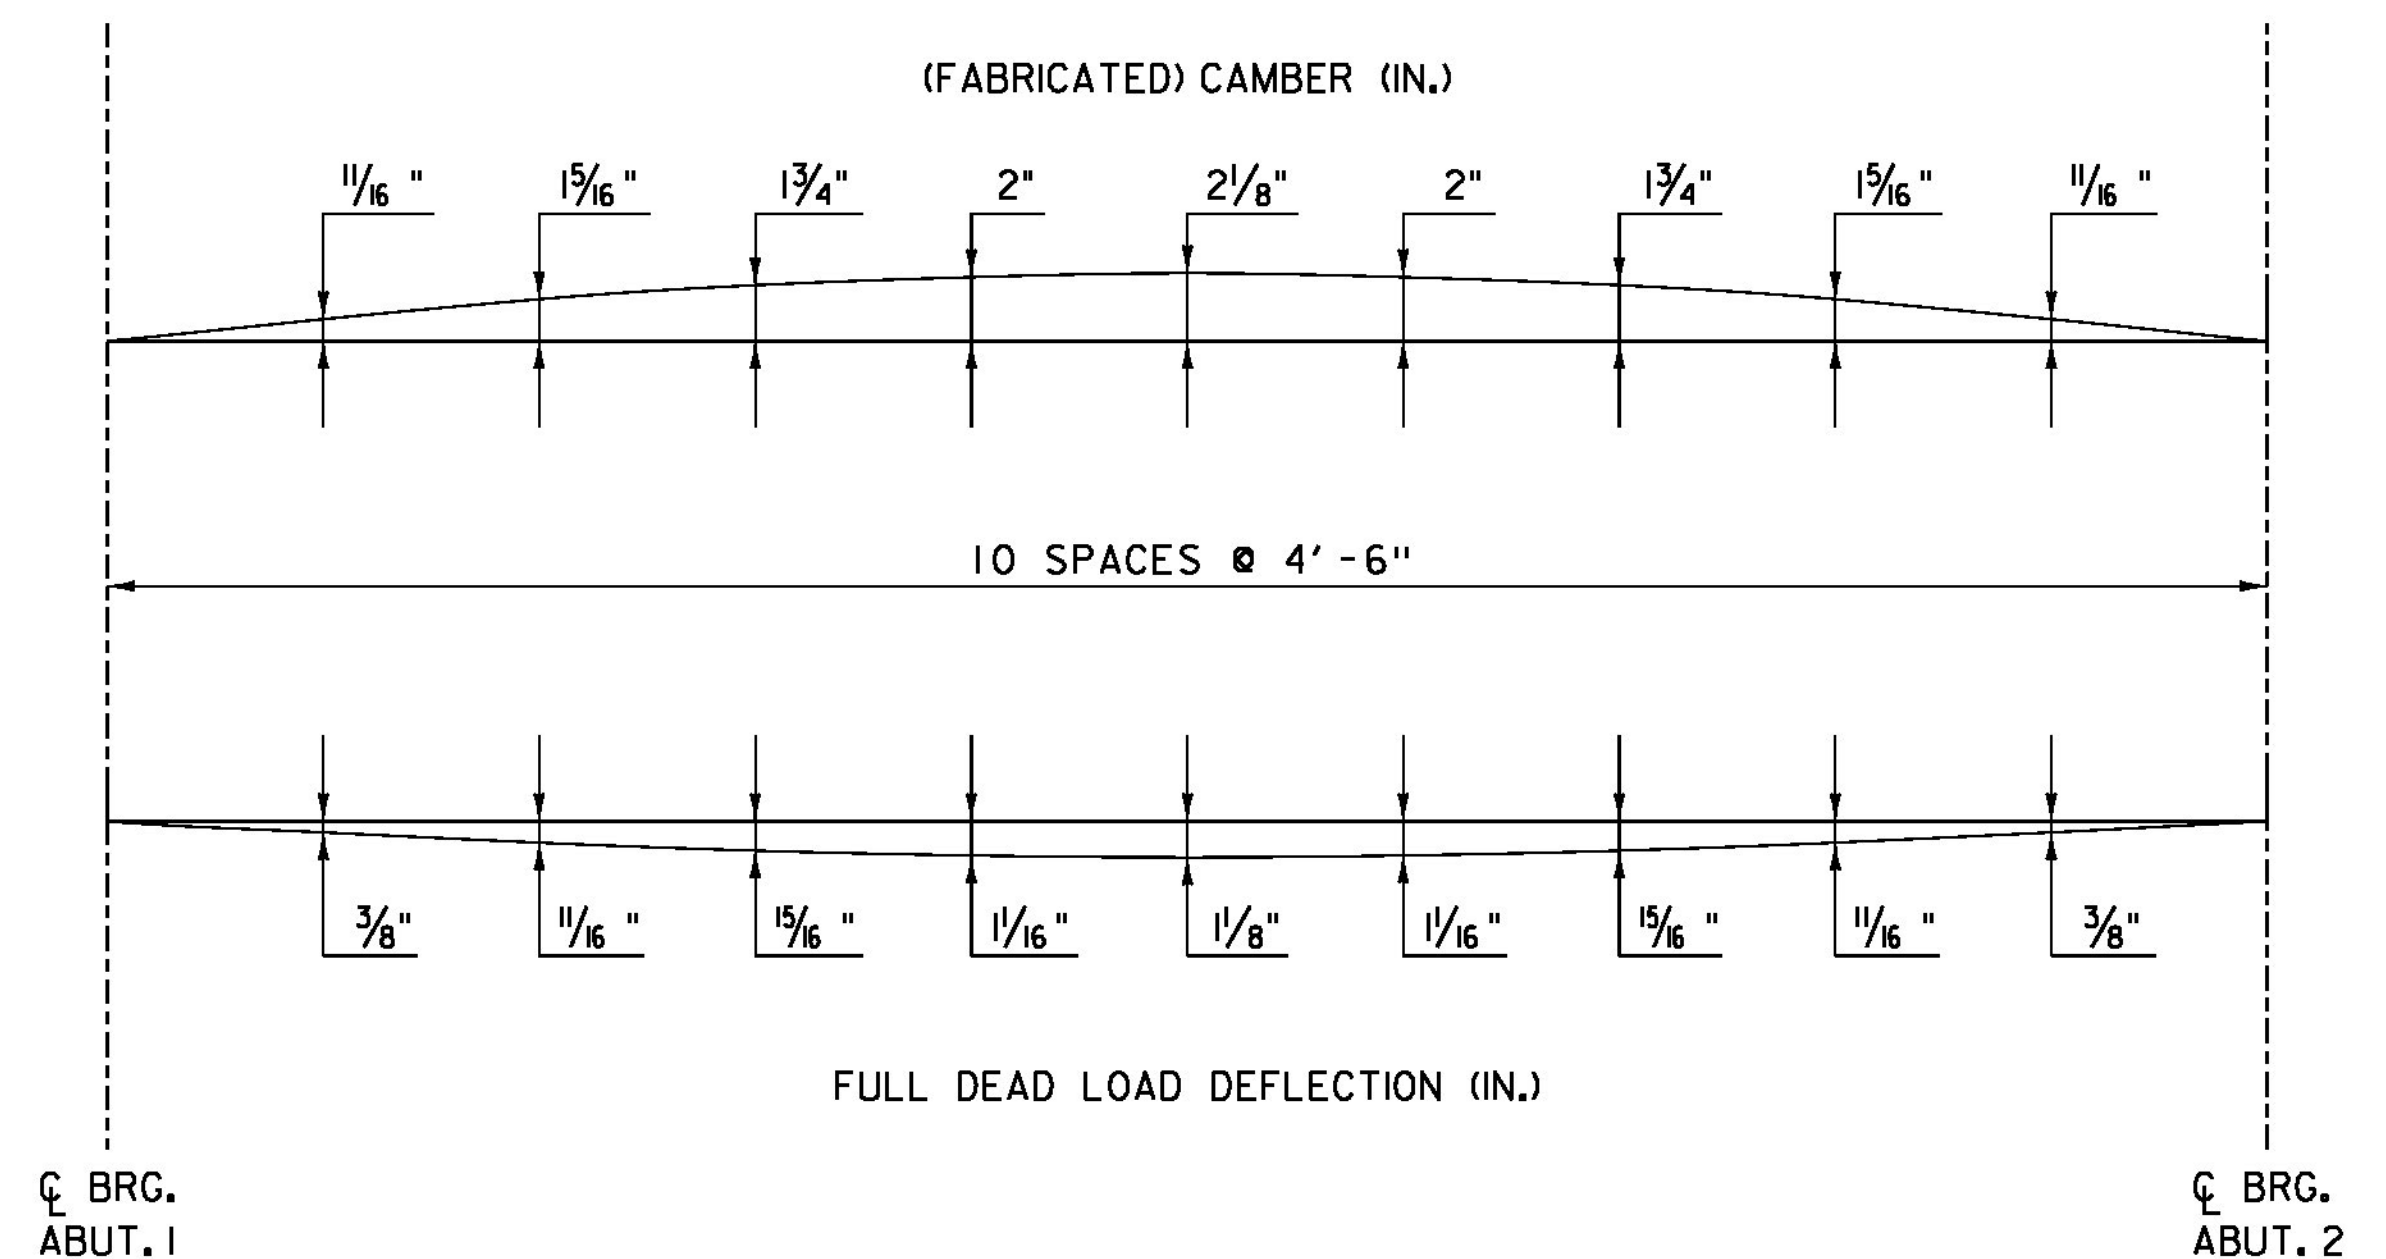

CAMBER AND DEAD LOAD DEFLECTION

HORIZONTAL SCALE 1/4" = 1'-0"
VERTICAL SCALE 2" = 1'-0"

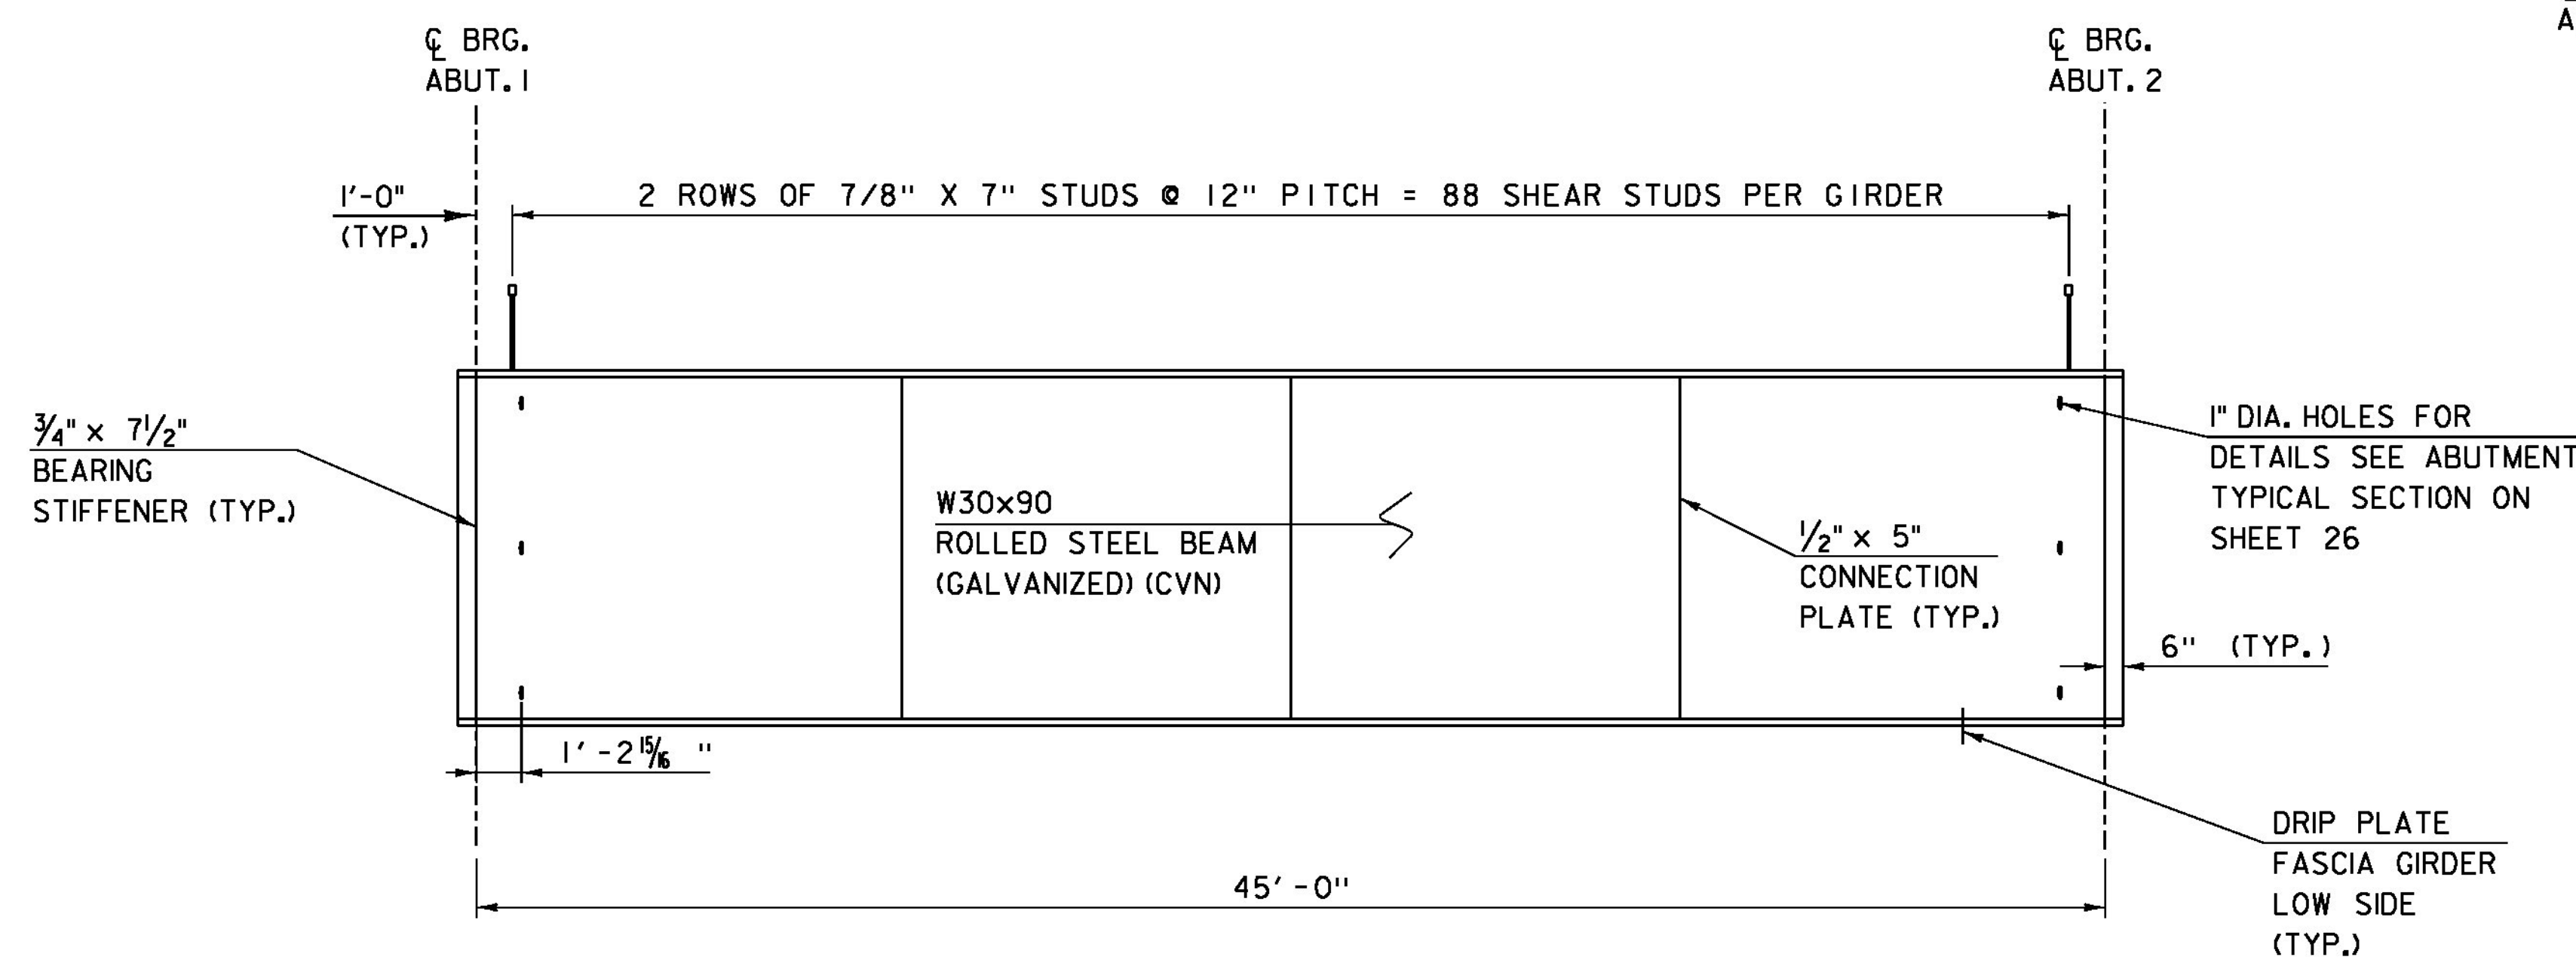

GIRDER ELEVATION
HORIZONTAL SCALE 1/4" = 1'-0"
VERTICAL SCALE 1" = 1'-0"

NOTES:

1. SEE STRUCTURES DETAIL SHEET SD-601 FOR DRIP PLATE DETAILS.
2. SEE STRUCTURES DETAIL SHEET SD-602 FOR DIAPHRAGM, CONNECTION PLATE, AND STIFFENER DETAILS.
3. DEAD LOAD DEFLECTION INCLUDES: BEAM, DIAPHRAGMS, DECK & BRIDGE RAIL.
4. CVN - SHALL MEET CHARPY V-NOTCH REQUIREMENTS FOR MAIN MEMBERS AS SPECIFIED IN SECTION 714.

PROJECT NAME: MIDDLESEX
PROJECT NUMBER: BRF 024-1(37)

FILE NAME: sl0c220sup.dgn
PROJECT LEADER: C. CARLSON
DESIGNED BY: H. SALLS
FRAMING PLAN

PLOT DATE: 13-JAN-2015
DRAWN BY: C. BURRALL
CHECKED BY: H. SALLS
SHEET 21 OF 46