


FRAMING PLAN - SPANS 14 THRU 17
UNIT 4
 Scale: 1" = 20'

- NOTES:**
1. Finished Grade (FG) Elev. is given at top of Bituminous Conc. Pavement. (Profile Grade Line)
 2. For Framing Plan, see Sheet S363.

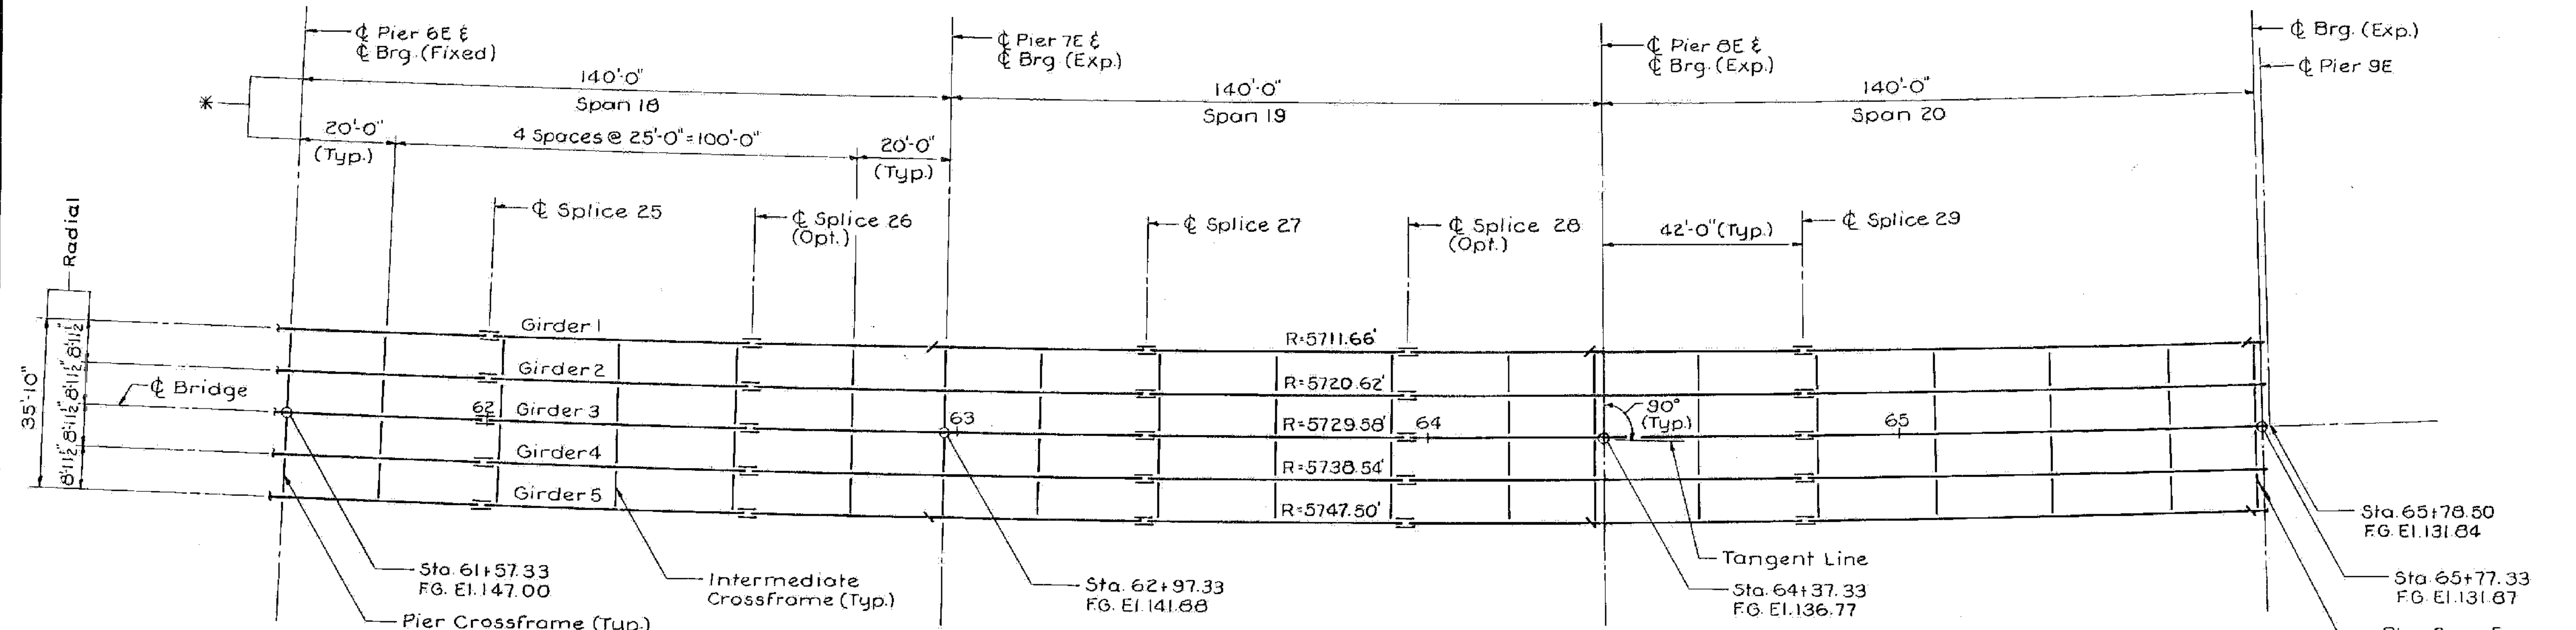

FRAMING PLAN - SPANS 18 THRU 20
UNIT 4
 Scale: 1" = 20'

- NOTES:**
1. * Measured along ϕ Bridge.
 2. All Beams (Spans 14-20) shall be horizontally curved to radii shown.

ALBURGH-ROUSES POINT
 BHF MEMB(24)
 SHEET 32 OF 50
 FOR REFERENCE ONLY

STATE OF VERMONT
AGENCY OF TRANSPORTATION

TOWN OF ROUSES POINT NY ALBURG VT	Bridge No. 1
HIGHWAY NO. ROUTE 2	Log Sta. 0+00
	Surr. Sta.
FRAMING PLAN UNIT 4	
(STEEL ALTERNATE)	
Designed by S.M.	Drawn by R.D.F.
Checked by K.A.C. date 11-1-84	Bridge Design Supervisor C.J.M./S.M. date 11-1-84
PROJECT ROUSES POINT BRIDGE REPLACEMENT	PROJECT NO. BRFC28-1(11)
Bridge Sheet No. S362	Sheet of

