


**SOIL CLASSIFICATION**  
 WINOOSKI VERY FINE SANDY LOAM (Wo)  
 "K FACTOR" = 0.49  
 CLASSIFIED HIGH EROSION POTENTIAL

**LEGEND**

- AER E&T — AERIAL ELECTRIC & TELEPHONE
- DISTURBED AREAS REQUIRING RE-VEGETATION
- EROSION MATTING
- LIMITS OF SOIL DISTURBANCE
- RIPARIAN BUFFER ZONE

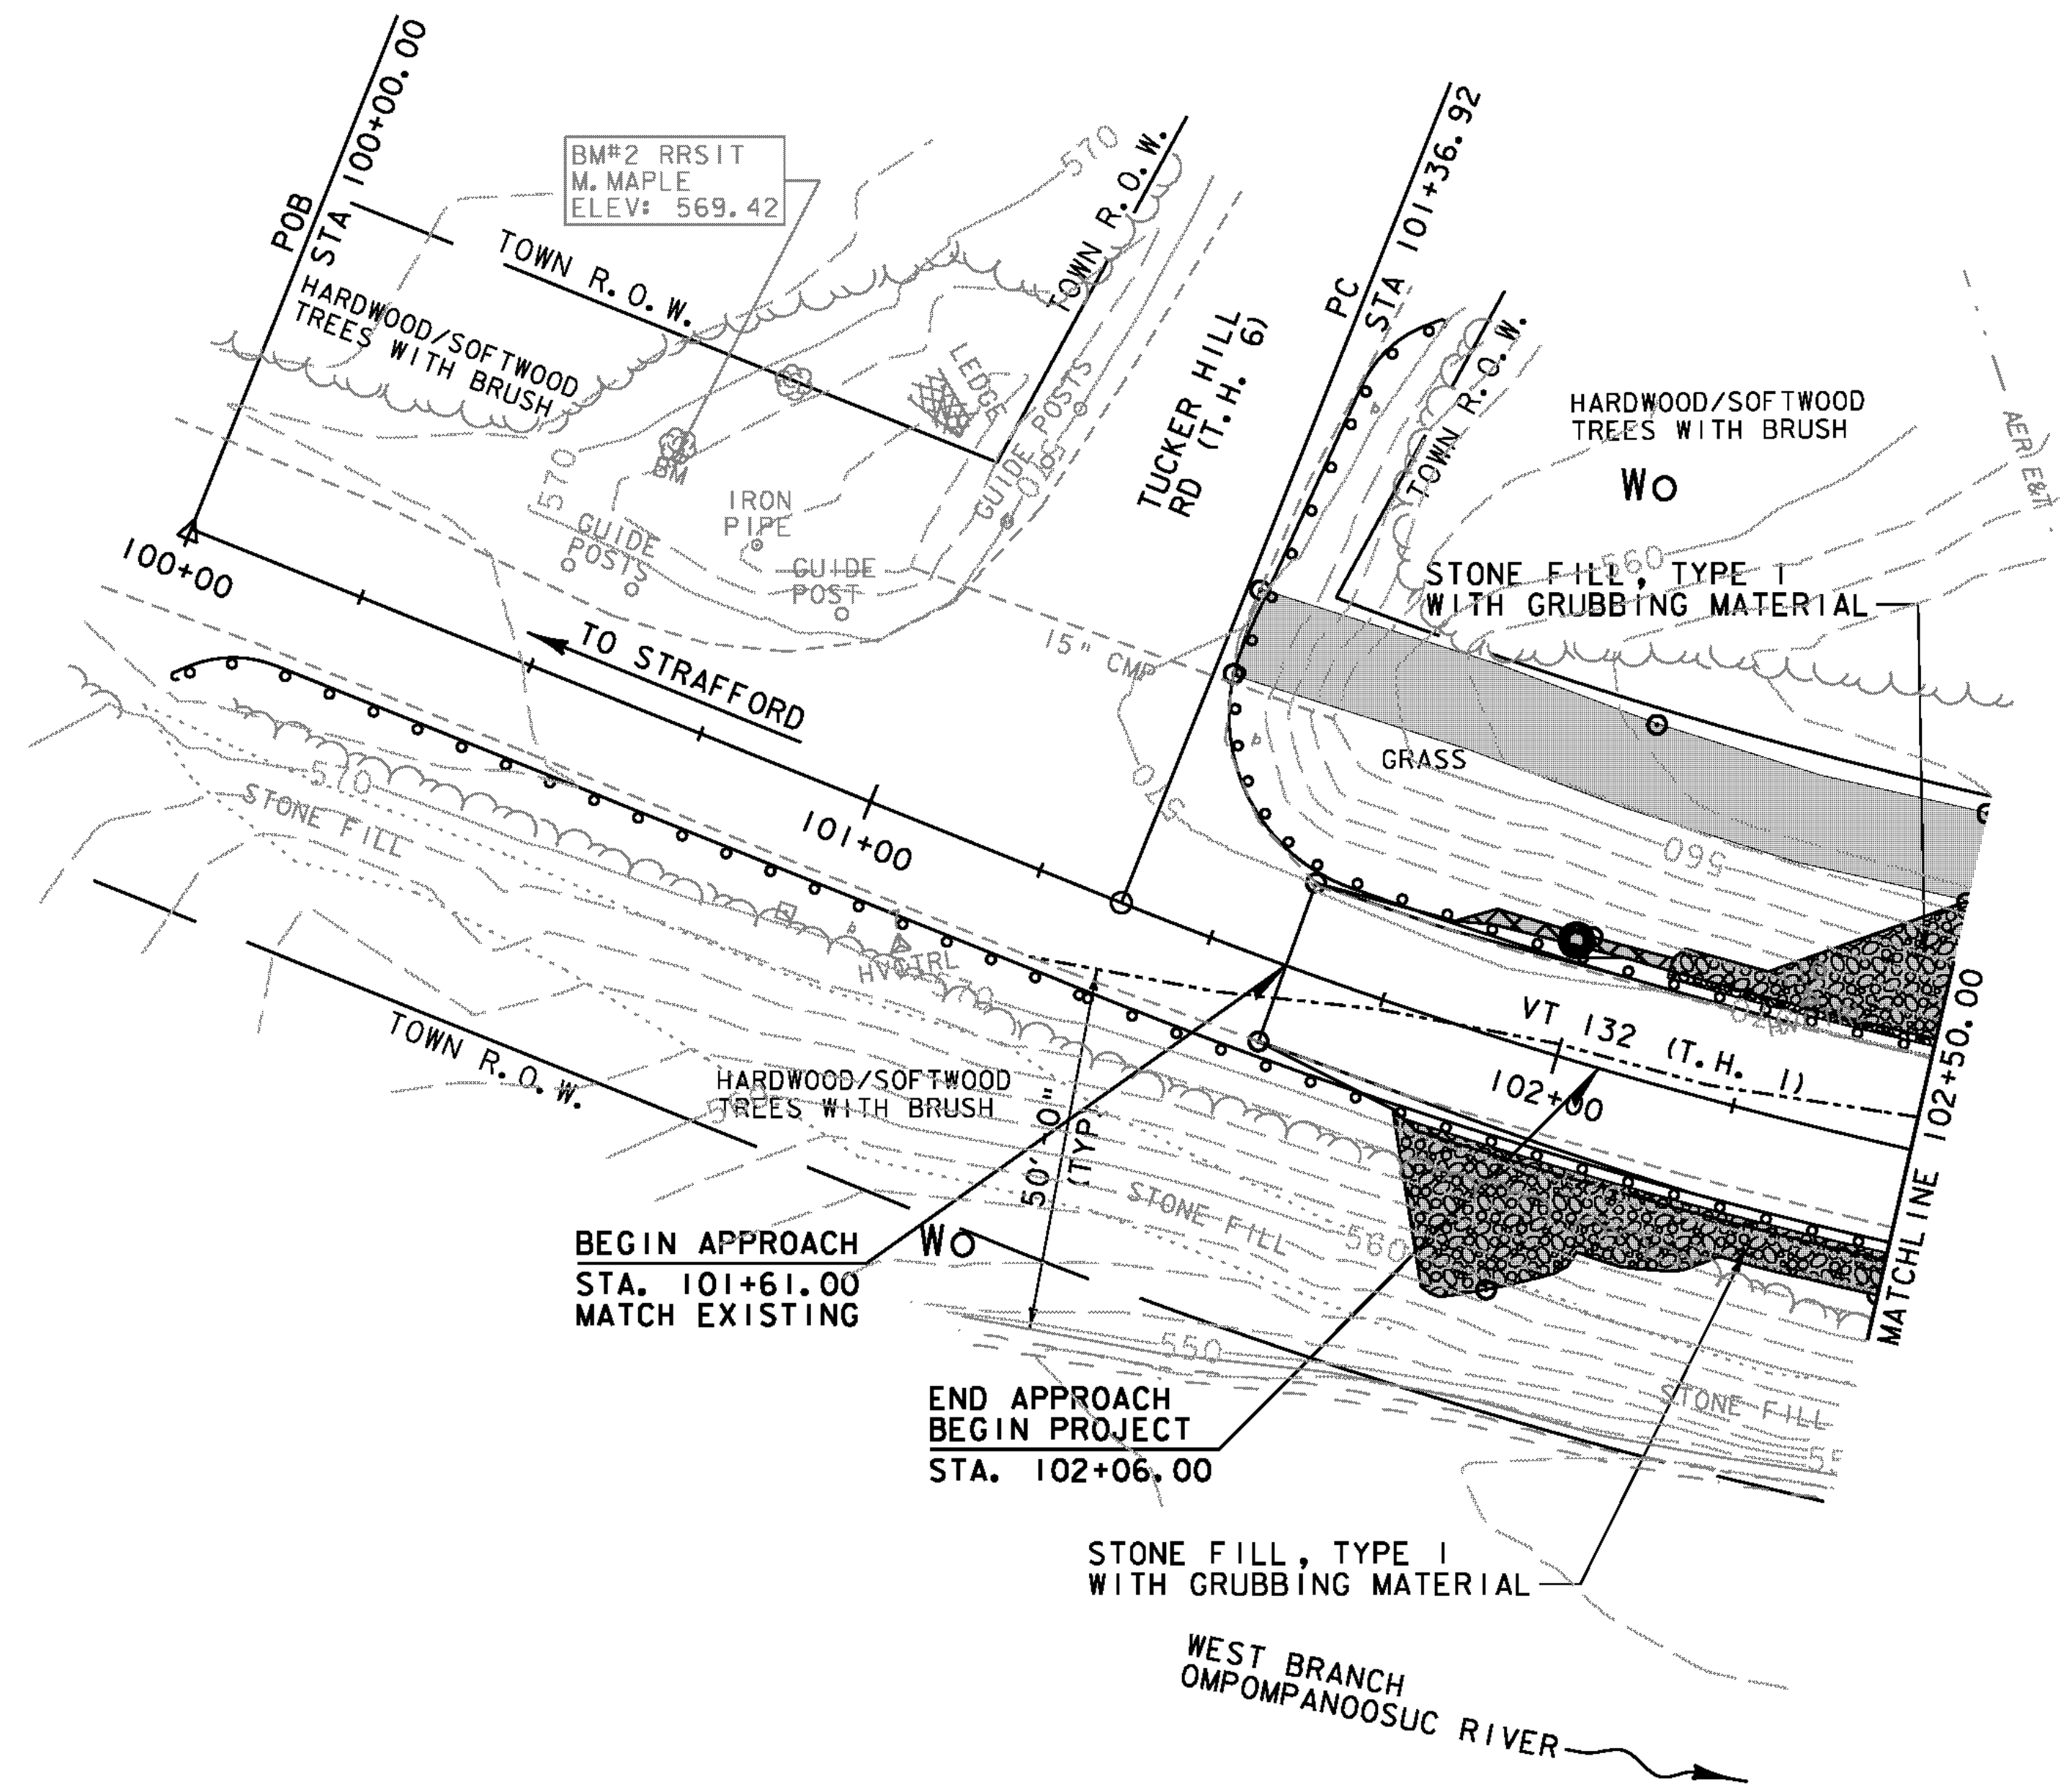

**NOTE:** FOR FINAL GRADE SEE PROFILE ON SHEETS 13 AND 14 AND ROADWAY CROSS SECTIONS ON SHEETS 64 THRU 66.

DATUM  
 VERTICAL NAVD 88  
 HORIZONTAL NAD 83 (92)

SCALE 1" = 20' - 0  
 20 0 20



PROJECT NAME: THETFORD	
PROJECT NUMBER: BHF 0177(9)	
FILE NAME: z08j174bdr_ero.dgn	PLOT DATE: 2/15/2012
PROJECT LEADER: M.A. COLGAN	DRAWN BY: B.M. KLINEFELTER
DESIGNED BY: S.E. BURBANK	CHECKED BY: S.E. BURBANK
EPSC FINAL COND. SITE PLAN (1 OF 2)	SHEET 20 OF 78