


SOIL CLASSIFICATION

WINOOSKI VERY FINE SANDY LOAM (Wo)
 "K FACTOR" = 0.49
 CLASSIFIED HIGH EROSION POTENTIAL

LEGEND	
	WOVEN WIRE REINFORCED SILT FENCE
	LIMITS OF SOIL DISTURBANCE
	EROSION MATTING
	PROJECT DEMARCATION FENCE
	RIPARIAN BUFFER ZONE
	AERIAL ELECTRIC & TELEPHONE
	STABILIZED CONSTRUCTION ENTRANCE

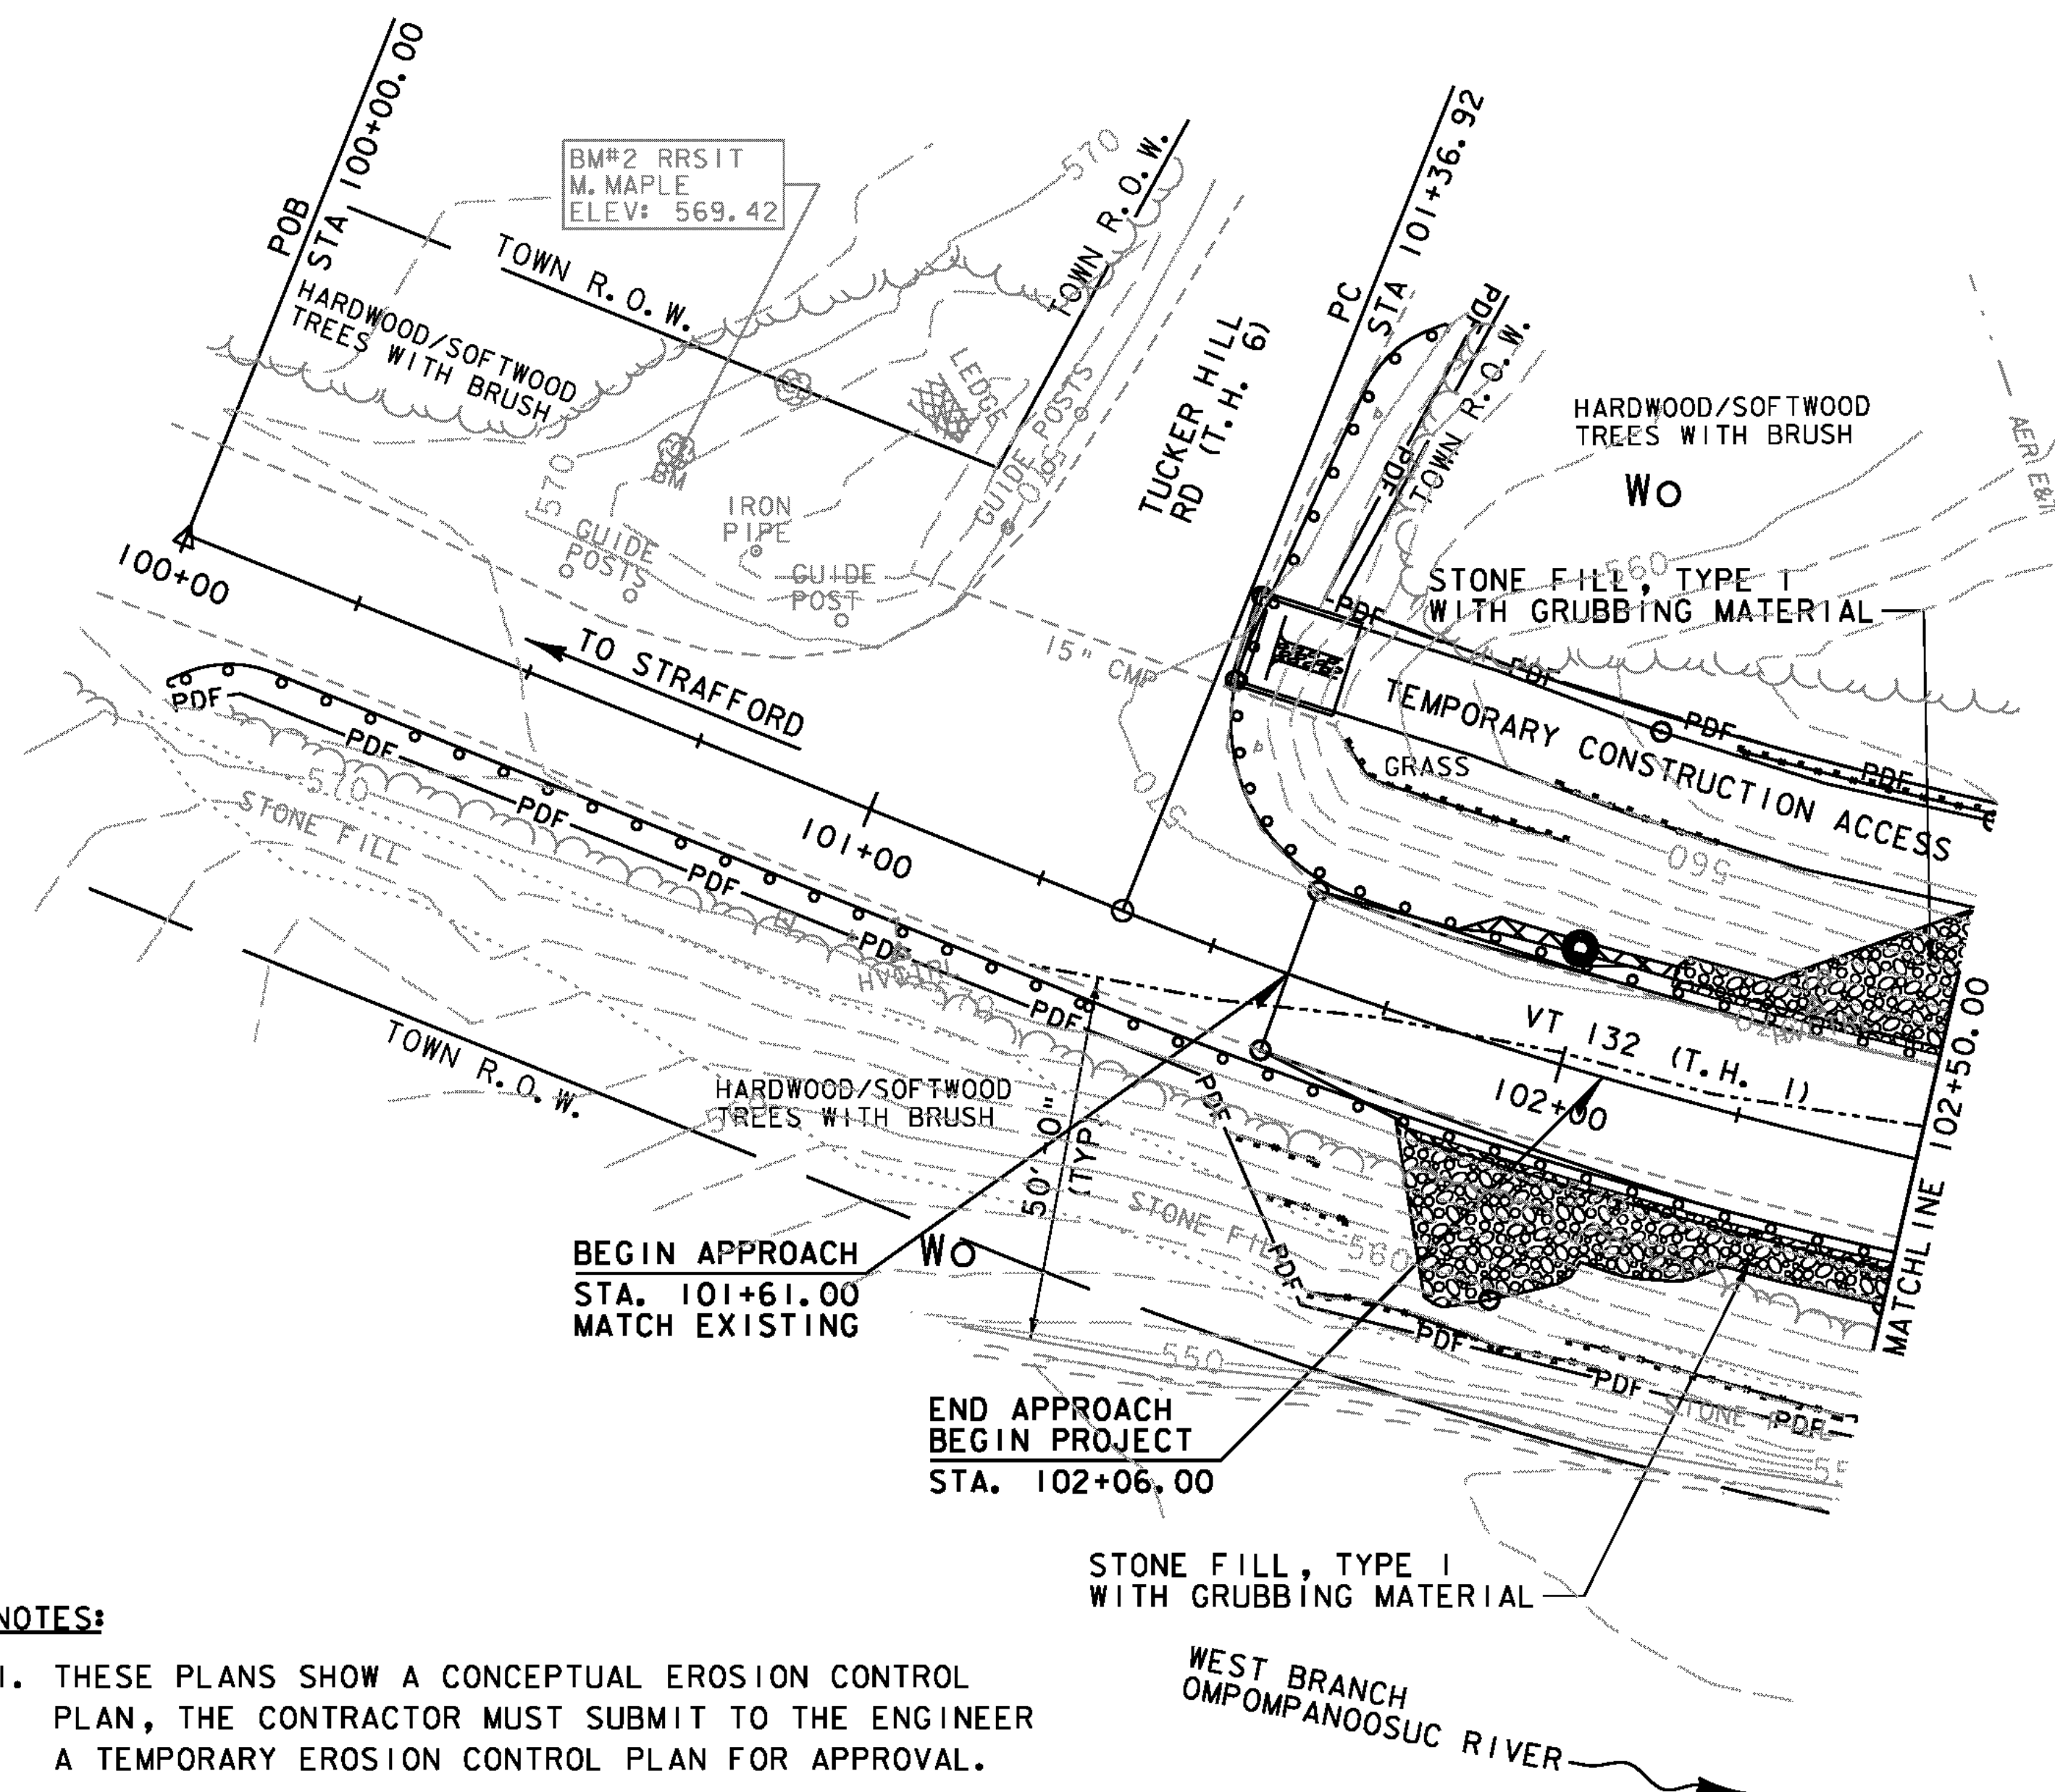

NOTES:

1. THESE PLANS SHOW A CONCEPTUAL EROSION CONTROL PLAN, THE CONTRACTOR MUST SUBMIT TO THE ENGINEER A TEMPORARY EROSION CONTROL PLAN FOR APPROVAL.
2. TEMPORARY EROSION CONTROL MEASURES ARE CONCEPTUALLY SHOWN. THE CONTRACTOR MAY RELOCATE TEMPORARY MEASURES TO IMPROVE EROSION CONTROL WITH APPROVAL OF THE RESIDENT ENGINEER AND ON-SITE COORDINATOR. SILT FENCE SHALL NOT BE INSTALLED ACROSS CONTOURS.
3. THE CONTRACTOR SHALL USE OTHER TEMPORARY EROSION CONTROL MEASURES AS NECESSITATED BY THE SEQUENCE OF CONSTRUCTION OR AS DIRECTED BY THE RESIDENT ENGINEER AND ON-SITE COORDINATOR.
4. REFER TO TEMPORARY EROSION CONTROL DETAIL SHEETS FOR ADDITIONAL DETAILS.

DATUM	
VERTICAL	NAVD 88
HORIZONTAL	NAD 83 (92)

SCALE 1" = 20' -0
 20 0 20



PROJECT NAME: THETFORD	
PROJECT NUMBER: BHF 0177(9)	
FILE NAME: z08j174bdr_ero.dgn	PLOT DATE: 2/15/2012
PROJECT LEADER: M.A. COLGAN	DRAWN BY: B.M. KLINEFELTER
DESIGNED BY: S.E. BURBANK	CHECKED BY: S.E. BURBANK
EPSC CONSTRUCTION SITE PLAN (1 OF 2)	SHEET 18 OF 78