


\* ALL DIMENSIONS ARE ALONG THE EXTERIOR GIRDER.



### FRAMING PLAN

SCALE 1:125

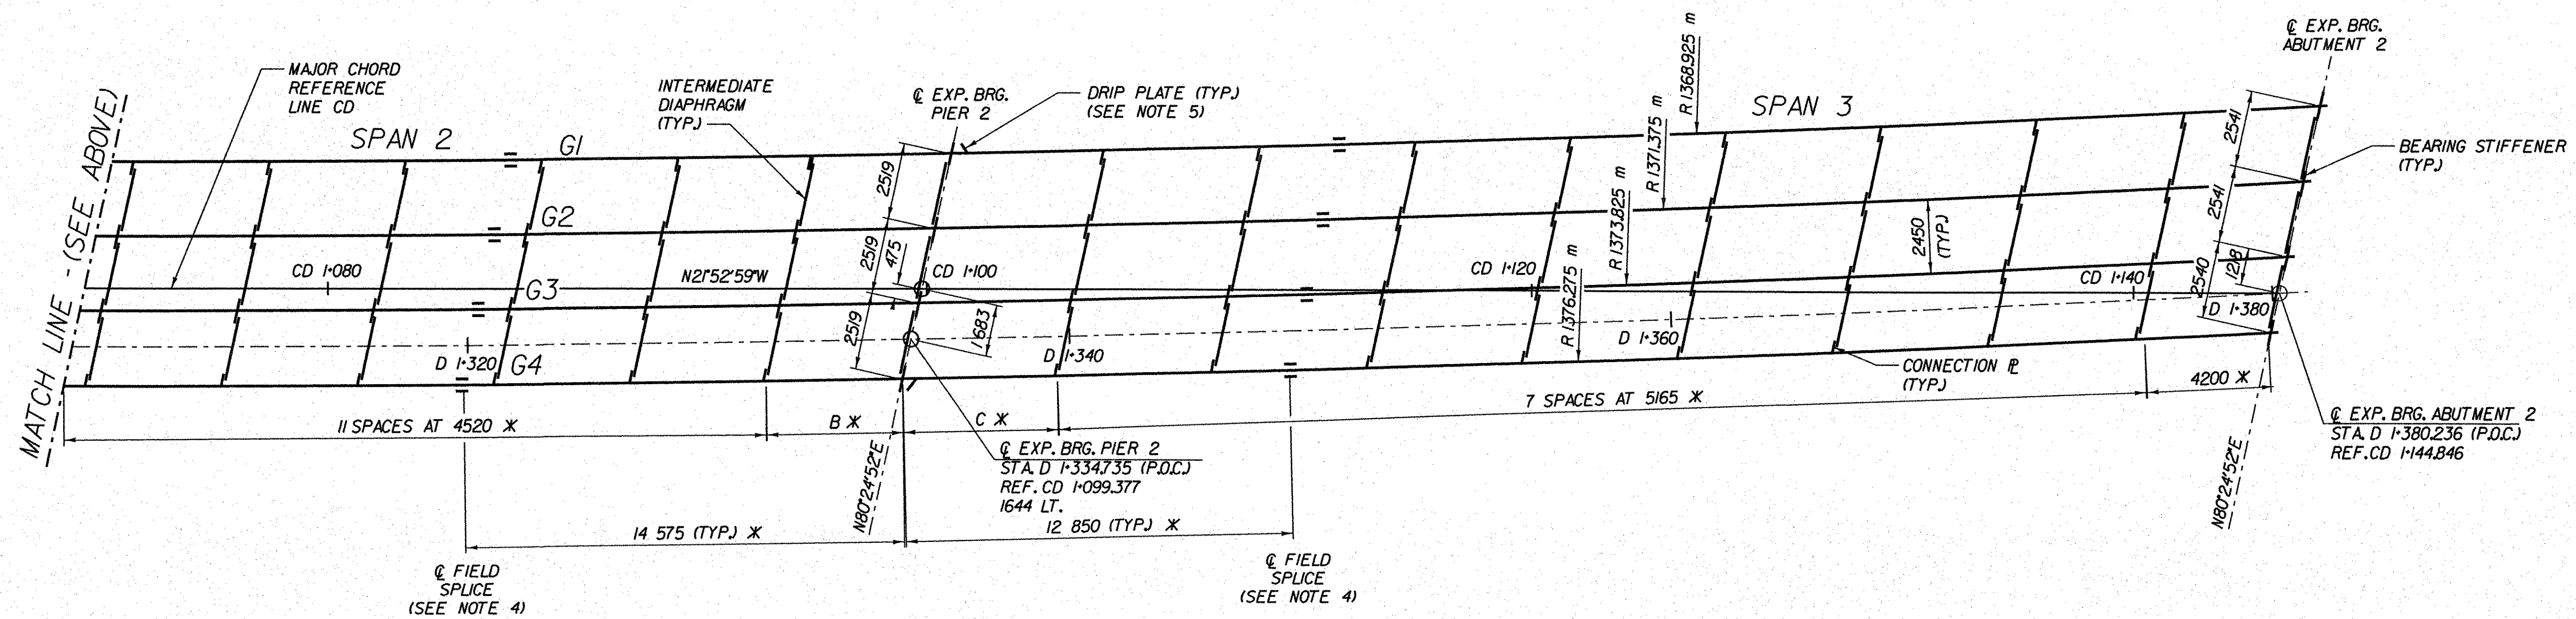

SCALE 1:125

GIRDER DIAPHRAGM SPACING (m)			
GIRDER	A	B	C
G1	5.118	4.553	5.159
G2	5.115	4.648	5.154
G3	5.112	4.543	5.149
G4	5.110	4.538	5.143

#### NOTES:

- FOR ADDITIONAL HORIZONTAL AND VERTICAL CURVE DATA, SEE ROADWAY PLANS.
- FOR LAYOUT DIAGRAM, SEE FRAMING PLAN (SHEET 2 OF 2) (RAMP D), BRIDGE SHEET BR286.
- FOR PLATE GIRDER AND DIAPHRAGM DETAILS, SEE STEEL DETAILS (RAMPS A AND D), BRIDGE SHEETS BR269 AND BR270.
- FOR FIELD SPLICE DETAILS, SEE SPLICE DETAILS (RAMPS A AND D), BRIDGE SHEET BR268.
- FOR DRIP PLATE DETAILS, SEE TYPICAL STEEL DETAILS (SHEET 1 OF 2) (RAMPS A AND D), BRIDGE SHEET BR269.
- FOR SCUPPER DETAILS, SEE TYPICAL SCUPPER DETAILS, BRIDGE SHEET BR309.

**TVGA**  
CONSULTANTS

### STATE OF VERMONT AGENCY OF TRANSPORTATION

Town Of **BENNINGTON** Bridge No. **B15N**  
 Highway No. **VT 279** Log Sta. \_\_\_\_\_  
 Surv. Sta. \_\_\_\_\_  
 VT ROUTE 279 & RAMPS OVER ROARING BRANCH OF WALLOMSAC RIVER

#### FRAMING PLAN (SHEET 1 OF 2) (RAMP D)

Designed By **J.J. MANUSE** Drawn By **D. S. URBINO**  
 Checked By **B.J. CARLSON** Date **06/08** Bridge Design Supervisor **K.M. WOJTKOWSKI** Date **06/08**  
 PROJECT **BENNINGTON** PROJECT NO. **AC NH 019-1(51)**  
 TVGA CAD Drawing No. **RmpDFrm.dgn** Date **02/02/2009**  
 Bridge Sheet No. **BR285** Sheet **272** of **367**