


\* ALL DIMENSIONS ARE ALONG THE EXTERIOR GIRDER.

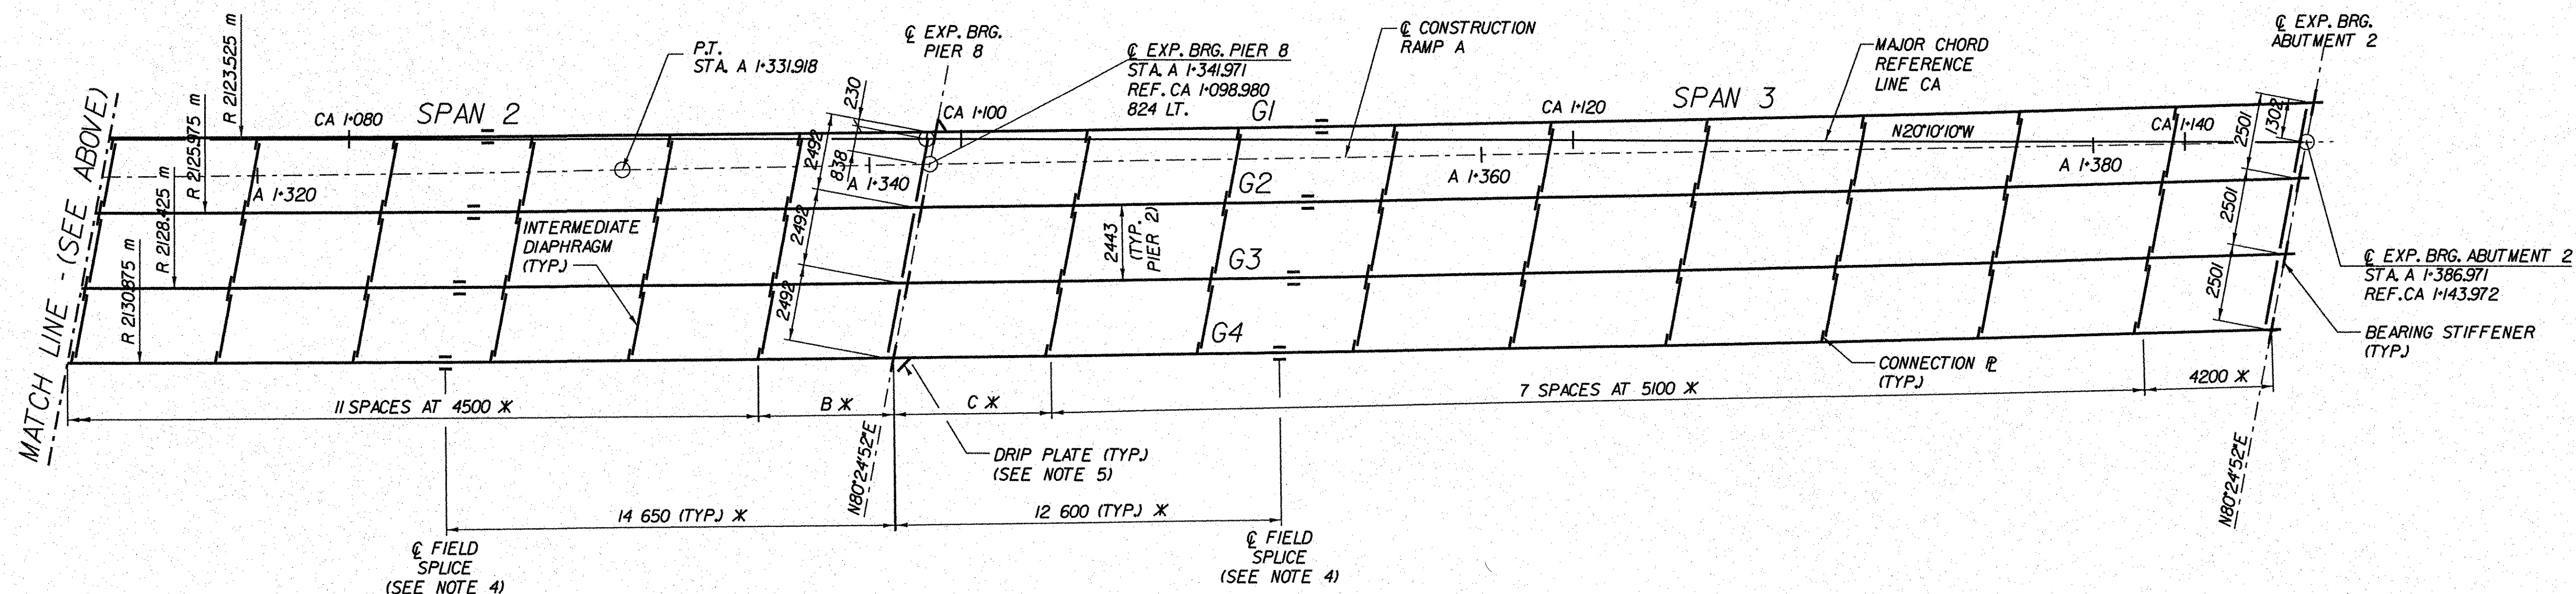

### FRAMING PLAN

1:125



SCALE 1:125

#### GIRDER DIAPHRAGM SPACING (m)

GIRDER	A	B	C
G1	5.120	4.433	5.149
G2	5.118	4.432	5.146
G3	5.117	4.431	5.144
G4	5.115	4.428	5.142

#### NOTES:

- FOR ADDITIONAL HORIZONTAL AND VERTICAL CURVE DATA, SEE ROADWAY PLANS.
- FOR LAYOUT DIAGRAM, SEE FRAMING PLAN (SHEET 2 OF 2) (RAMP A), BRIDGE SHEET BR265.
- FOR PLATE GIRDER AND DIAPHRAGM DETAILS, SEE STEEL DETAILS (RAMPS A AND D), BRIDGE SHEETS BR269 AND BR270.
- FOR FIELD SPLICE DETAILS, SEE SPLICE DETAILS (RAMPS A AND D), BRIDGE SHEET BR268.
- FOR DRIP PLATE DETAILS, SEE TYPICAL STEEL DETAILS (SHEET 1 OF 2) (RAMPS A AND D), BRIDGE SHEET BR269.
- FOR SCUPPER DETAILS, SEE TYPICAL SCUPPER DETAILS, BRIDGE SHEET BR309.
- GIRDERS ARE NOT CONCENTRIC.

### STATE OF VERMONT AGENCY OF TRANSPORTATION

Town Of	BENNINGTON	Bridge No.	BI55
Highway No.	VT 279	Log Sta.	
		Surv. Sta.	
VT ROUTE 279 & RAMPS OVER ROARING BRANCH OF WALLOWMASC RIVER			
<b>FRAMING PLAN (SHEET 1 OF 2) (RAMP A)</b>			
Designed By	J.J. MANUSE	Drawn By	D.S. URBINO
Checked By	B.J. CARLSON	Date	03/08
		Bridge Design Supervisor	K.M. WOJTKOWSKI
		Date	03/08
PROJECT	BENNINGTON	PROJECT NO.	AC NH 019-1(51)
TVGA CAD Drawing No.	RmpAFrm.dgn	Date	02/02/2009
Bridge Sheet No.	BR264	Sheet	251 of 367