
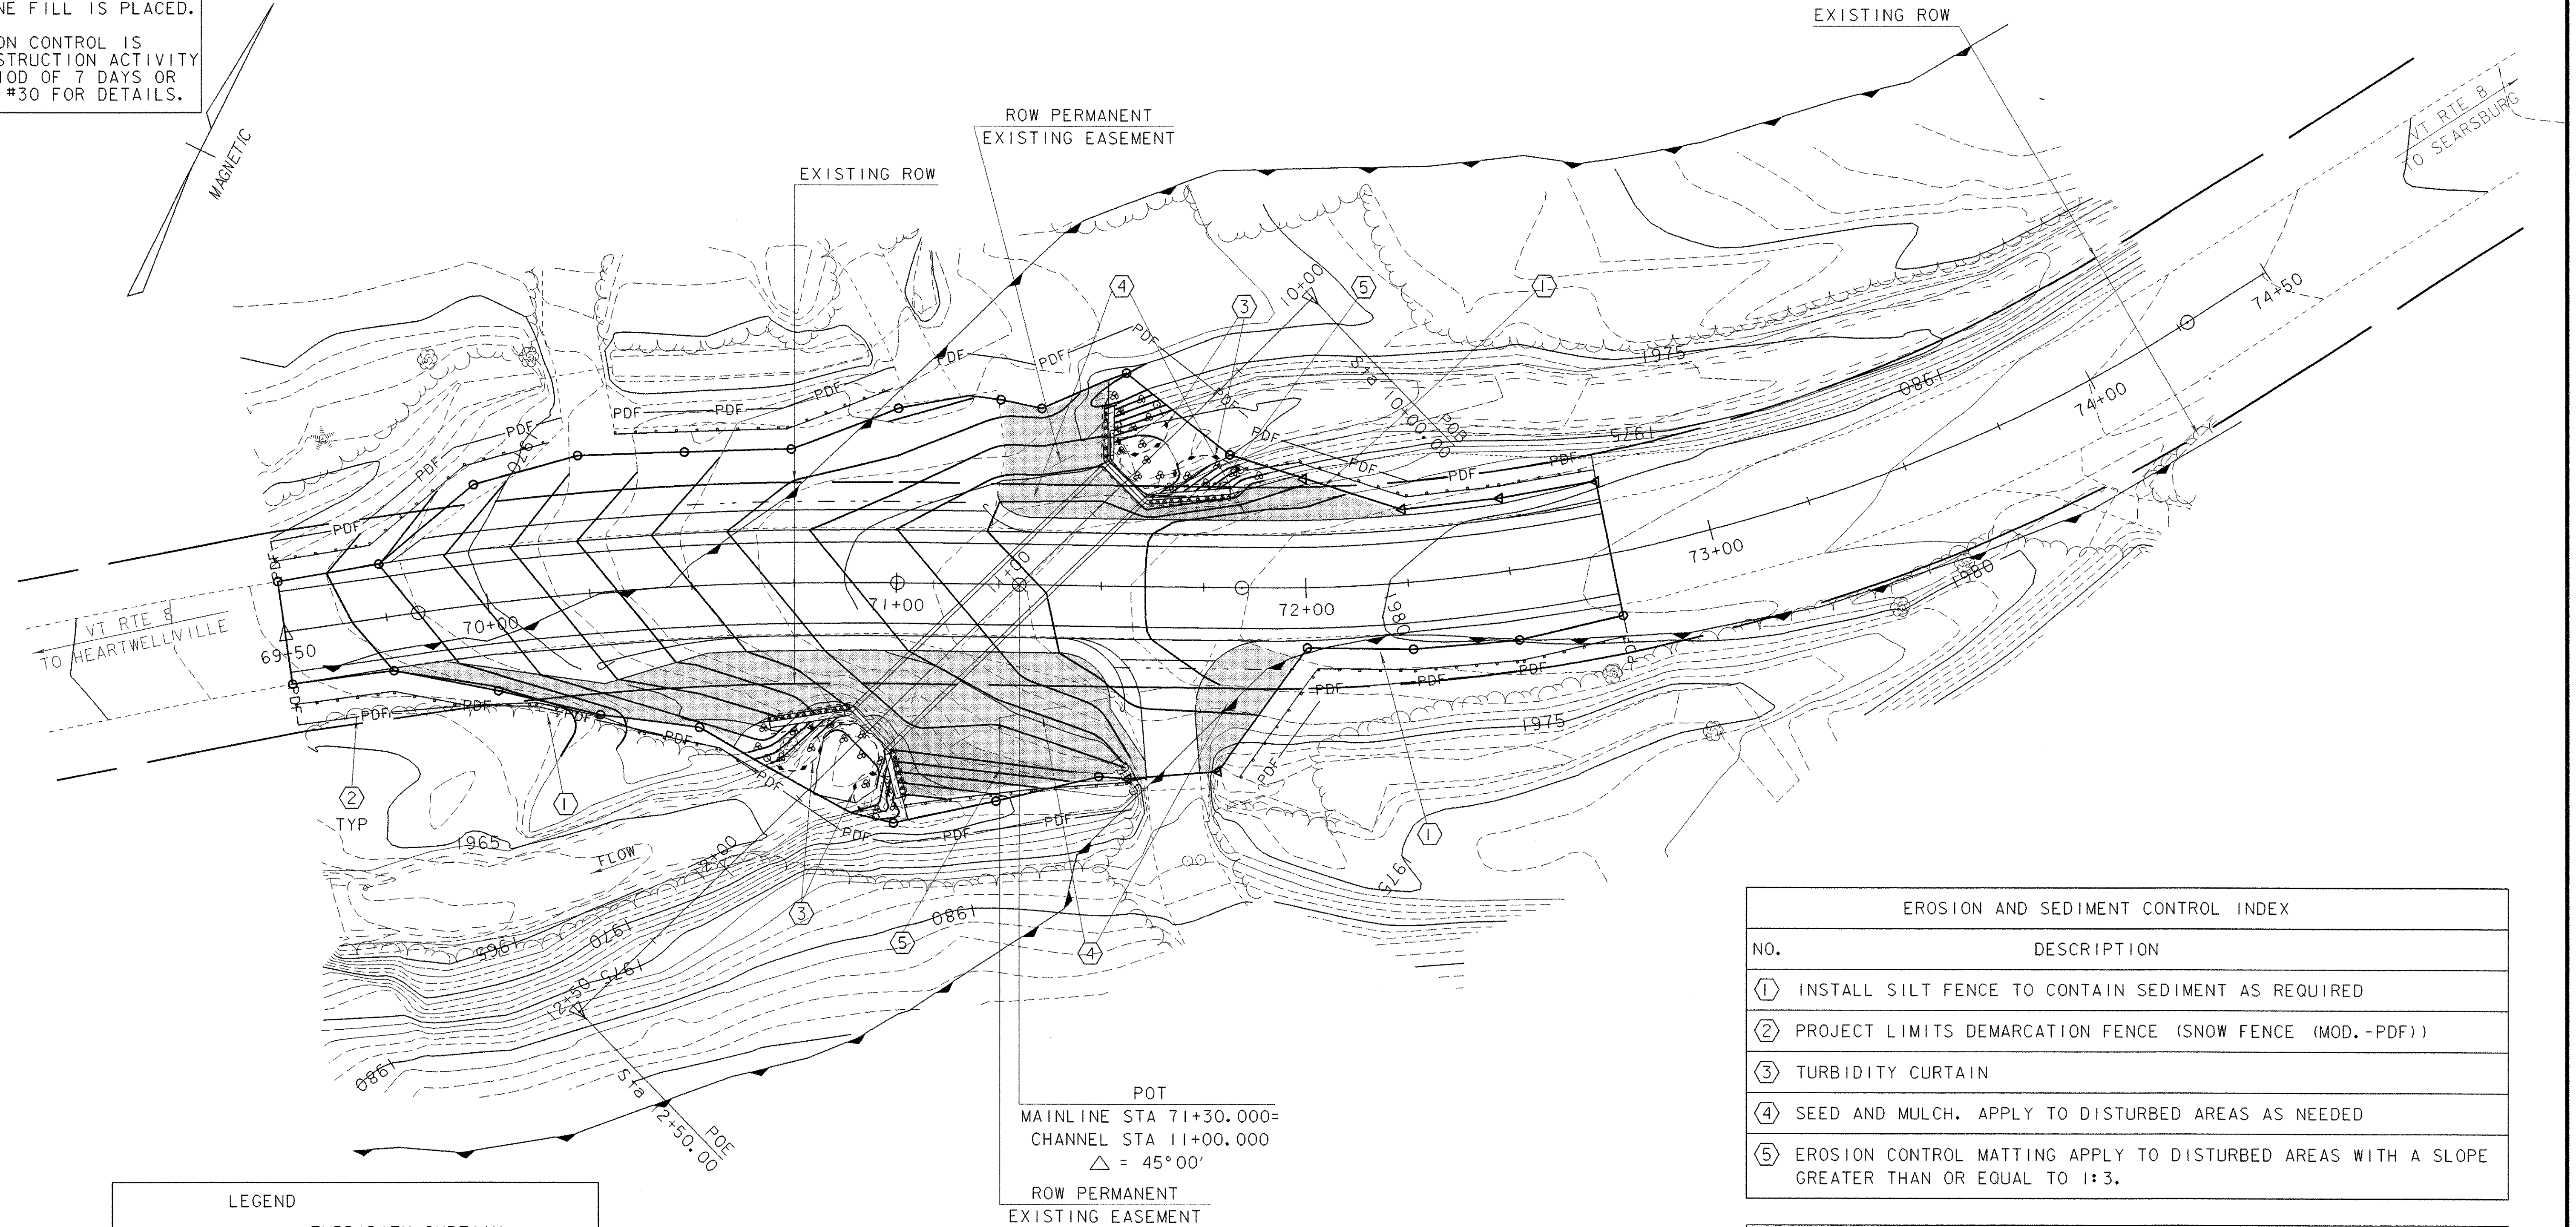


**NOTES**

1. INSTALL SILT FENCE TO CONTROL SEDIMENT FROM DISTURBED SOILS. INSTALL WHEN NEEDED.
2. SEED AND MULCH DISTURBED AREAS AS REQUIRED. SEE EROSION CONTROL NOTES ON SHEET #30.
3. INSTALL EROSION CONTROL MATTING ON DISTURBED SLOPES GREATER THAN OR EQUAL TO 1:3. NOT REQUIRED ON AREAS WHERE STONE FILL IS PLACED.
4. TEMPORARY EROSION CONTROL IS NEEDED WHEN CONSTRUCTION ACTIVITY STOPS FOR A PERIOD OF 7 DAYS OR MORE. SEE SHEET #30 FOR DETAILS.

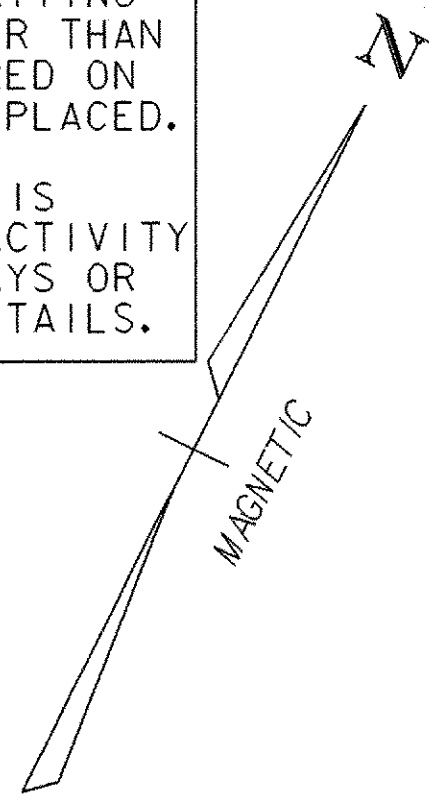

LEGEND	
	TURBIDITY CURTAIN
	RIPARIAN BUFFER ZONE
	PROJECT DEMARCATION FENCE
	SILT FENCE
	SEED AND MULCH
	EROSION CONTROL MATTING

DATUM	
VERTICAL	NAVD 88
HORIZONTAL	ASSUMED

**EROSION PREVENTION & SEDIMENT CONTROL PLAN**

SCALE 1" = 20'-0"

EROSION AND SEDIMENT CONTROL INDEX	
NO.	DESCRIPTION
①	INSTALL SILT FENCE TO CONTAIN SEDIMENT AS REQUIRED
②	PROJECT LIMITS DEMARCATION FENCE (SNOW FENCE (MOD. -PDF))
③	TURBIDITY CURTAIN
④	SEED AND MULCH. APPLY TO DISTURBED AREAS AS NEEDED
⑤	EROSION CONTROL MATTING APPLY TO DISTURBED AREAS WITH A SLOPE GREATER THAN OR EQUAL TO 1:3.

NOTE: ALL DISTURBED AREAS WITH SLOPES GREATER THAN 1:3 WILL REQUIRE TEMPORARY EROSION CONTROL MATTING. SEE EROSION CONTROL DETAILS SHEET AND CROSS SECTIONS.

PROJECT: <b>READSBORO</b>	PROJECT NO.: <b>ST CULV (4)</b>
DESIGN FILE NAME: 04c176/structures/s04c176bdr_ero.dgn	PLOT DATE: 18-JUL-2006
IPARM FILE NAME: s04c176ero.i	SURVEY DATE: 11/2004
SURVEYED BY: L. ORVIS	DRAWN BY: M. FESSEL
SQUAD LEADER: C.P. WILLIAMS	SHEET: 32 OF 39
EROSION & SEDIMENT CONTROL PLAN	