

NOTE:  
 SODDING SHALL BE APPLIED IMMEDIATELY ON ALL LAWNS DISTURBED BY CONSTRUCTION,  
 OR AS DIRECTED BY THE ENGINEER. ALL CONSTRUCTION SHALL BE PERFORMED FROM  
 THE ROADWAY OUT. OUTSIDE OF THE ROADWAY EXCAVATION ALL NEW CONSTRUCTED  
 SLOPES SHALL BE SEALED WITH 4" OF TOPSOIL AND MULCHED AT THE END OF EACH WORKDAY  
 IN ACCORDANCE WITH THE SPECIFICATION AND PLANS.


# EROSION CONTROL LAYOUT



### GEOTEXTILE FOR SILT FENCE

STA. 15+30 ~ 19+00 RT.  
 STA. 19+47 ~ 20+51 RT.  
 STA. 20+96 ~ 21+09 RT.  
 STA. 19+27 ~ 20+09 LT.  
 STA. 20+57 ~ 21+05 LT.

### ROCK BARRIER INLET PROTECTION STA 18+57 LT UNPAVED AREA

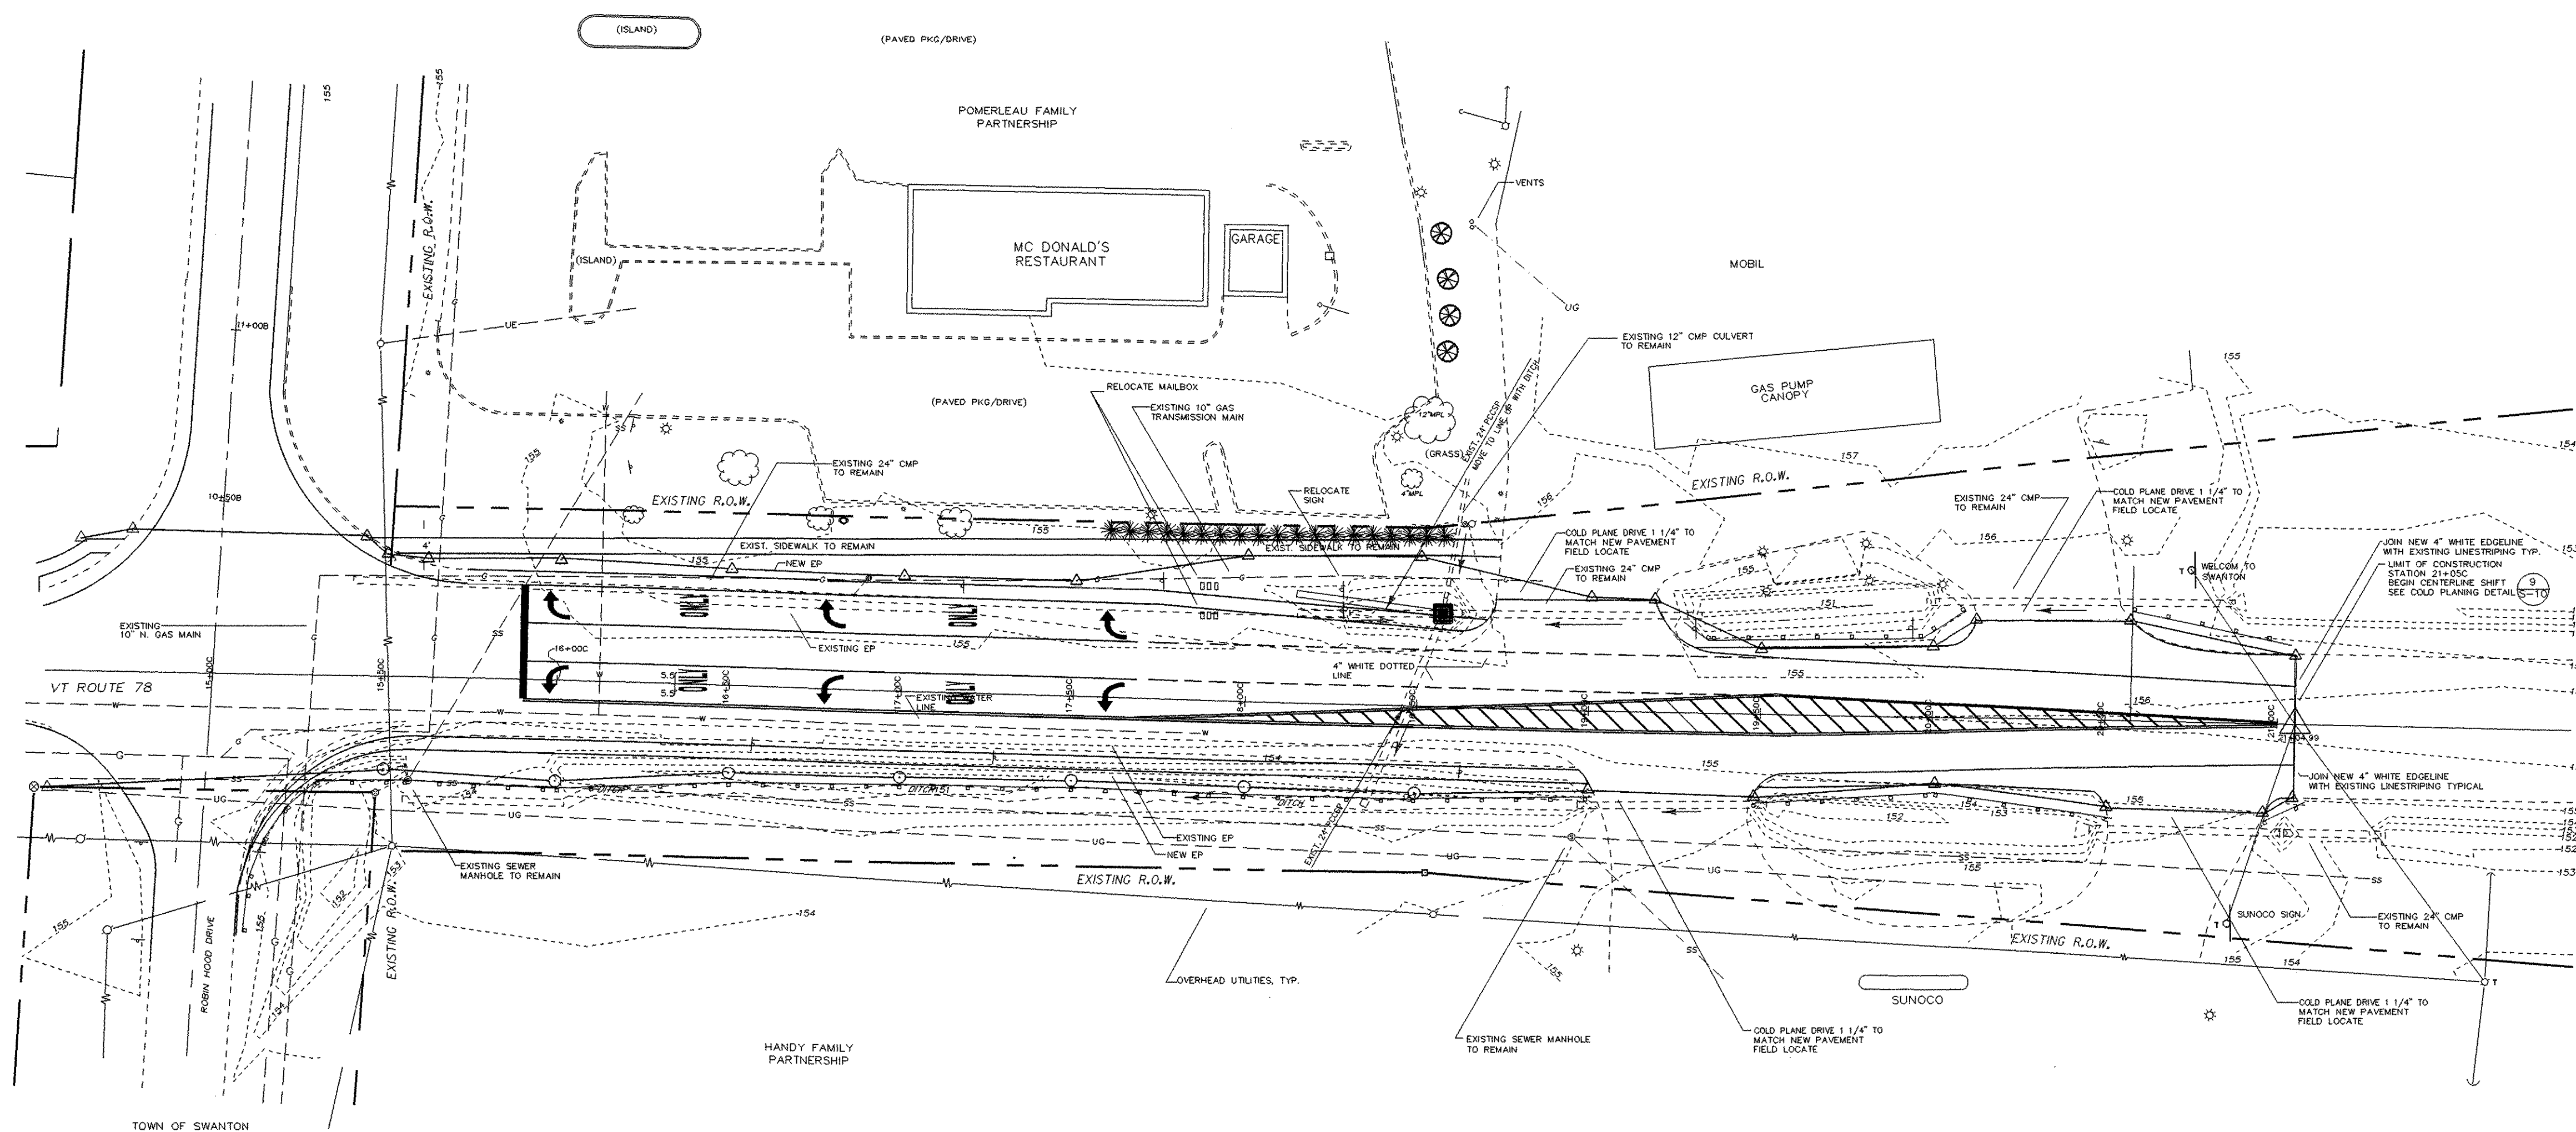

VT 78 East

### LEGEND

- = ROCK BARRIER INLET PROTECTION UNPAVED AREA
- = ROCK BARRIER INLET PROTECTION PAVED AREA
- = SILT FENCE

SCALE 1" = 30'-0"

### EROSION CONTROL SHEET

PROJECT NAME:	SWANTON
PROJECT NUMBER:	STPG ST 036-1(11)
FILE NAME:	PW:00b150/traffic/layout2.dgn
PROJECT LEADER:	B. NYQUIST
DESIGNED BY:	TRAFFIC DESIGN
PLOT DATE:	19-APR-2006
DRAWN BY:	TRAFFIC DESIGN
CHECKED BY:	TRAFFIC DESIGN
SHEET	31 OF 45