

REMOVING AND RESETTING CURB
10+64.5 LT. - 14+00.0 LT.



PORTLAND CEMENT CONCRETE SIDEWALK, 5 INCH
10+64.5 LT. - 14+00.0 LT.

CONCRETE FACE EXISTING CONCRETE RETAINING WALL
10+72.0 LT. - 10+90.0 LT.

CONCRETE FACE EXISTING METAL BIN RETAINING WALL
10+90.0 LT. - 14+00.0 LT.

BEGIN R. O. W. PROJECT

STP 016-2(10) S STA. 10+59.682 RT.
26.0' LT.

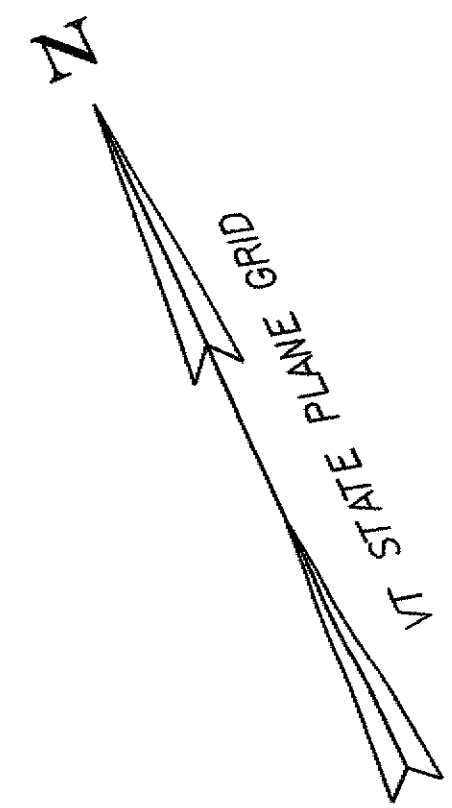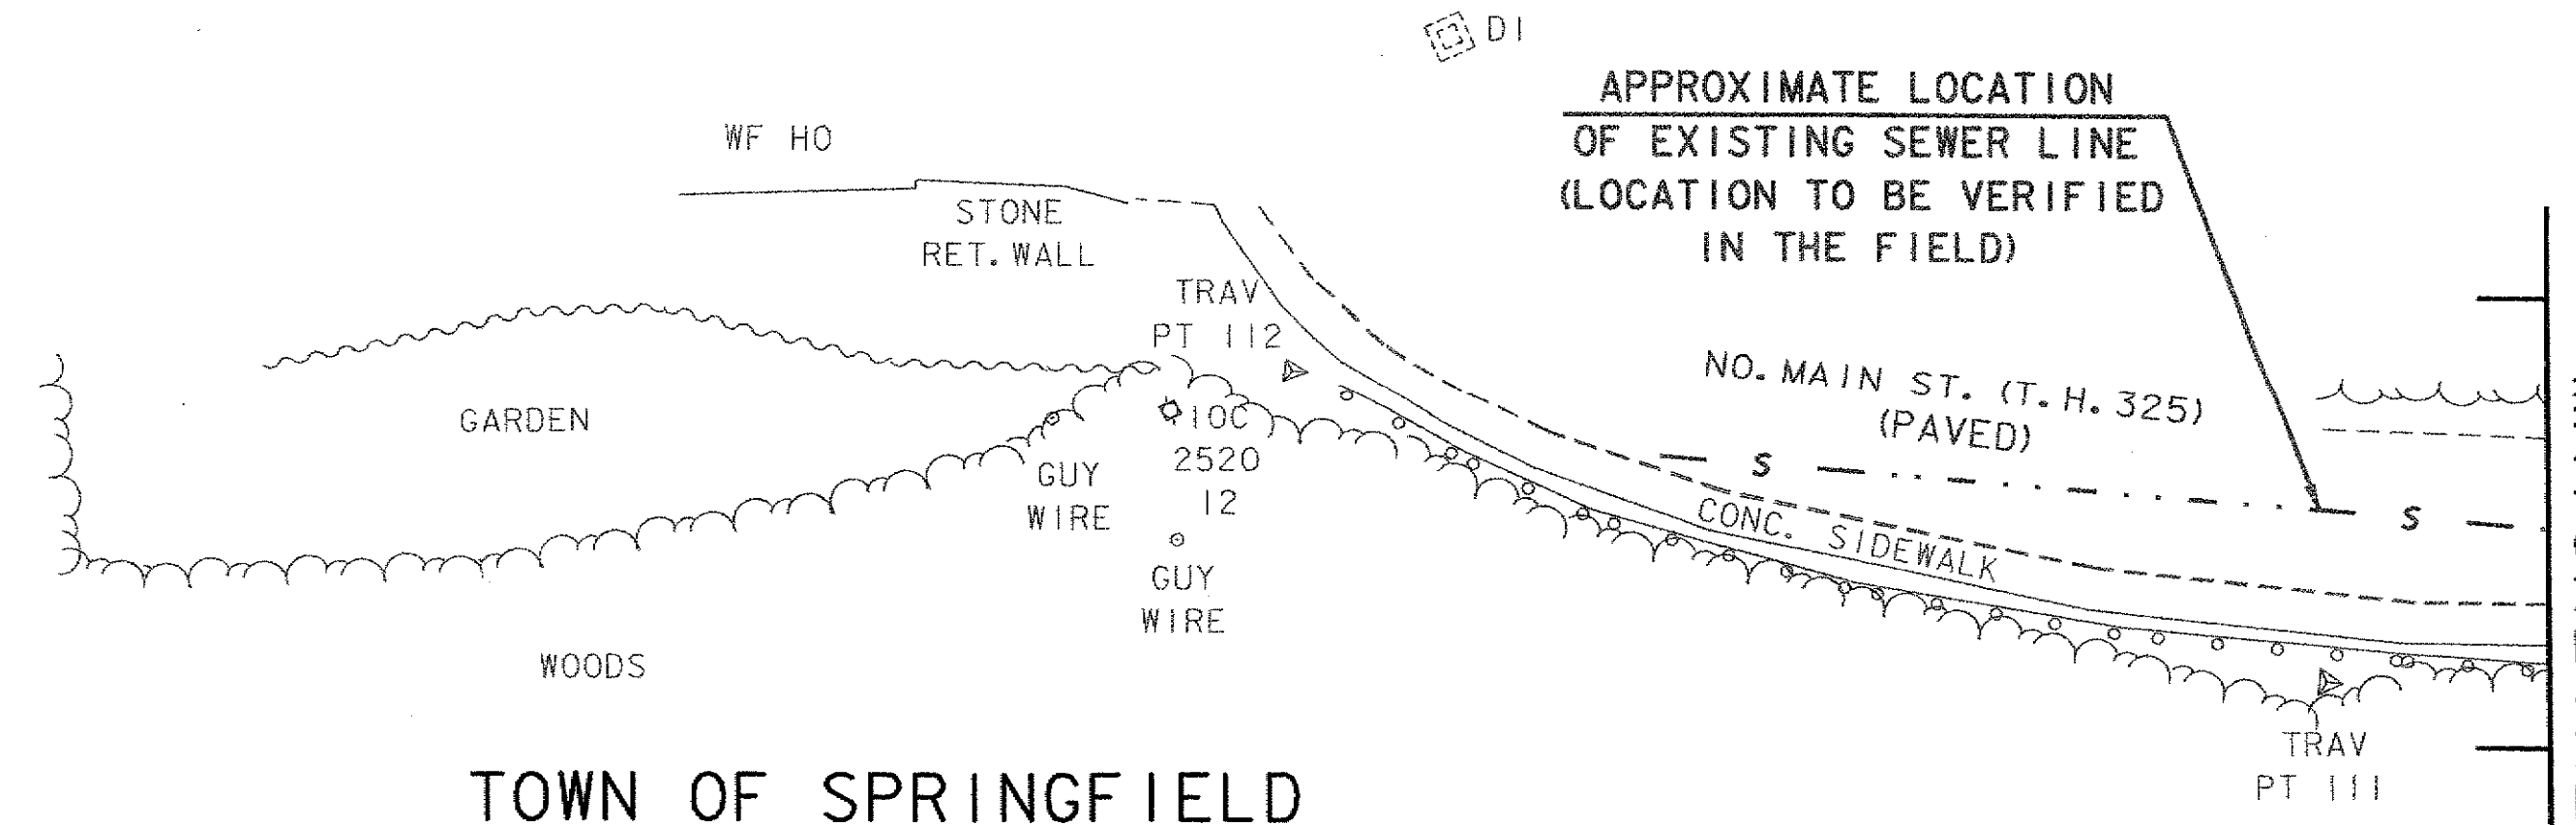


TOWN OF SPRINGFIELD

O' NEIL, FRANCES W.

TOWN OF SPRINGFIELD

O' NEIL, FRANCES W.

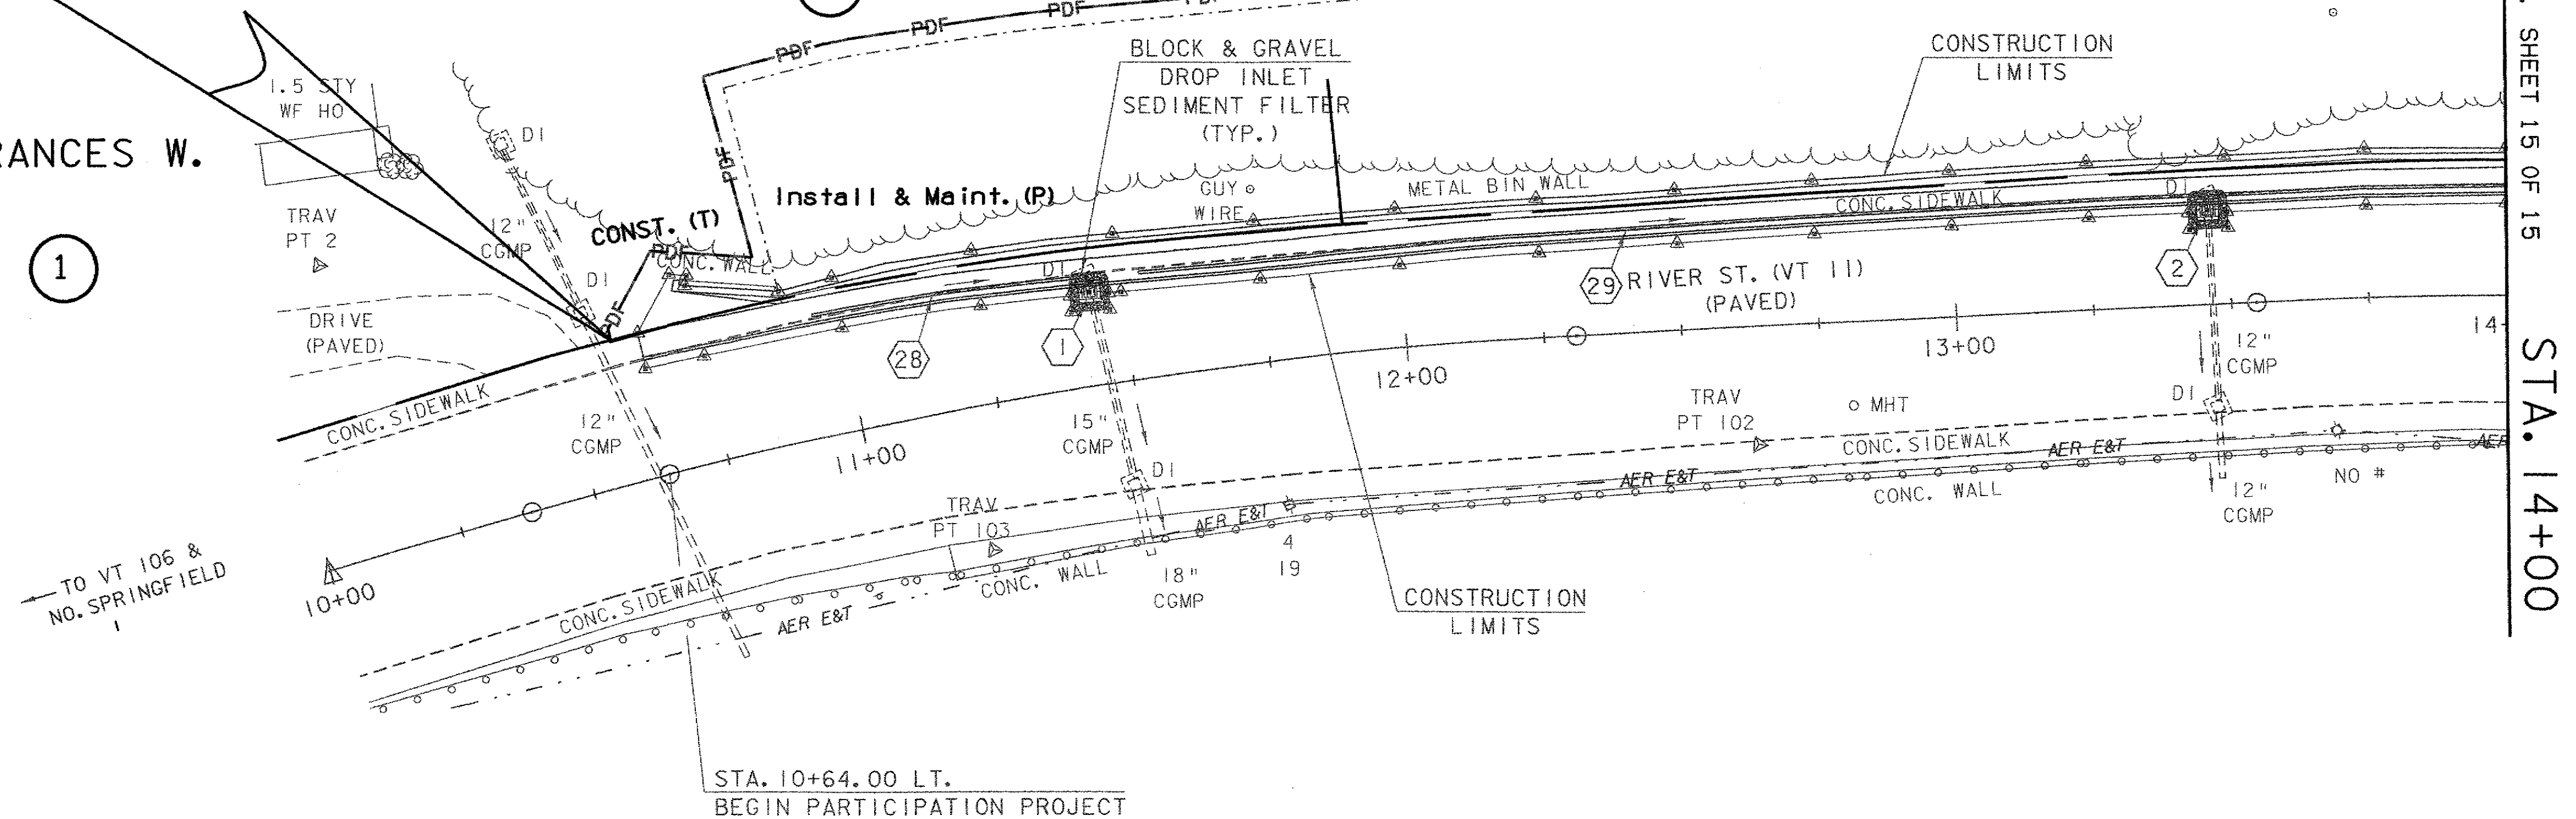

THIS SHEET IS FOR
R.O.W. PURPOSES ONLY.

FOR DRAINAGE DETAILS:
SEE R.O.W. SHEET 6,9,10,11 OF 15

FOR EROSION CONTROL DETAILS:
SEE R.O.W. SHEET 11 OF 15

LINES SHOWN ON THIS PLAN AS EXISTING
PROPERTY LINES P/L ARE BELIEVED TO
BE ACCURATE BUT SHOULD NOT BE RELIED
UPON FOR PURPOSES UNRELATED TO THE
TOWN OF SPRINGFIELD'S ACQUISITION OF LAND
AND RIGHTS FOR THIS PROJECT.

SEE DRAINAGE DETAIL SHEET
FOR DRAINAGE PIPE INFORMATION

NOTE:
UNDERGROUND UTILITIES ARE NOT SHOWN.

SCALE: 1" = 20'-0"
20 0 20

JUN 02 2004

LAYOUT SHEET (1)

PROJECT NAME:	SPRINGFIELD	PLOT DATE:	01-JUN-2004
PROJECT NUMBER:	STP 016-2 (10) S	DRAWN BY:	G. ROY
FILE NAME:	00b124\Structures\sbl24101	CHECKED BY:	
PROJECT MANAGER:	R. WHITCOMB		
DESIGNED BY:	G. ROY		
		SHEET 7 OF 72 SHEETS	