


NOTES:

1. THESE PLANS SHOW A CONCEPTUAL EROSION CONTROL PLAN, THE CONTRACTOR MUST SUBMIT A TEMPORARY EROSION CONTROL PLAN FOR APPROVAL.
2. TEMPORARY EROSION CONTROL MEASURES ARE CONCEPTUALLY SHOWN. THE CONTRACTOR MAY RELOCATE TEMPORARY MEASURES TO IMPROVE EROSION CONTROL WITH APPROVAL OF THE RESIDENT ENGINEER AND ON-SITE COORDINATOR. SILT FENCE SHALL NOT BE INSTALLED ACROSS CONTOURS.
3. THE CONTRACTOR SHALL USE OTHER EROSION CONTROL MEASURES AS NECESSITATED BY THE SEQUENCE OF CONSTRUCTION OR AS DIRECTED BY THE RESIDENT ENGINEER AND ON-SITE COORDINATOR.
4. REFER TO EROSION CONTROL DETAIL SHEETS FOR ADDITIONAL DETAILS.

BARRIER FENCE
VT 100 STA 260+56.7 - 261+95.3 RT

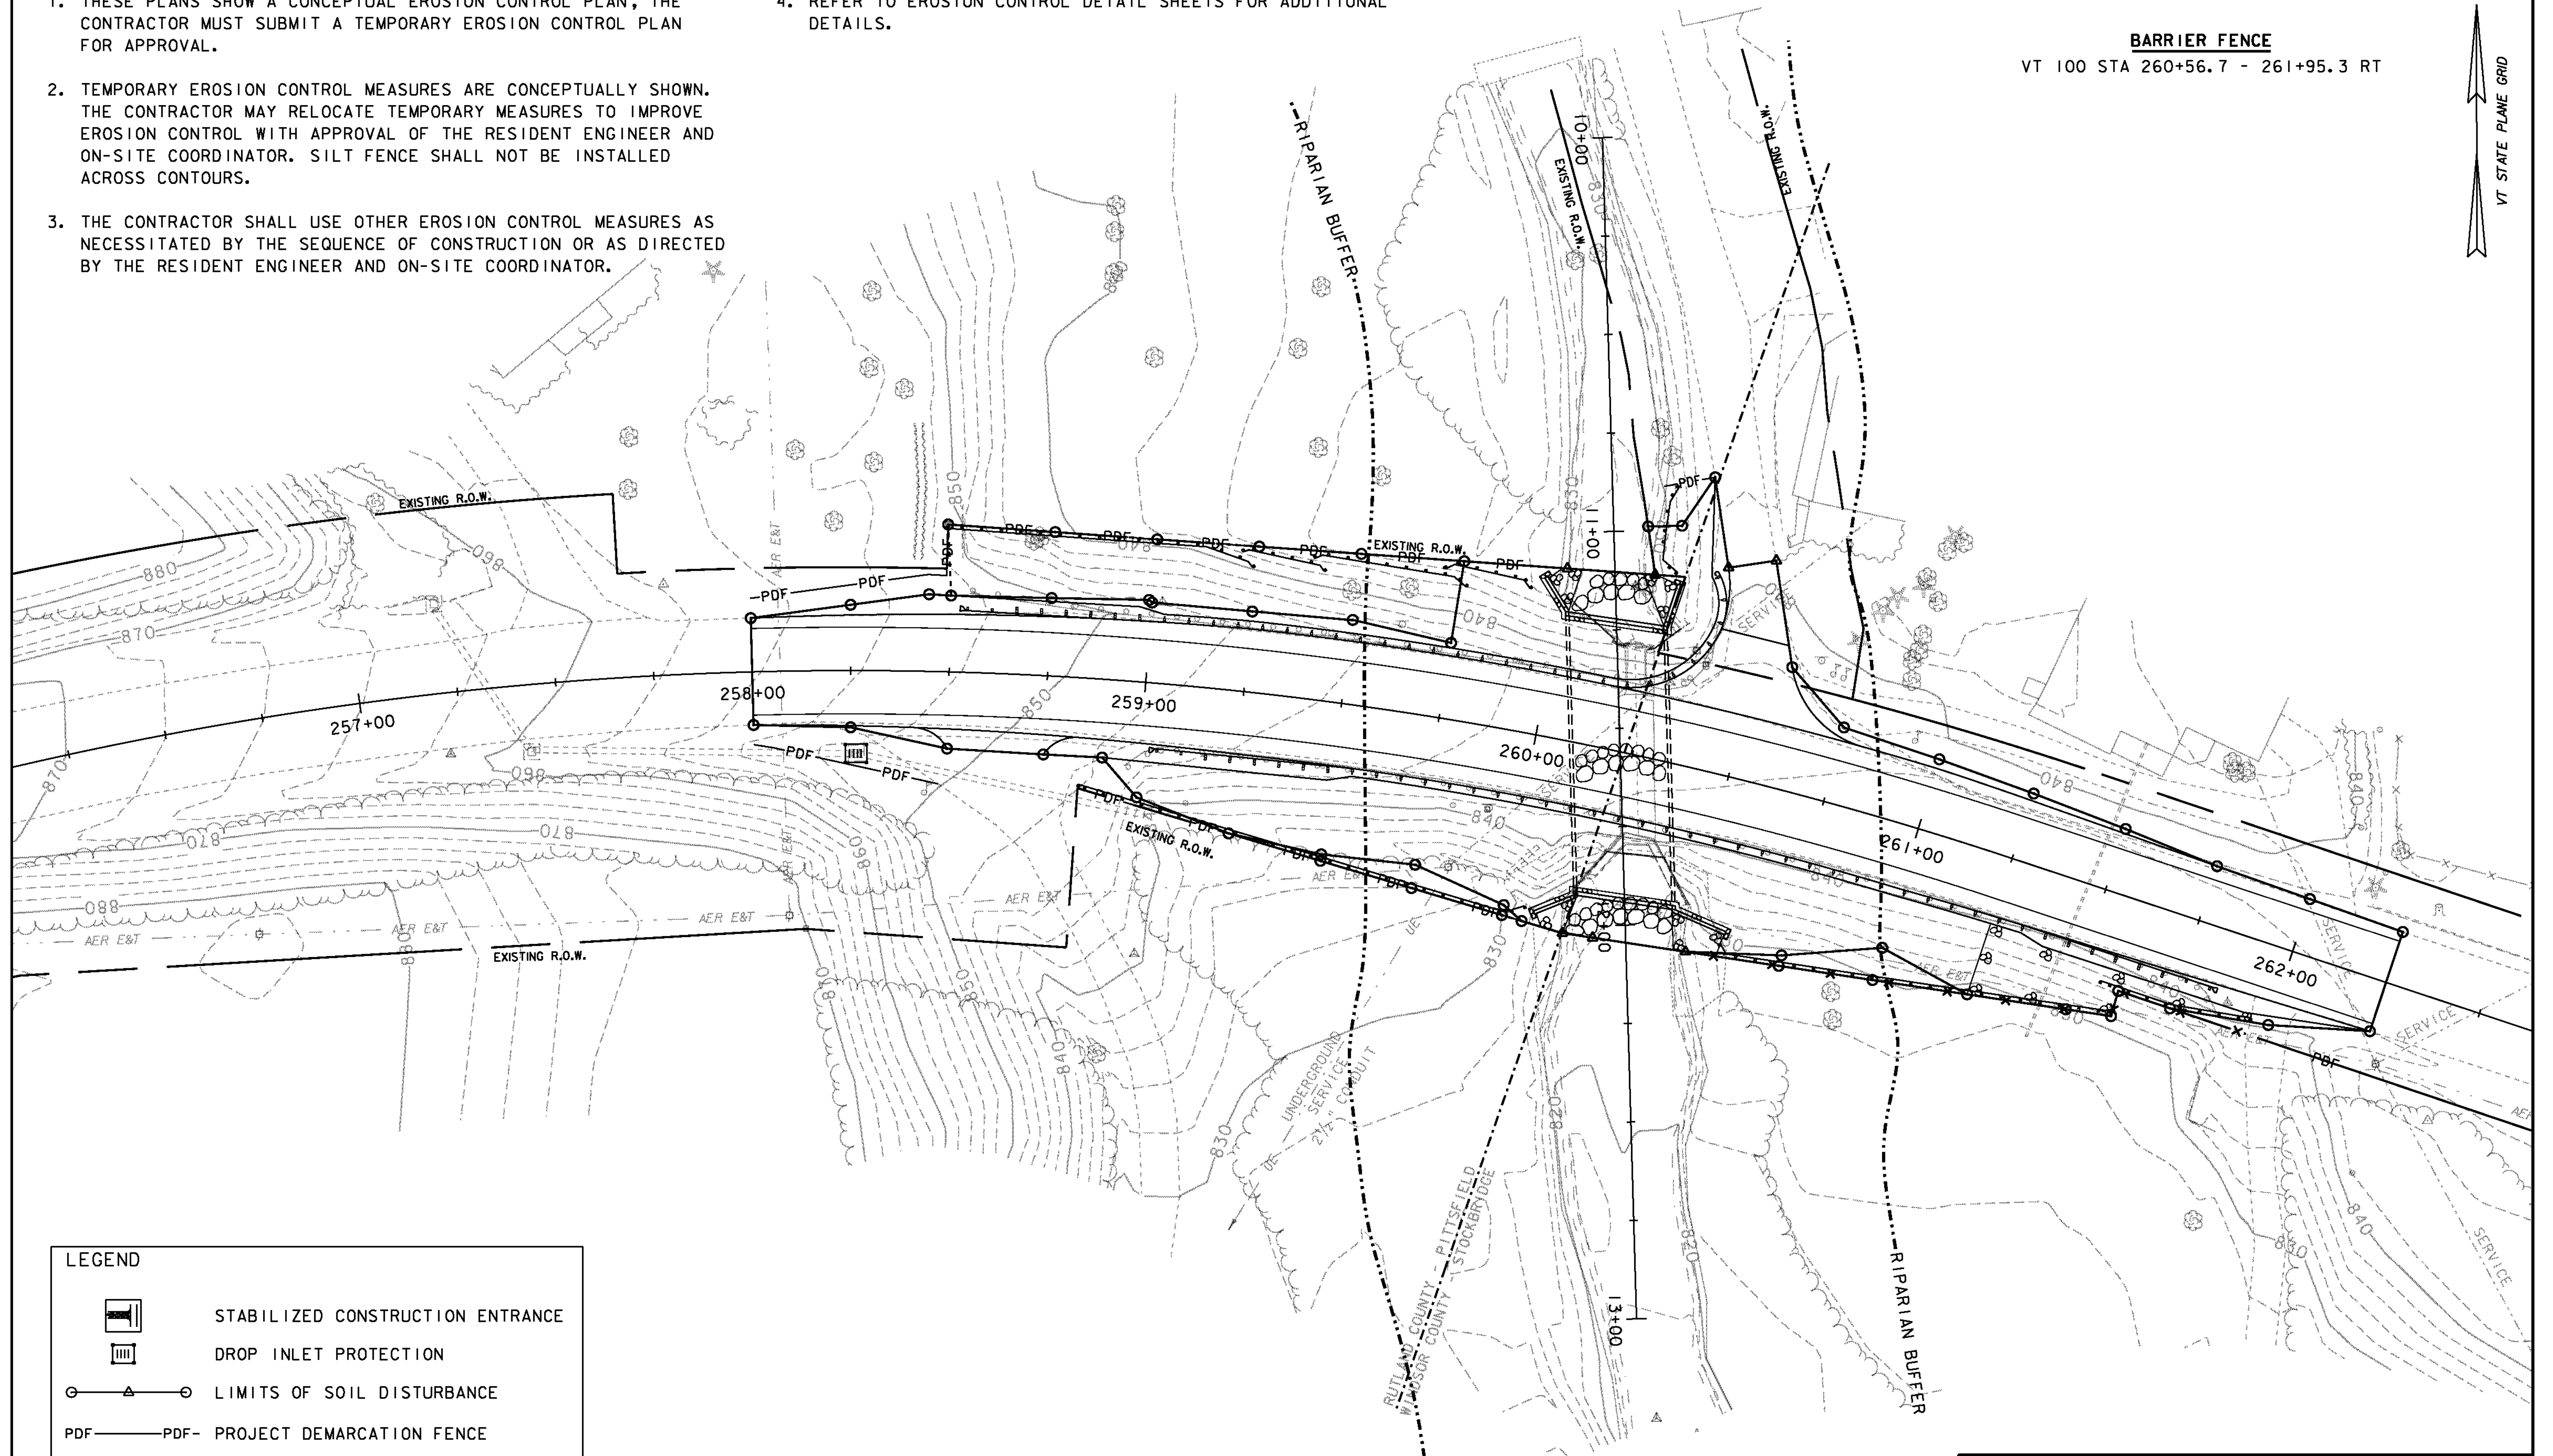

LEGEND

- STABILIZED CONSTRUCTION ENTRANCE
- DROP INLET PROTECTION
- LIMITS OF SOIL DISTURBANCE
- PDF- PDF- PROJECT DEMARCATION FENCE
- BARRIER FENCE
- RIPARIAN BUFFER ZONE
- SILT FENCE

20 0 20
SCALE: 1" = 20'-0"

PROJECT NAME:	PITTSFIELD-STOCKBRIDGE	PLOT DATE:	02-SEP-2011
PROJECT NUMBER:	STP 022-1(22)S	DRAWN BY:	G. ROY
FILE NAME:	s00b122bdr_ero.dgn	CHECKED BY:	R. YOUNG
PROJECT LEADER:	C. P. WILLIAMS	SHEET	29 OF 41
DESIGNED BY:	G. ROY		
EPSC CONSTRUCTION SITE PLAN			