
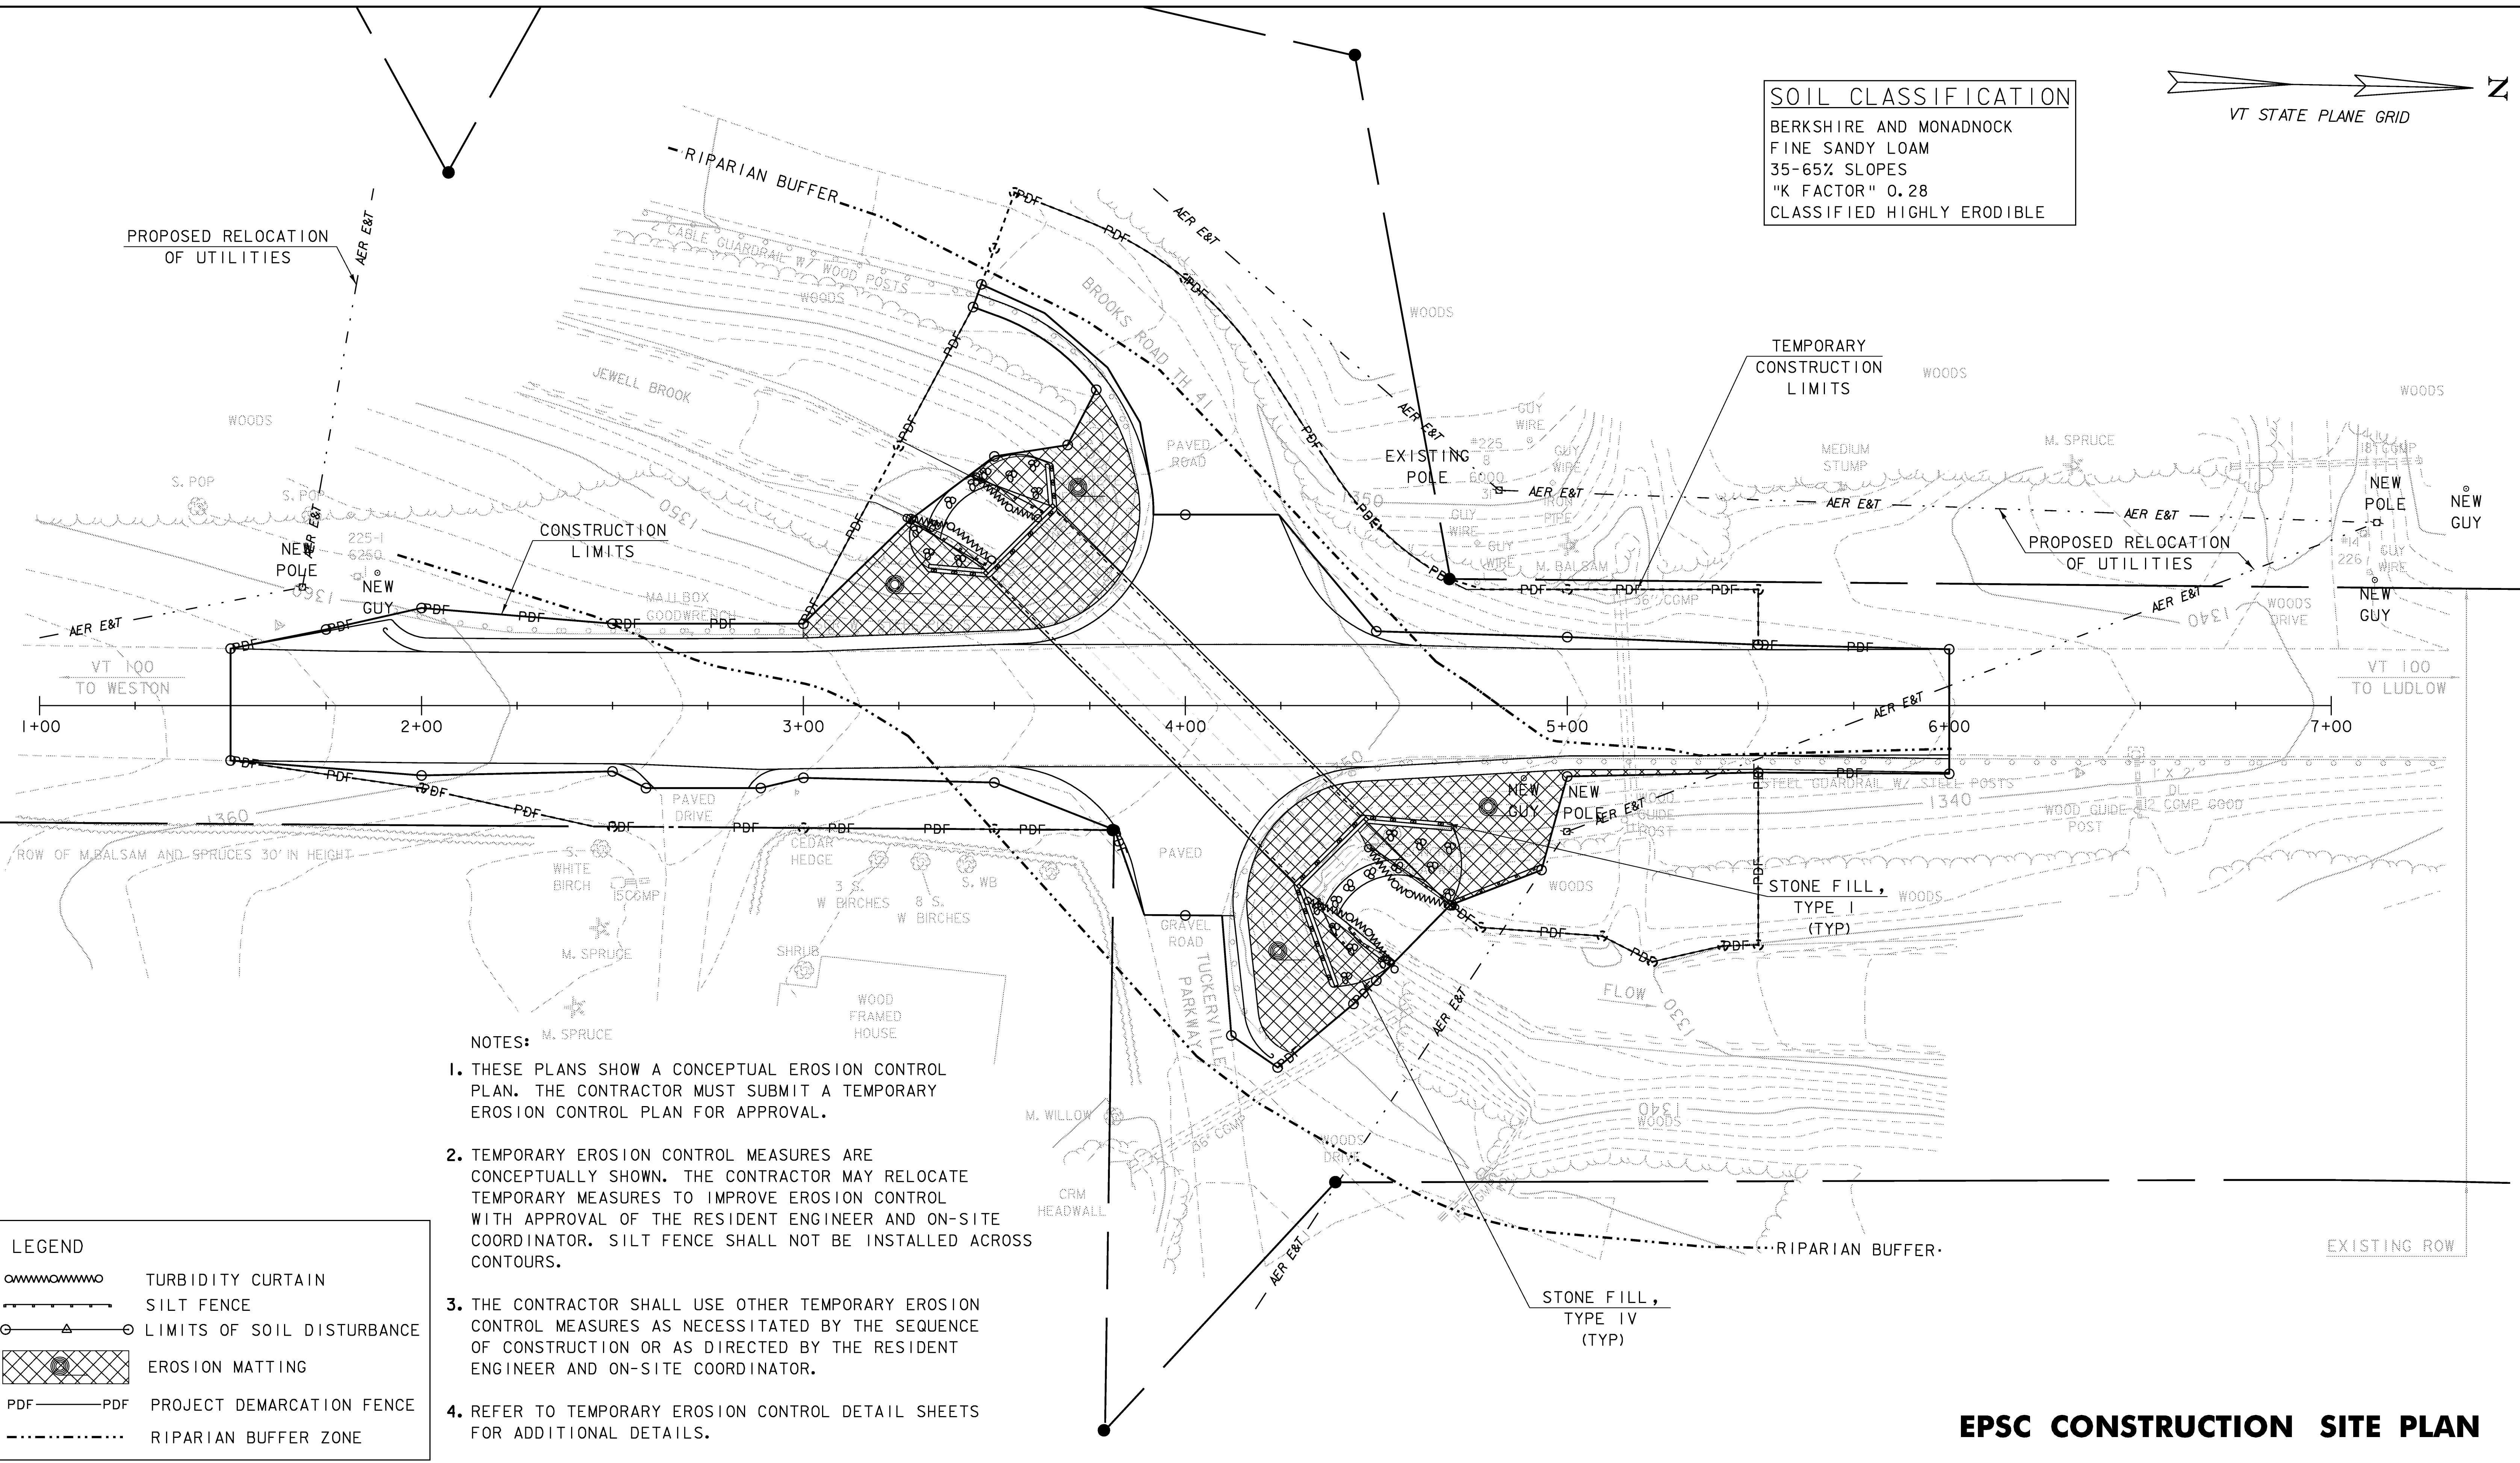


**SOIL CLASSIFICATION**  
 BERKSHIRE AND MONADNOCK  
 FINE SANDY LOAM  
 35-65% SLOPES  
 "K FACTOR" 0.28  
 CLASSIFIED HIGHLY ERODIBLE

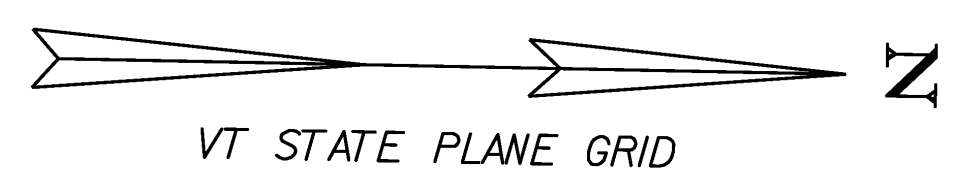

- NOTES:**
1. THESE PLANS SHOW A CONCEPTUAL EROSION CONTROL PLAN. THE CONTRACTOR MUST SUBMIT A TEMPORARY EROSION CONTROL PLAN FOR APPROVAL.
  2. TEMPORARY EROSION CONTROL MEASURES ARE CONCEPTUALLY SHOWN. THE CONTRACTOR MAY RELOCATE TEMPORARY MEASURES TO IMPROVE EROSION CONTROL WITH APPROVAL OF THE RESIDENT ENGINEER AND ON-SITE COORDINATOR. SILT FENCE SHALL NOT BE INSTALLED ACROSS CONTOURS.
  3. THE CONTRACTOR SHALL USE OTHER TEMPORARY EROSION CONTROL MEASURES AS NECESSITATED BY THE SEQUENCE OF CONSTRUCTION OR AS DIRECTED BY THE RESIDENT ENGINEER AND ON-SITE COORDINATOR.
  4. REFER TO TEMPORARY EROSION CONTROL DETAIL SHEETS FOR ADDITIONAL DETAILS.
  5. WHERE LEDGE OR ROCK IS EXPOSED, GRAVEL BAGS MAY BE USED INSTEAD OF TURBIDITY CURTAIN. PAYMENT FOR THIS ITEM SHALL BE INCIDENTAL TO ITEM 649.61 "GEOTEXTILE FOR FILTER CURTAIN".

**LEGEND**

	TURBIDITY CURTAIN
	SILT FENCE
	LIMITS OF SOIL DISTURBANCE
	EROSION MATTING
	PROJECT DEMARCATION FENCE
	RIPARIAN BUFFER ZONE

**DATUM**  
 VERTICAL NAVD 88  
 HORIZONTAL NAD 83 (96)

SCALE 1" = 20' -0  
 20 0 20

**EPSC CONSTRUCTION SITE PLAN**

PROJECT: <b>LUDLOW</b>	PROJECT NO.: <b>STP ST CULV (7)</b>
DESIGN FILE NAME: 00b258\structures\s00b258bdr_ero.dgn	PLOT DATE: 11-SEP-2008
IPARM FILE NAME: s00b258erop1n.1	SURVEY DATE: 12/2000
SURVEYED BY: R. GILMAN	DRAWN BY: D. D. BEARD
SQUAD LEADER: C. P. WILLIAMS	SHEET: 25 OF 34
EPSC CONSTRUCTION SITE PLAN	