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(SHEET NO. 20 OF CROSS SECTIONS OMITTED)


STATE OF VERMONT
STATE HIGHWAY DEPARTMENT

PLAN AND PROFILE OF PROPOSED
STATE HIGHWAY
EMERGENCY RELIEF PROJECT

TOWN OF WILMINGTON Pin# 99R802

BRATTLEBORO-WILMINGTON ROAD
BEGINNING AT A POINT 2730 FEET NORTHWESTERLY
FROM THE INTERSECTION OF STATE ROUTE NO. 8
WITH STATE ROUTE NO. 9. THENCE EXTENDING
WESTERLY A DISTANCE OF 477.7 FEET.


LENGTH OF BRIDGE 84.0 FT.= 0.016 MI.
LENGTH OF APPROACH 393.7 FT.= 0.074 MI.
TOTAL LENGTH OF PROJECT 477.7 FT.= 0.090 MI.

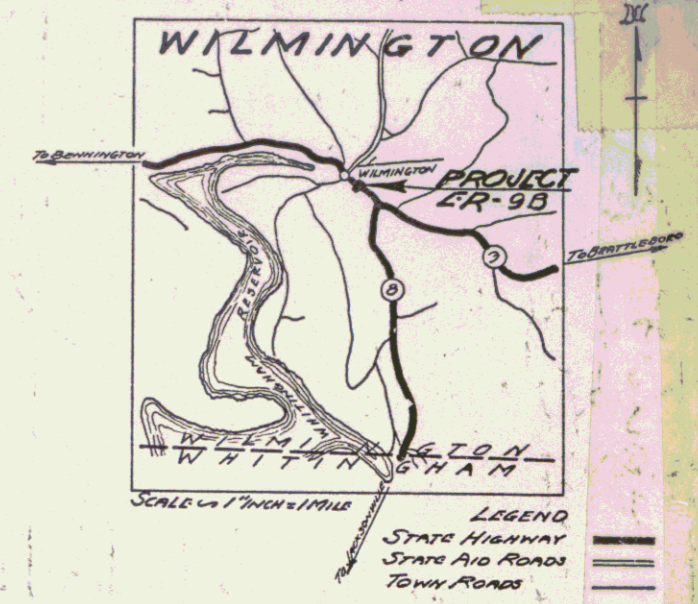

Standard Structure Sheets
Approved by the Chief Engineer
5-28 July 11, 1933
5-30 August 13, 1934
5-31 July 23, 1934

(To Be Returned To R.O.W. Division)
Town of VT9
M.P. 343-354
RIGHT-OF-WAY DIVISION
TOWN FILE

These plans are subject to such revisions as may be required by the Bureau of Public Roads or the Commission of Highways.
CONSTRUCTION IS TO BE CARRIED ON IN ACCORDANCE WITH THE PLANS AND STANDARD ROAD AND BRIDGE SPECIFICATIONS OF 1936 AS AMENDED DECEMBER 29, 1936 BY THE BUREAU OF PUBLIC ROADS INCLUDING ALL SUBSEQUENT SUCH REVISED SPECIFICATIONS AS ARE SUBMITTED.

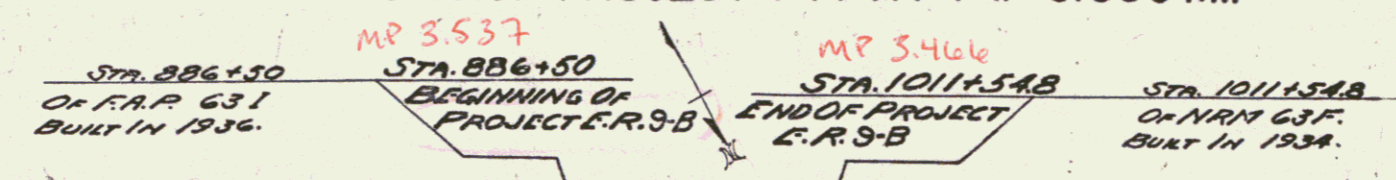

RIGHT-OF-WAY DIVISION
TOWN FILE
PERPETUAL
Town of VT9
(To Be Returned To R.O.W. Division)

APPROVED: Nov. 21, 1938
H. E. J. [Signature]
COMMISSIONER OF HIGHWAYS
SUBMITTED BY ORDER OF THE STATE HIGHWAY BOARD

YEAR 1938
Location: Brattleboro-Wilmington Road, beginning at a point 2730 feet northwesterly from the intersection of State Route No. 8 with State Route No. 9, thence westerly a distance of 477.7 feet.
Number: R. R. 9-B
Type: Concrete Floor
Contractor: Home Construction Co.
Length: 0.090 mi.

CONVENTIONAL SIGNS

GROUND ELEVATION	DATUM	LINE
GRADE ELEVATION	DATUM	LINE

CURVE DATA

DEFLECTION ANGLE	Δ
DEGREE OF CURVE	D
RADIUS OF CURVE	R
TANGENT DISTANCE	T
LENGTH OF CURVE	L
EXTERNAL DISTANCE	E
POINT OF INTERSECTION	P. I.
POINT OF CURVE	P. C.
POINT OF TANGENT	P. T.
POINT ON TANGENT	P. O. T.

SCALES

TITLE SHEET	1" = 200'
TYPICAL SHEETS	1" = 2'
LAYOUTS PLAN	1" = 20'
PROFILE VIEW	1" = 10'
CROSS SECTIONS	1" = 5'

M.M. 345-0355

Route VT9
Date 11/10/1938

APPROVED: [Signature] DATE: 11/10/38
DISTRICT HIGHWAY COMMISSIONER

CORRECT: [Signature] DATE: 11/10/38
BRIDGE ENGINEER

RECOMMENDED FOR APPROVAL: [Signature]
CHIEF ENGINEER

APPROVED: [Signature]
DIRECTOR - BUREAU OF PUBLIC ROADS

SERIES ER No. 9-B FILED
SHEET 1 OF 23